
CANNING BEACH ROAD

65a+b Canning Beach Road, Applecross 6153

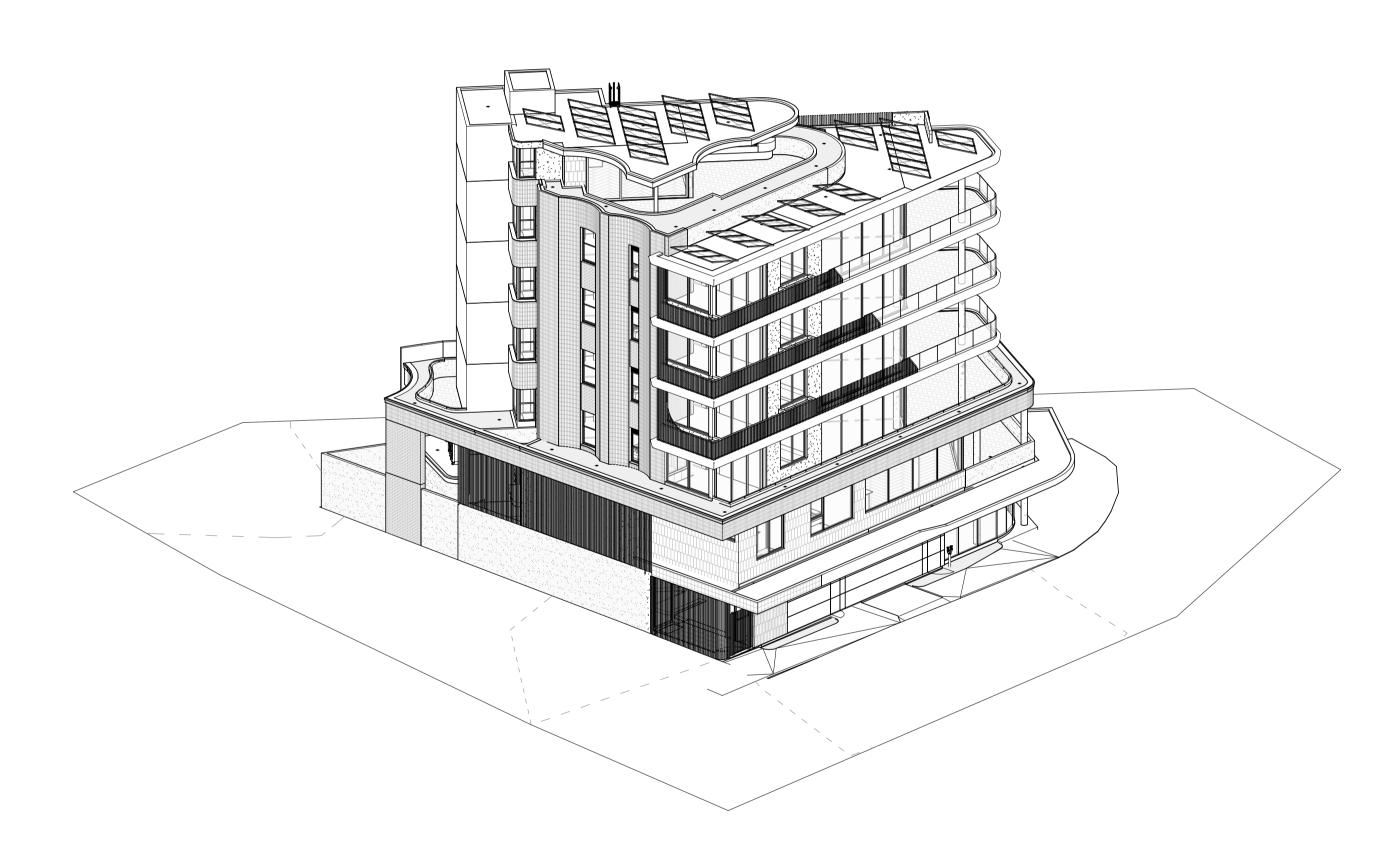

A0.01	Cover Page	A4.07	Cross Section J
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A1.02	Site Plan with Survey Overlay	A4.09	Cross Section L
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A2.02	Ground Floor General Arrangement Plan	A4.11	Cross Section N + O
A2.02a	Ground Floor Wall Type + Dimension Plan	A4.12	Cross Section P
A2.02b	Ground Floor Slab Setout Plan	A5.01	Ground Floor Ceiling Plan
A2.03	First Floor General Arrangement Plan	A5.02	First Floor Ceiling Plan
A2.03a	First Floor Wall Type + Dimension Plan	A5.03	Second Floor Ceiling Plan
A2.03b	First Floor Slab Setout Plan	A5.04	Third Floor Ceiling Plan
A2.04	Second Floor General Arrangement Plan	A5.05	Fourth Floor Ceiling plan
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A2.08	Roof Deck General Arrangement Plan	A6.22	Construction Details (Elevation) - Precast Wall
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A2.10	Wall Types Schedule	A7.10	Interiors - Apartment Type A - Private Lobby, Study, Corridor
A3.01	North/East Elevations	A7.11	Interiors - Apartment Type A - Wet Areas
A3.02	South/East Elevations	A7.12	Interiors Apartment Type A - Kitchen
A3.03	West Elevation	A7.21	Interiors - Apartment Type B - Kitchen, Laundry, Bar
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A4.01	Cross Section A + B	A7.31	Interiors - Roof Terrace
A4.02	Cross Section C + D	A8.01	Door Schedule
A4.03	Cross Section E + F	A8.02	Window Schedule 1
A4.04	Cross Section G	A8.03	Window Schedule 2
A4.05	Cross Section H	Grand total	l: 72
A4.06	Cross Section I		

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				MANUALLY SCALED OFF DRAWINGS.
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CANNING BEACH ROAD
LOT 1 65a+b CANNING BEACH ROAD
APPLECROSS 6153

Cover Page

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CLIENT P

IFC PROGRESS DOCUMENTATION

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CLIENT PROJECT
No.

GRF19


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- DIMENSIONS.
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- SEEK CLARIFICATION FROM SUPERINTENDENT FOR ANY DISCREPANCIES.

 ALL EXTERNAL FLOOR SURFACES TO FALL AWAY FROM BUILDING.

 REFER INTERIOR DOCUMENTATION FOR SETOUTS AND EXACT LOCATIONS OF CABINETRY, FITTINGS, FIXTURES, PLUMBING, FLOOR WASTES AND TILING.

 ALL MATERIALS SHALL BE NEW & COMFORM TO WHAT IS SHOWN ON THE DRAWINGS AND IN THE SCHEDULES.

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 ALL WINDOW DIMENSIONS ARE NOMINAL AND ARE TO BE MEASURED ON SITE.
- MEASURED ON SITE.
 THE CONTRACTOR SHALL VISIT THE SITE & NOTE ALL SITE CONDITIONS & ACCESS REQUIREMENTS.
 REFER TO WALL TYPES PLANS FOR WALL SETOUTS.
 REFER SLAB SETOUT PLANS FOR SLAB AND STRUCTURAL
- REFER SLAB SETOUT PLANS FOR SLAB AND STRUCTURAL COLUMN SETOUTS.
 ENSURE ALL STRUCTURAL STEEL COLUMNS WITHIN 3m OF SITE BOUNDARY TO BE FIRE PROTECTED TO CODES AND STANDARDS. INSTALL FLASHINGS, EDGE TRIMS AND APPROPRIATE SEASL AS REQUIRED TO ACHIEVE WEATHER TIGHTNESS. FINISH TO BE SAME AS ADJACENT MATERIAL U.N.O. BUILDING TAG

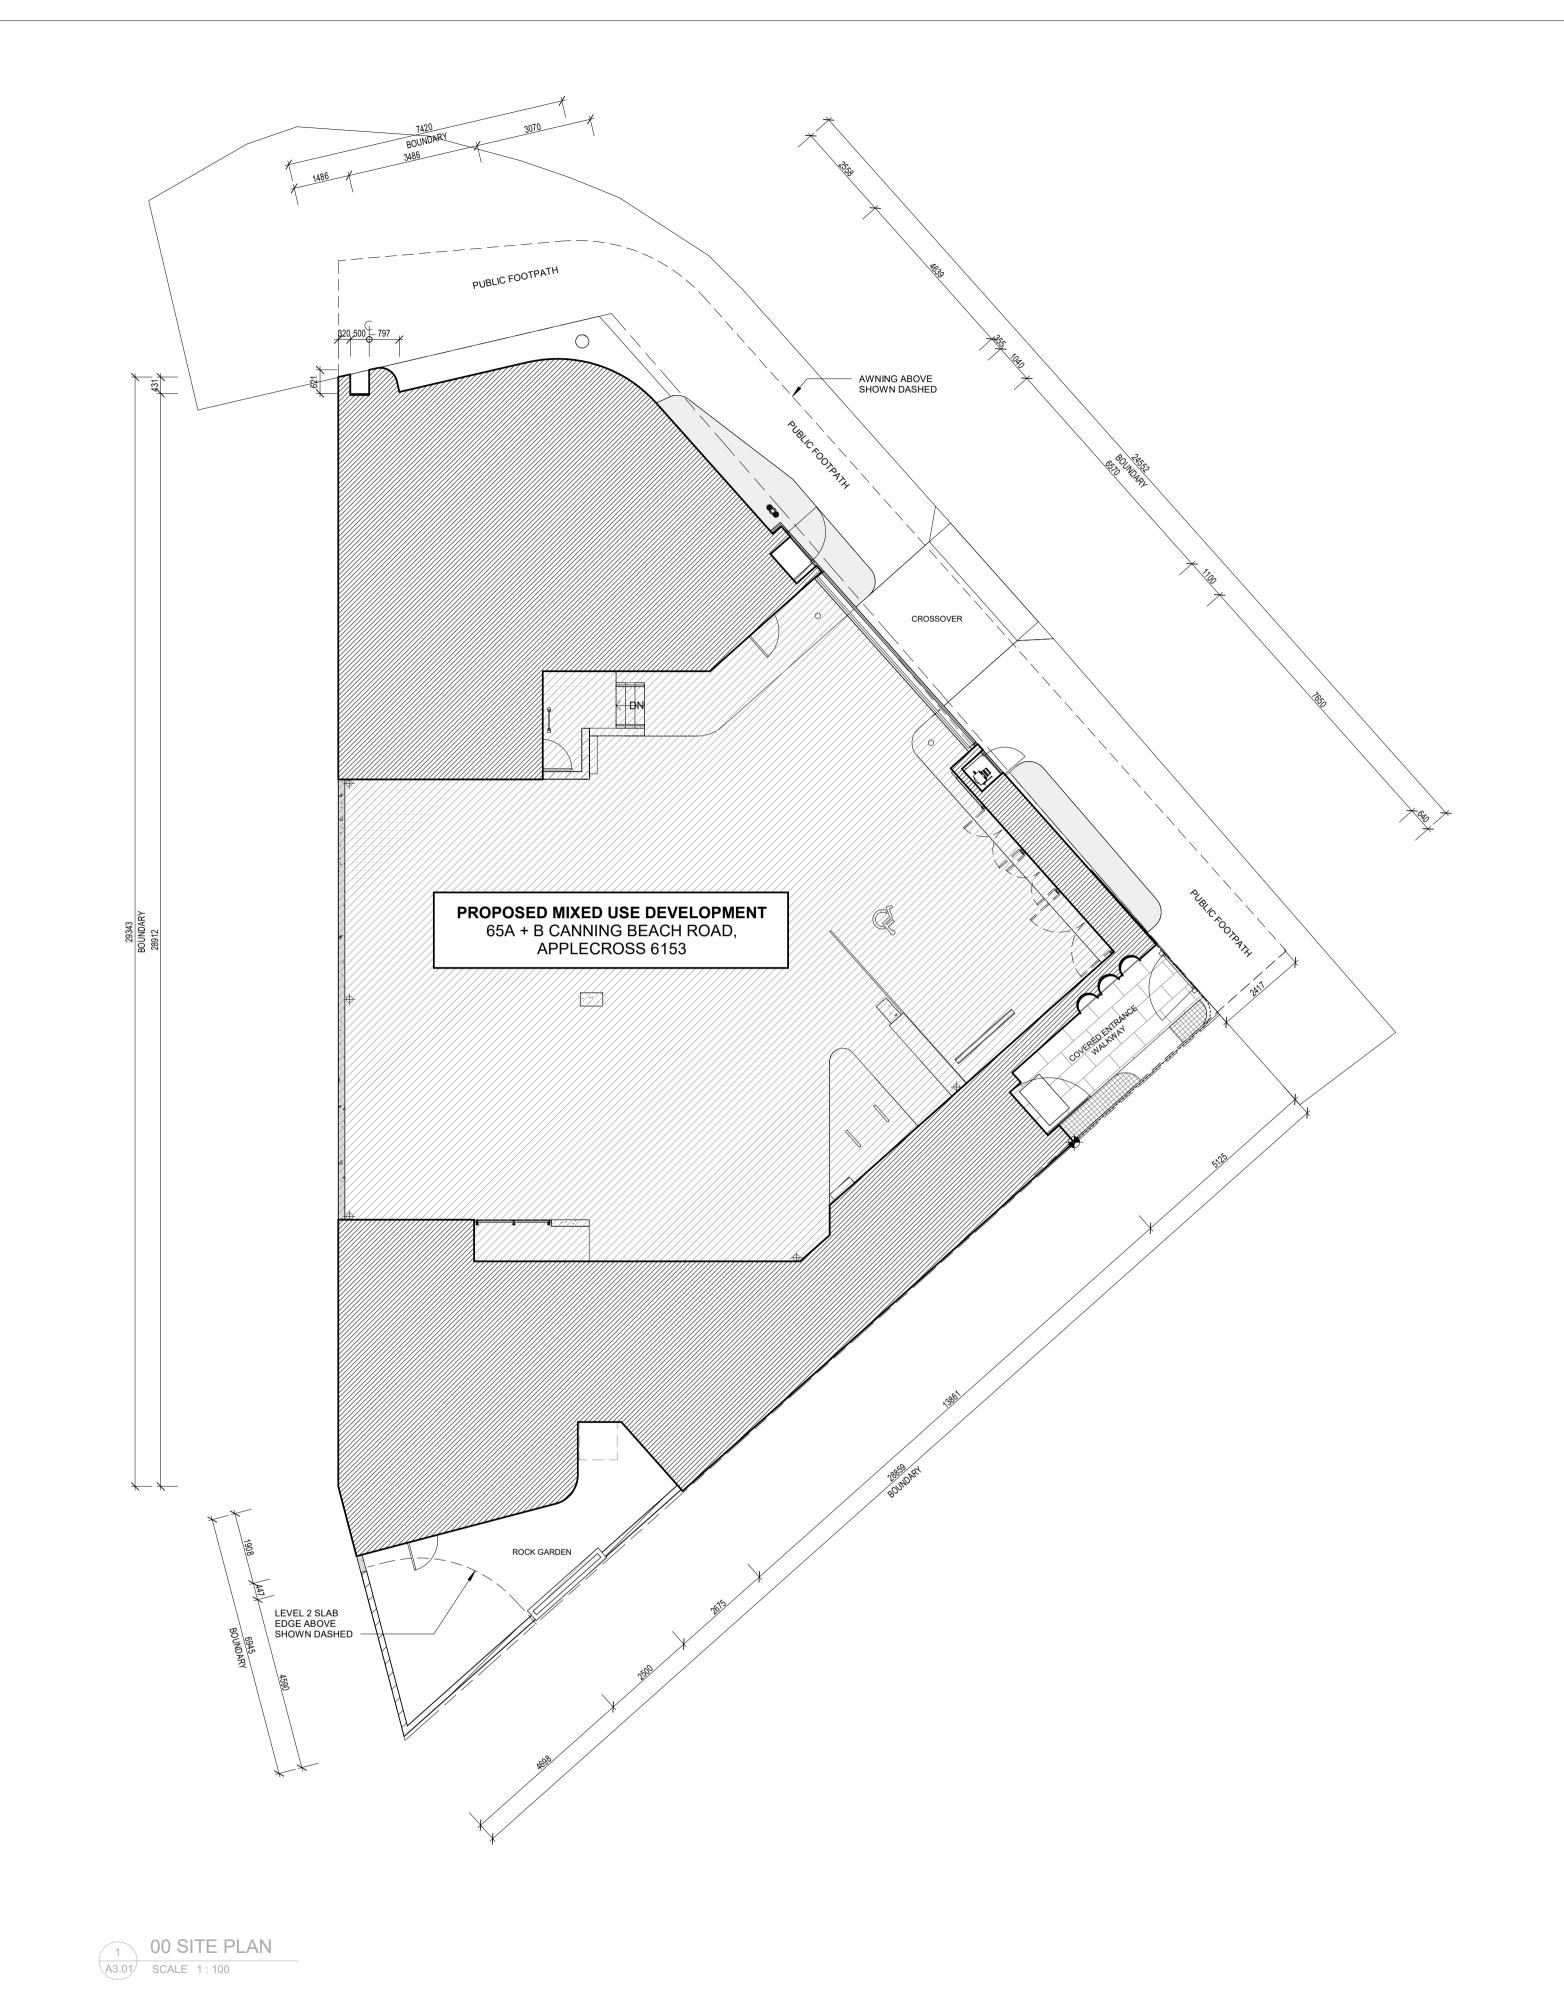REFER MASTER MATERIALS SCHEDULE FOR THE FOLLOWING AND MORE:
16.1 STRUCTURE SURFACE FINISHES 16.4 FINISHES
16.2 FIXTURES & FITTINGS 16.5 APPLIANCES
16.3 WATERPROOFING SYSTEMS 16.6 TRIMS

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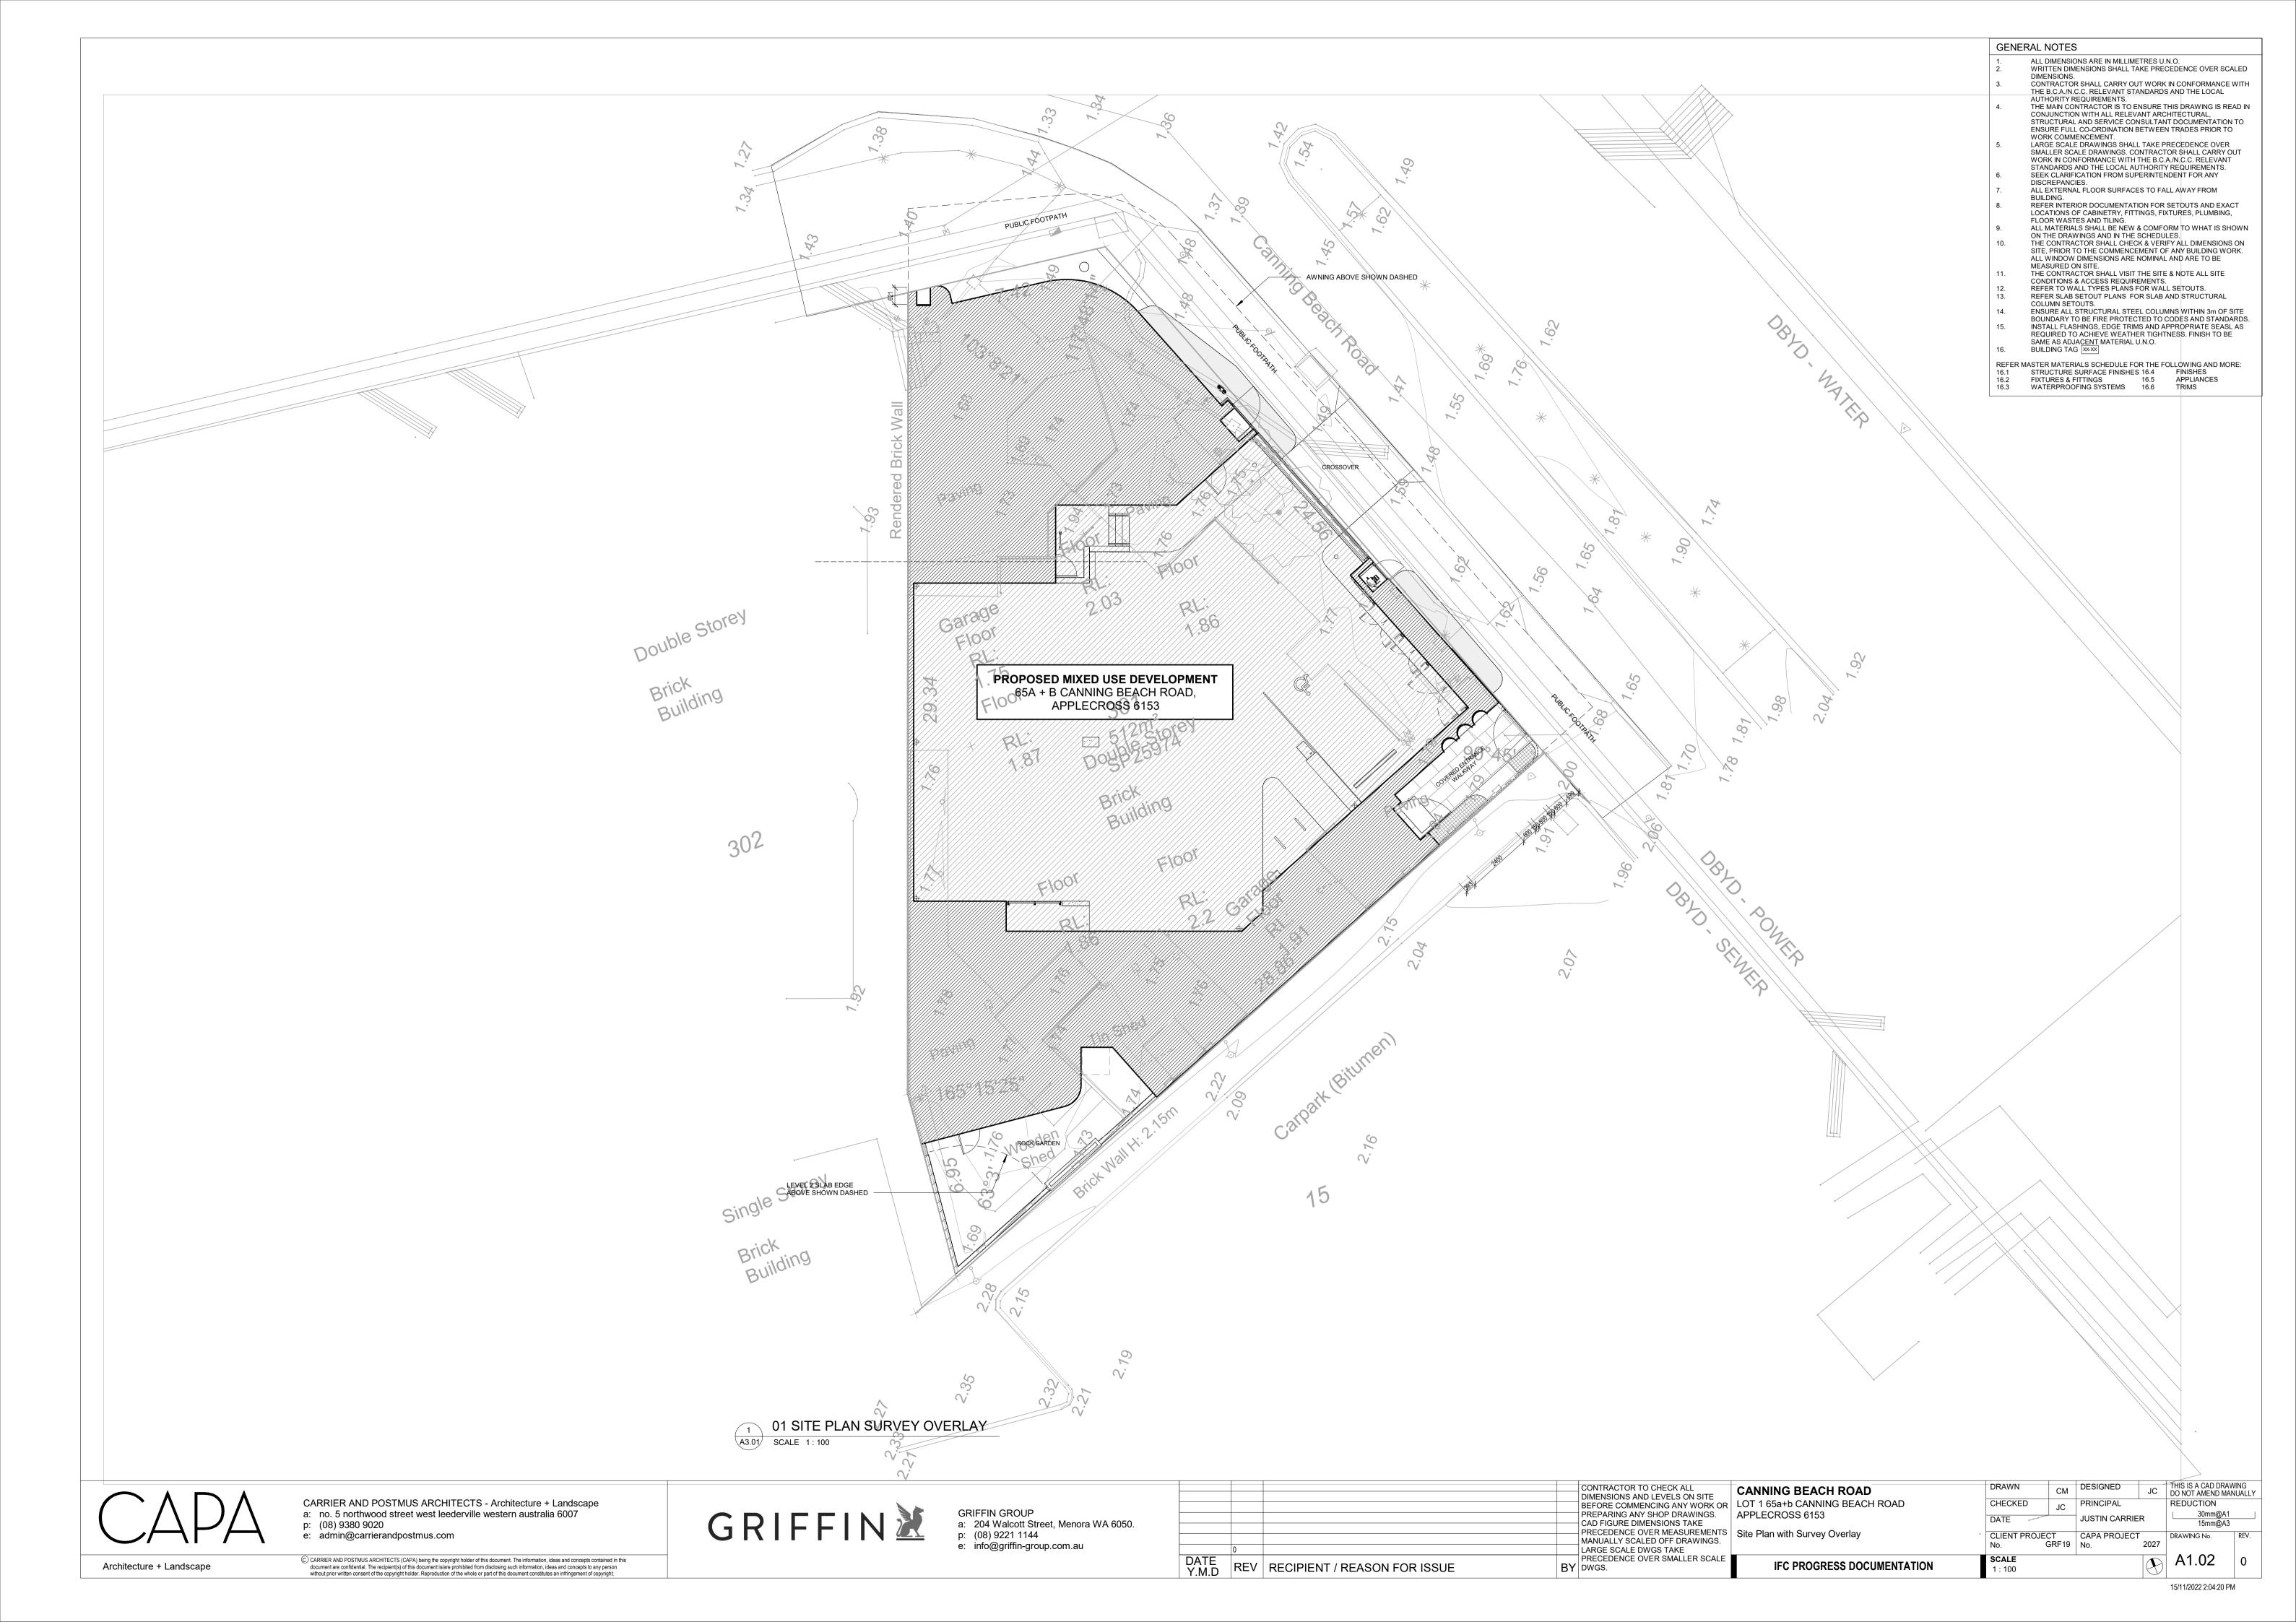
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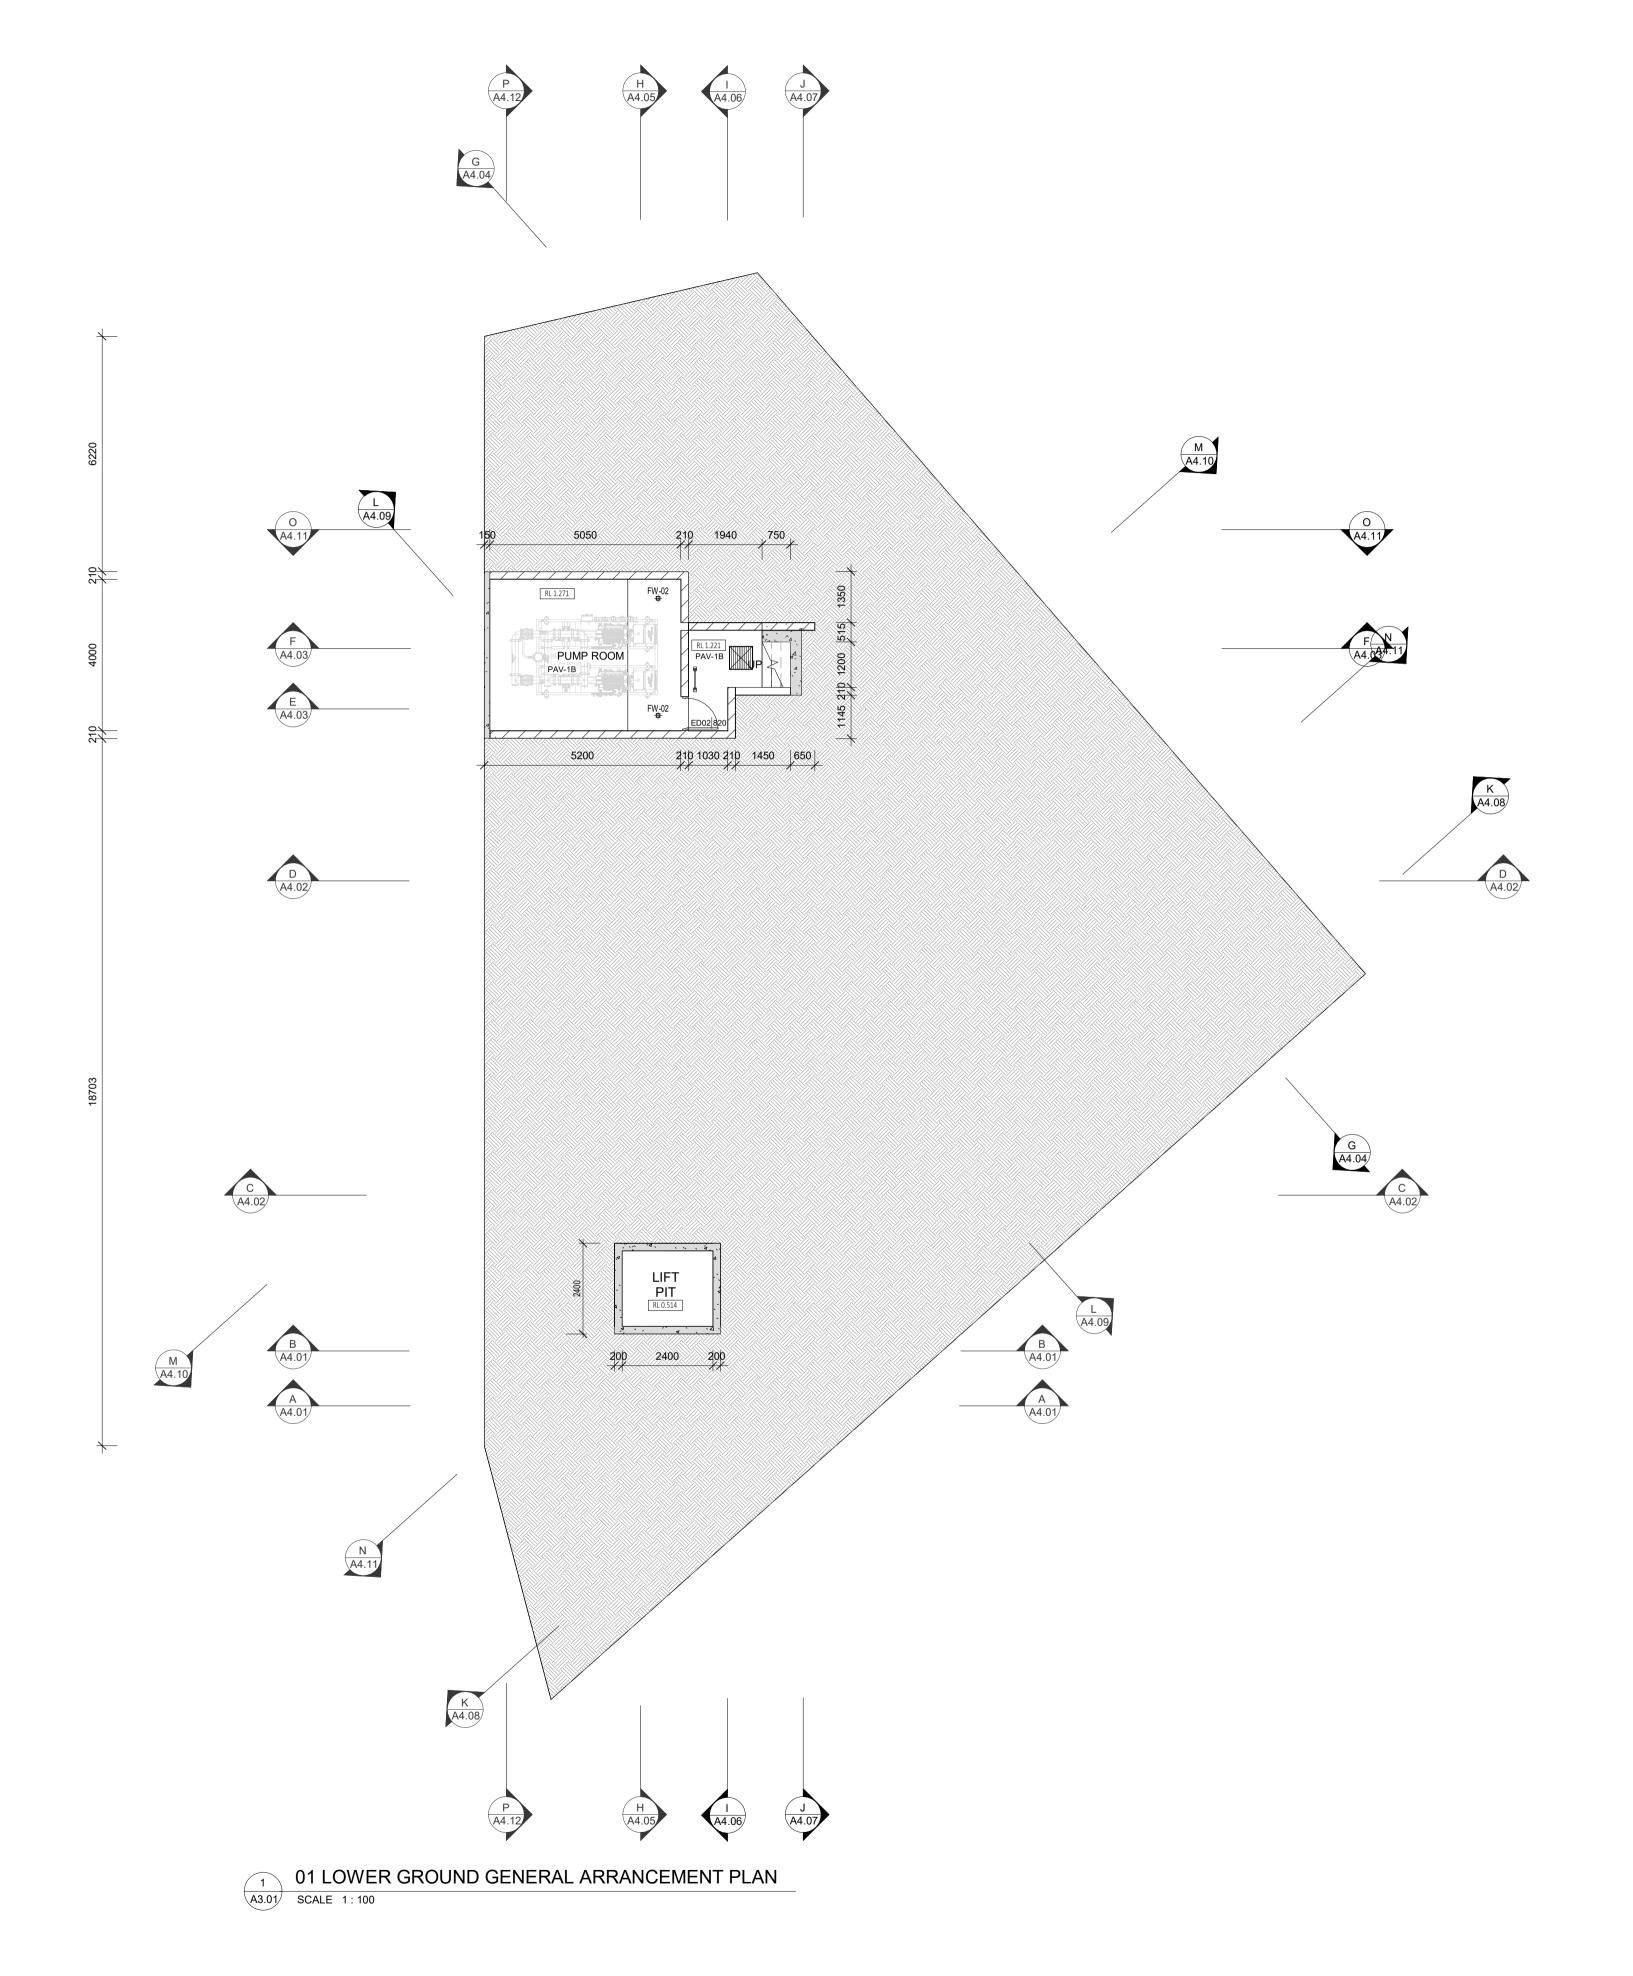


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DATE Y.M.D	REV	RECIPIENT / REASON FOR ISSUE	BY	PRECEDENCE OVER SMALLER SCALE DWGS.

OR	CANNING BEACH ROAD LOT 1 65a+b CANNING BEACH ROAD APPLECROSS 6153
TS S.	Site Plan





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DWGS.

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APPLECROSS 6153


Lower Ground General Arrangement Plan

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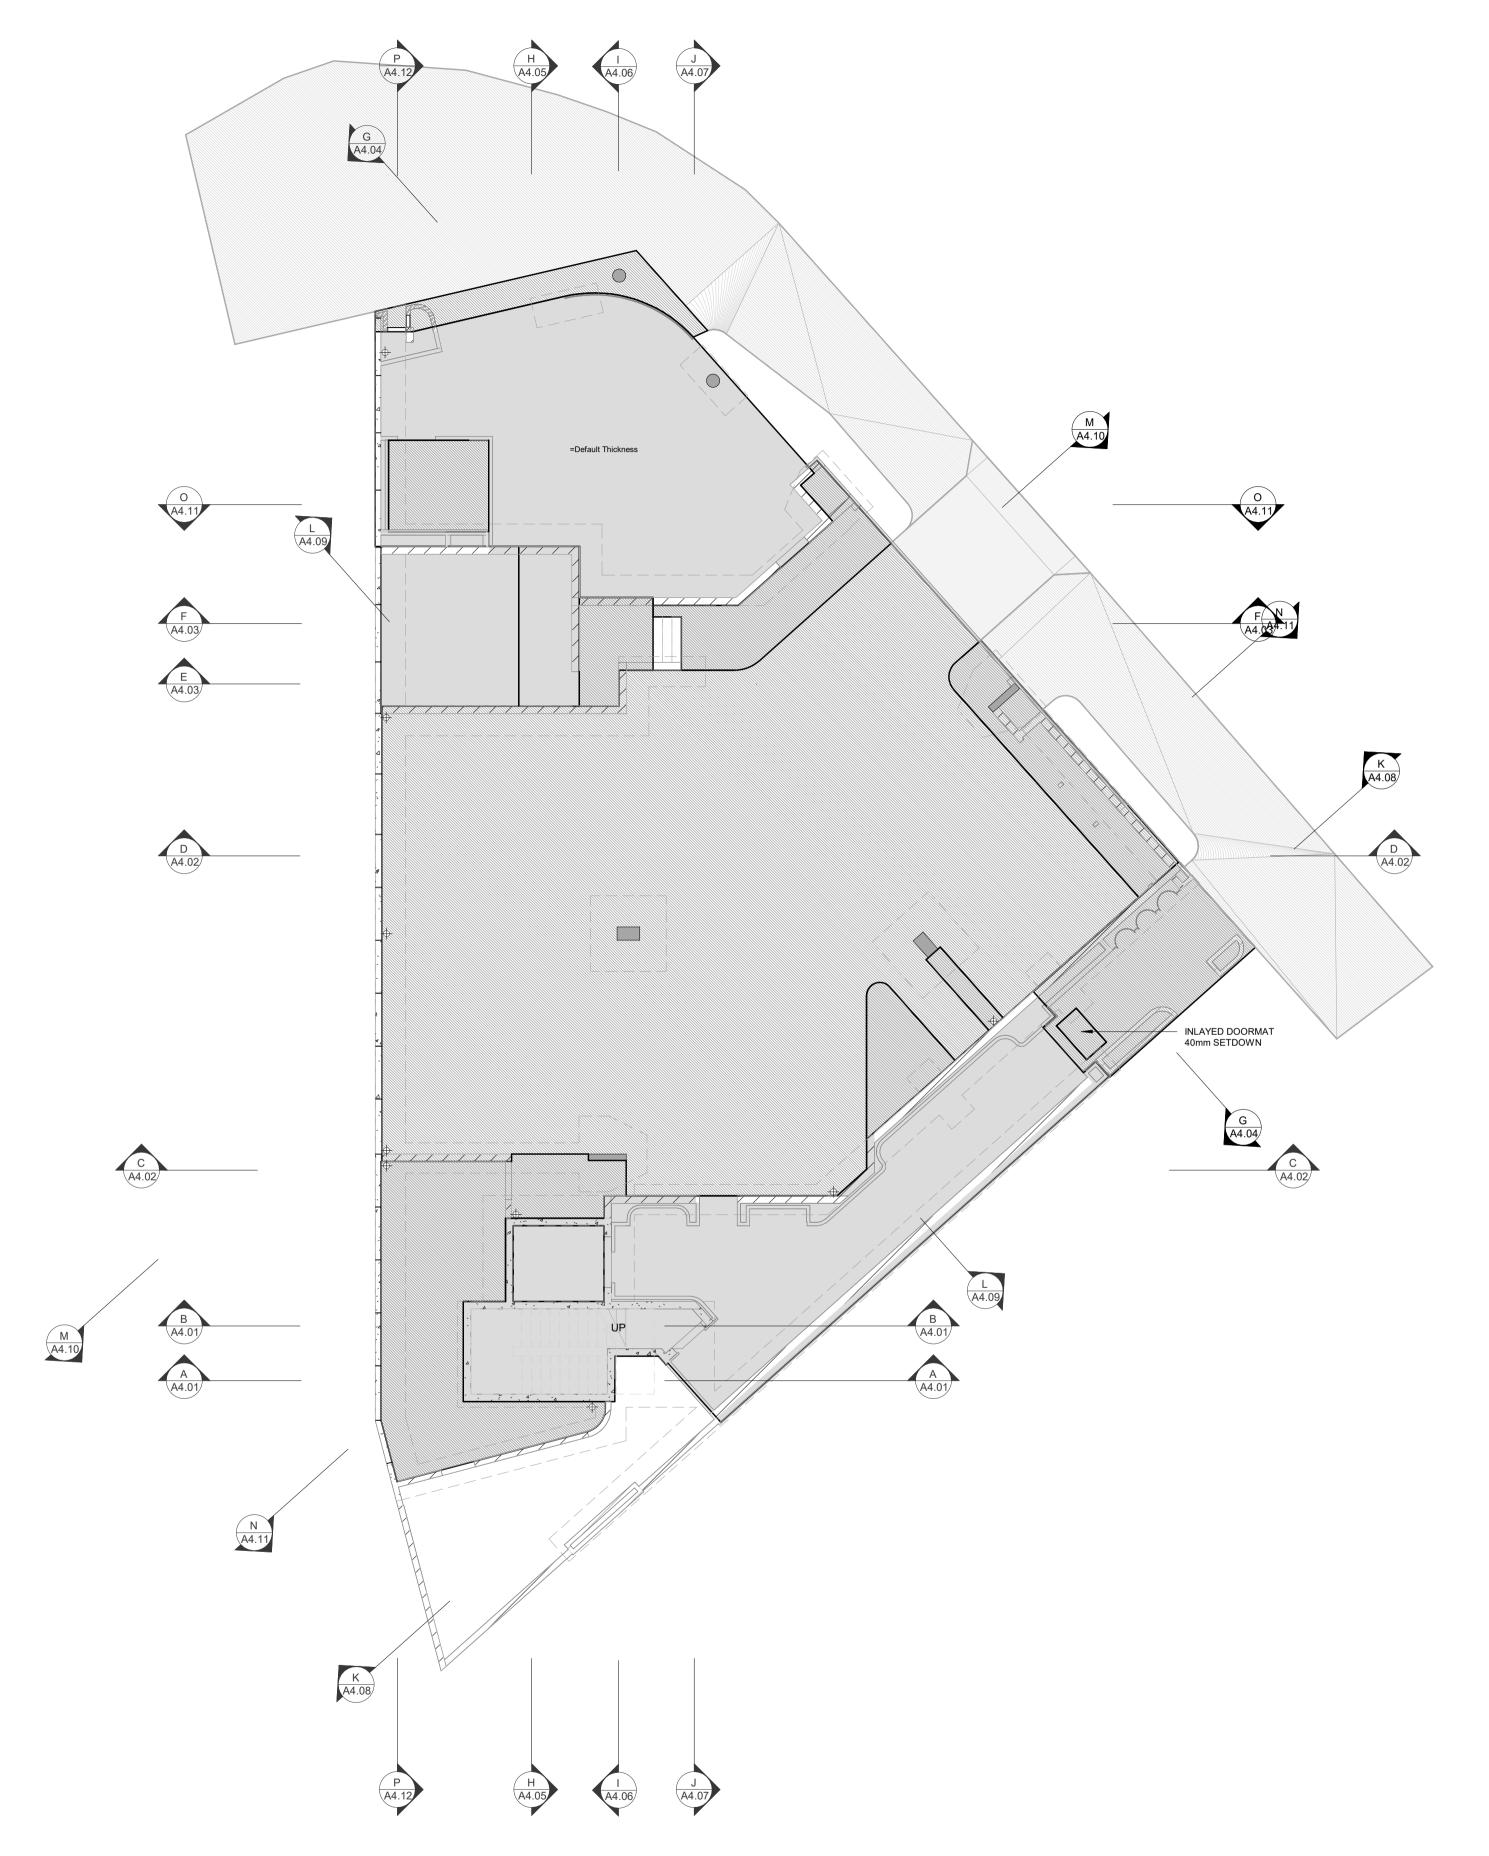
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1 02b GROUND FLOOR SLAB SETOUT PLAN
A3.01 SCALE 1:100

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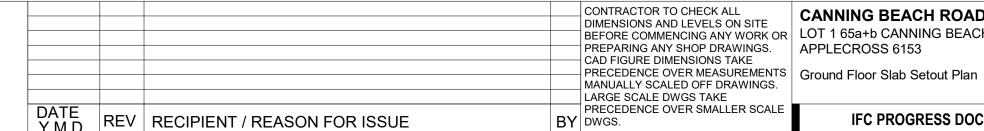
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BOUNDARY TO BE FIRE PROTECTED TO CODES AND STANDARDS.
INSTALL FLASHINGS, EDGE TRIMS AND APPROPRIATE SEASL AS REQUIRED TO ACHIEVE WEATHER TIGHTNESS. FINISH TO BE SAME AS ADJACENT MATERIAL U.N.O. BUILDING TAG XX-XX REFER MASTER MATERIALS SCHEDULE FOR THE FOLLOWING AND MORE: STRUCTURE SURFACE FINISHES 16.4 FINISHES
FIXTURES & FITTINGS 16.5 APPLIANCES
WATERPROOFING SYSTEMS 16.6 TRIMS ABBREVIATION LEGEND LIN'N LDRY M/H MW O/A OAE ACDP AIR-CONDITIONING DOWNPIPE ABOVE FINISHED LAUNDRY MANHOLE AFFL MICROWAVE OVERALL OR APPROVED ABOVE FLOOR LEVEL (W/O FINISH) AGG AP APP BCJ BALU BK BW CFC AGGREGATÉ EQUIVALENT ACCESS PANEL OVERHEAD APPLIANCE OVERFLOW OVEN PANTRY BRICK CONTROL JOINT BALUSTRADE BARRIER KERB PLASTERBOARD BASE OF WALL (AKA BoW) COMPRESSED FIBRE POINT DRAIN (REF. HYD FOR TYPES) PLANTING LEVEL (TOP CONTROL JOINT OF MULCH) CEILING LEVEL RETURN AIR GRILLE RH RKZ (BOTTOM OF LINING) RANGEHOOD COL COLUMN RAKING RL RPZ CONC C.O.S. CU DP DU DW ENS EQ. EX. EXP FC FE FH FK FL CONCRETE RELATIVE LEVEL CONFIRM ON SITE REDUCED PRESSURE CONDENSER UNIT DOWNPIPE (AKA RWP) RAINWATER HEAD DUCT DISHWASHER SAG SHWR SK SL SUPPLY AIR GRILLE SHOWER SINK STRUCTURAL SLAB **ENSUITE** EQUAL **EXISTING** LEVEL (AKA SSL) EXPOSED FIBRE CEMENT SHEET SMK SEMI-MOUNTABLE STAINLESS STEEL FIRE HYDRANT SOIL STACK FLUSH KERB STANDARDS SOAKWELL (REF. HYD.) TO BE CONFIRMED FLOOR LEVEL W/O FINISHES (AKA SL) FINISHED FLOOR LEVEL TRANSITION KERB FRIDGE FLOOR WASTE TROUGH TOP OF WALL HOSECOCK (AKA TOW) HOT PLATE TYPICAL HARDWOOD HOT WATER SUPPLY **UNLESS NOTED** OTHERWISE HARDWALL PLASTER **VANITY BASIN** (FLOAT & SET) INSPECTION POINT VENT PIPE WITH W/ W/O WS WM WITHOUT LOAD CENTRE WHEEL STOP WASHING MACHINE

GENERAL NOTES

DIMENSIONS.

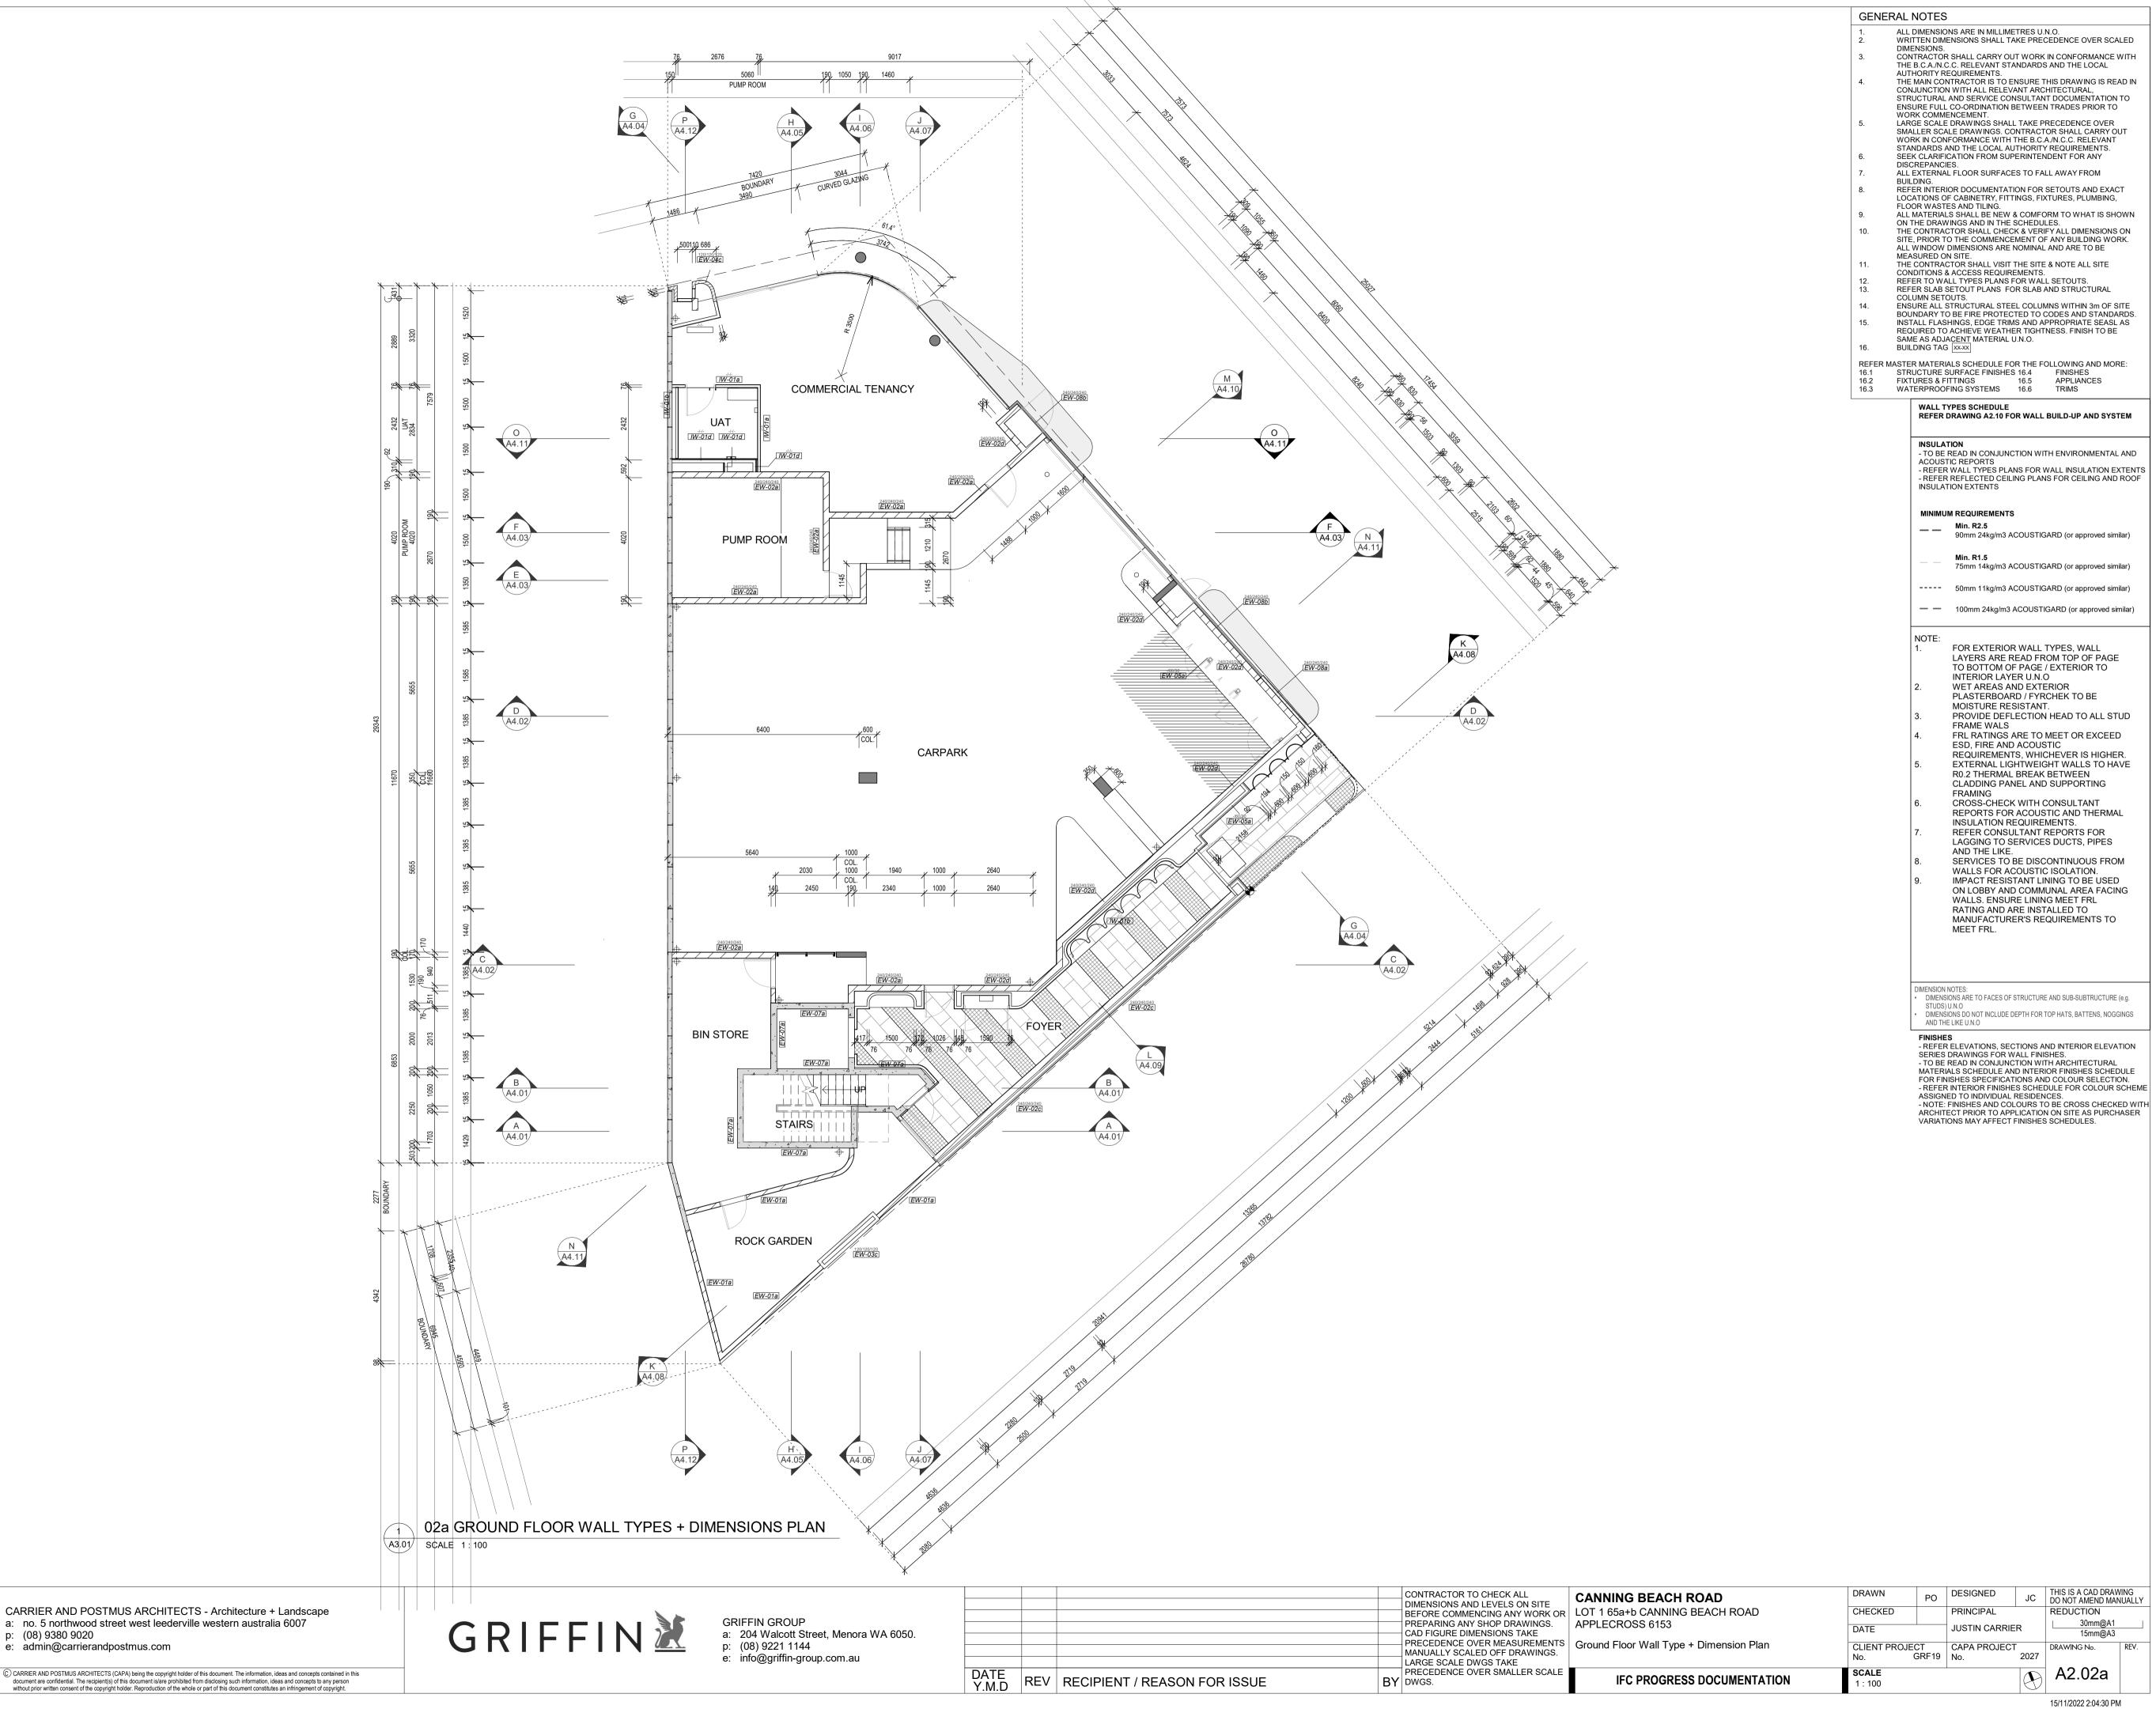ALL DIMENSIONS ARE IN MILLIMETRES U.N.O.

AUTHORITY REQUIREMENTS.

WORK COMMENCEMENT.

FLOOR WASTES AND TILING.

CONDITIONS & ACCESS REQUIREMENTS.

WRITTEN DIMENSIONS SHALL TAKE PRECEDENCE OVER SCALED

CONTRACTOR SHALL CARRY OUT WORK IN CONFORMANCE WITH THE B.C.A./N.C.C. RELEVANT STANDARDS AND THE LOCAL

THE MAIN CONTRACTOR IS TO ENSURE THIS DRAWING IS READ IN CONJUNCTION WITH ALL RELEVANT ARCHITECTURAL, STRUCTURAL AND SERVICE CONSULTANT DOCUMENTATION TO ENSURE FULL CO-ORDINATION BETWEEN TRADES PRIOR TO

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REFER INTERIOR DOCUMENTATION FOR SETOUTS AND EXACT LOCATIONS OF CABINETRY, FITTINGS, FIXTURES, PLUMBING,

REFER TO WALL TYPES PLANS FOR WALL SETOUTS.
REFER SLAB SETOUT PLANS FOR SLAB AND STRUCTURAL COLUMN SETOUTS.
ENSURE ALL STRUCTURAL STEEL COLUMNS WITHIN 3m OF SITE

ALL MATERIALS SHALL BE NEW & COMFORM TO WHAT IS SHOWN ON THE DRAWINGS AND IN THE SCHEDULES. THE CONTRACTOR SHALL CHECK & VERIFY ALL DIMENSIONS ON SITE, PRIOR TO THE COMMENCEMENT OF ANY BUILDING WORK. ALL WINDOW DIMENSIONS ARE NOMINAL AND ARE TO BE MEASURED ON SITE.
THE CONTRACTOR SHALL VISIT THE SITE & NOTE ALL SITE

<u>LEGEND</u> TYPICAL CONC. SLAB LEVEL -40mm WET AREA SETDOWN

-100mm LOWER EXTERNAL SLAB XXX SLAB THICKNESS

I. STRUCTURAL ENGINEER DRAWINGS TAKE PRECEDENCE FOR SLAB THICKNESS AND COLUMN SIZES.

2. IF DISCREPANCIES BETWEEN ARCHITECTURAL AND STRUCTURAL DRAWINGS OCCUR, NOTIFY THE SUPERINTENDENT FOR ADVICE PRIOR TO SETOUT ON SITE. 3. FIRE COLLAR TO SERVICES PENETRATION THROUGH SLAB. TYPICAL.

4. SERVICES SHAFTS PENETRATING THROUGH S.O.U. MUST ACHIEVE FRL -/90/90. 5. CROSS CHECK SLAB SETOUT WITH WALL SETOUT DRAWINGS.


6. TYPICALLY, WET AREA SETDOWN ARE ALIGNED TO STUD FRAME FACE. PLASTERBOARD / FYRCHEK TO BE FLUSH AGAINST STUD

AND SLAB SETDOWN FACE. 7. TYPICALLY, EXTERNAL SLAB STEPS ARE TO EXTERNAL FYRCHEK FACE.

8. ALLOW 500mm BETWEEN PAVING AND TOP OF FOOTING FOR HYDRUALIC SERVICES TO BEND BELOW GROUND.

9. FOOTINGS ADJACENT TO GARDEN BEDS TO BE LOWERED TO ALLOW MIN. 1200mm PLANTING DEPTH AT TREES AND MIN. 500mm PLANTING DEPTH FOR GENERAL PLANTING. REFER LANDSCAPE DRAWINGS FOR SOFT LANDSCAPING PLANTING EXTENTS

IFC PROGRESS DOCUMENTATION

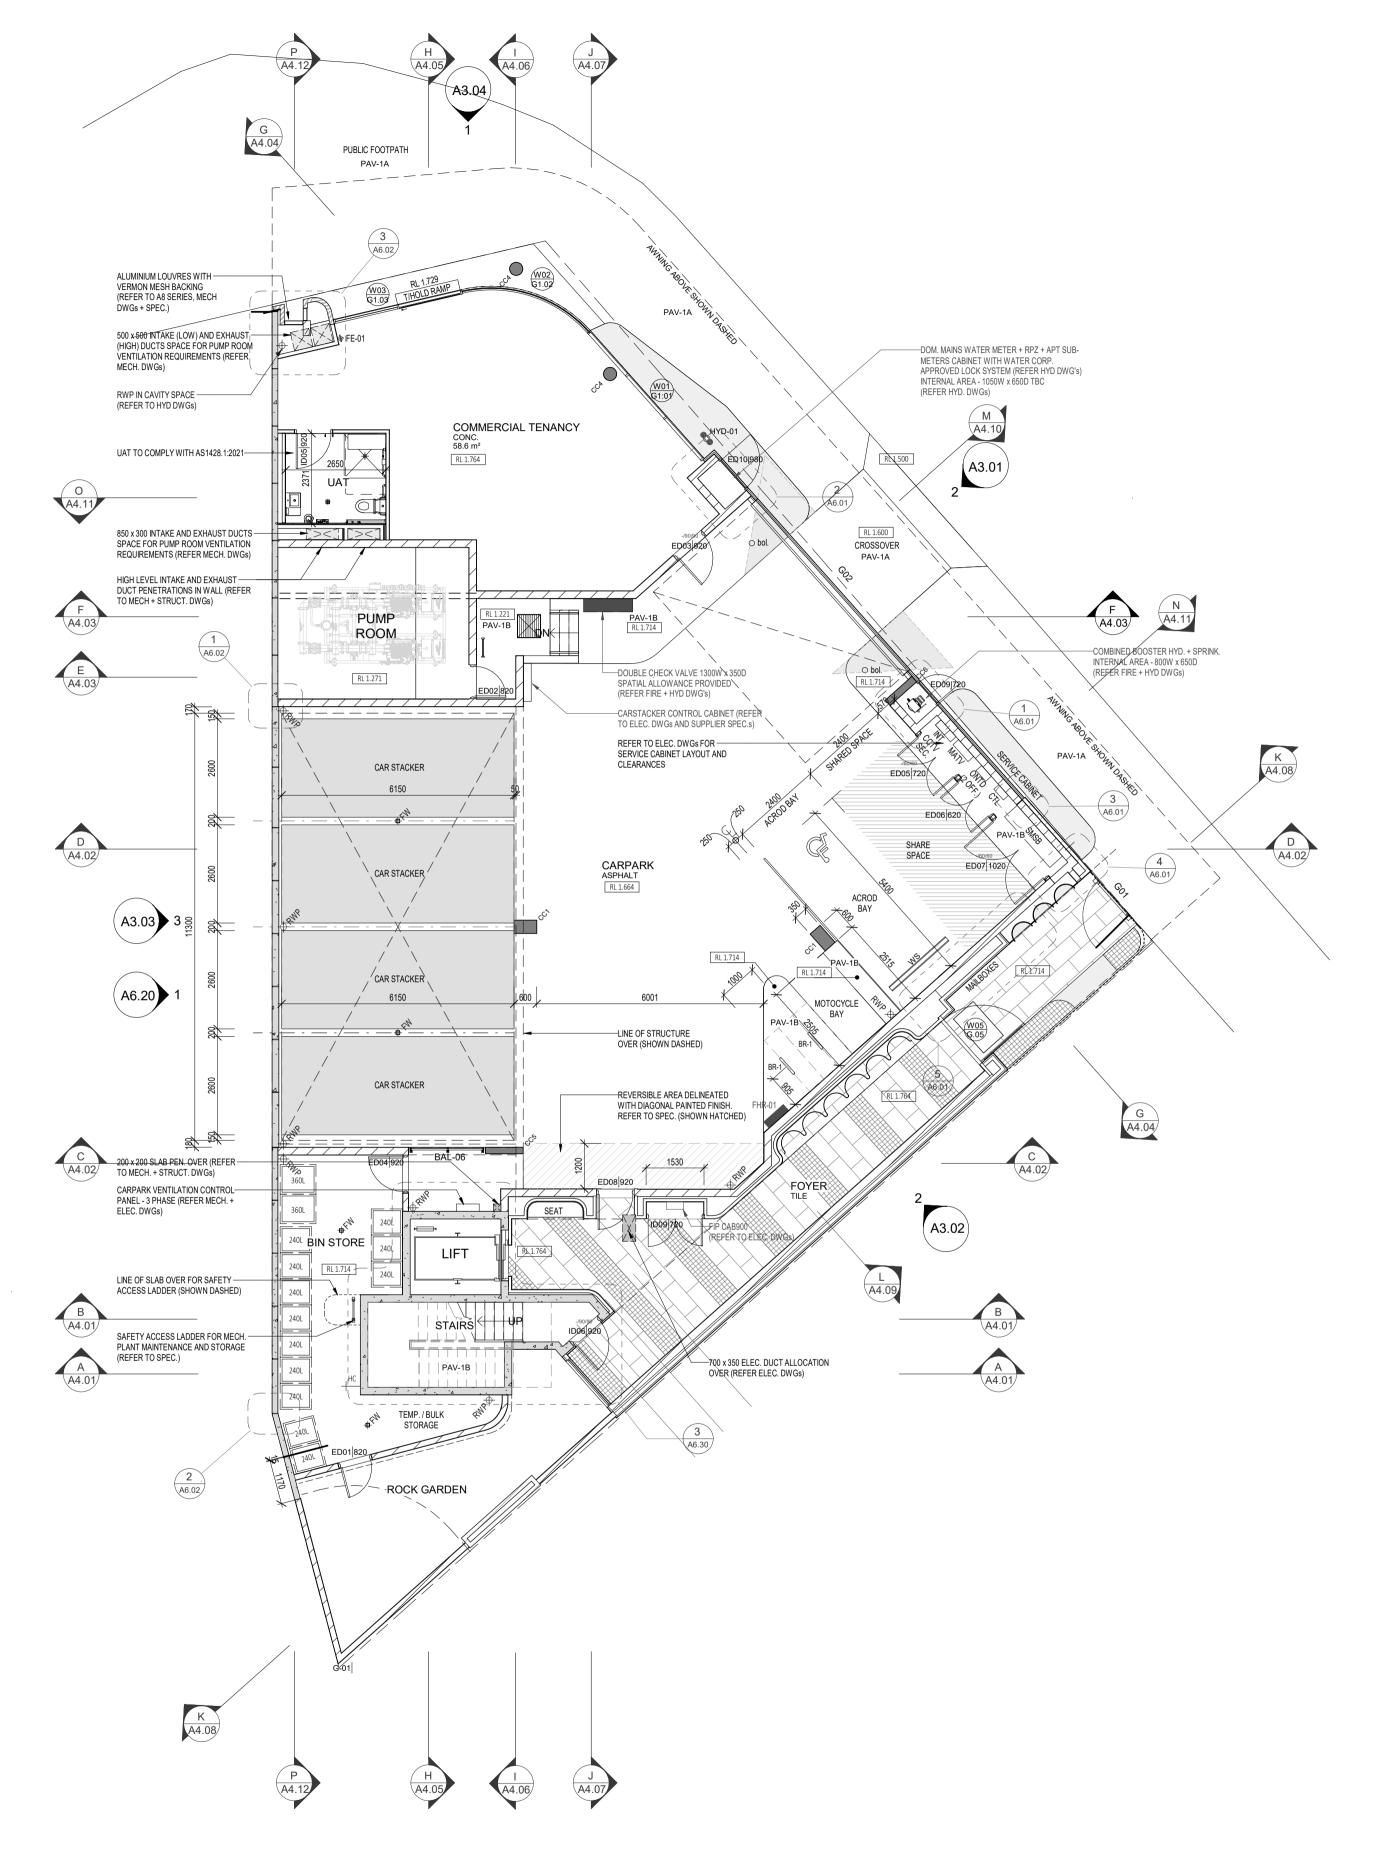

02 GROUND FLOOR GENERAL ARRANCEMENT PLAN

SCALE 1:100

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DATE Y.M.D	REV	RECIPIENT / REASON FOR ISSUE	BY	PRECEDENCE OVER SMALLER SCALE DWGS.

CANNING BEACH ROAD
LOT 1 65a+b CANNING BEACH ROAD APPLECROSS 6153
Ground Floor General Arrangement Plan

IFC PROGRESS DOCUMENTATION

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GENERAL NOTES

BUILDING.

BUILDING TAG XX-XX

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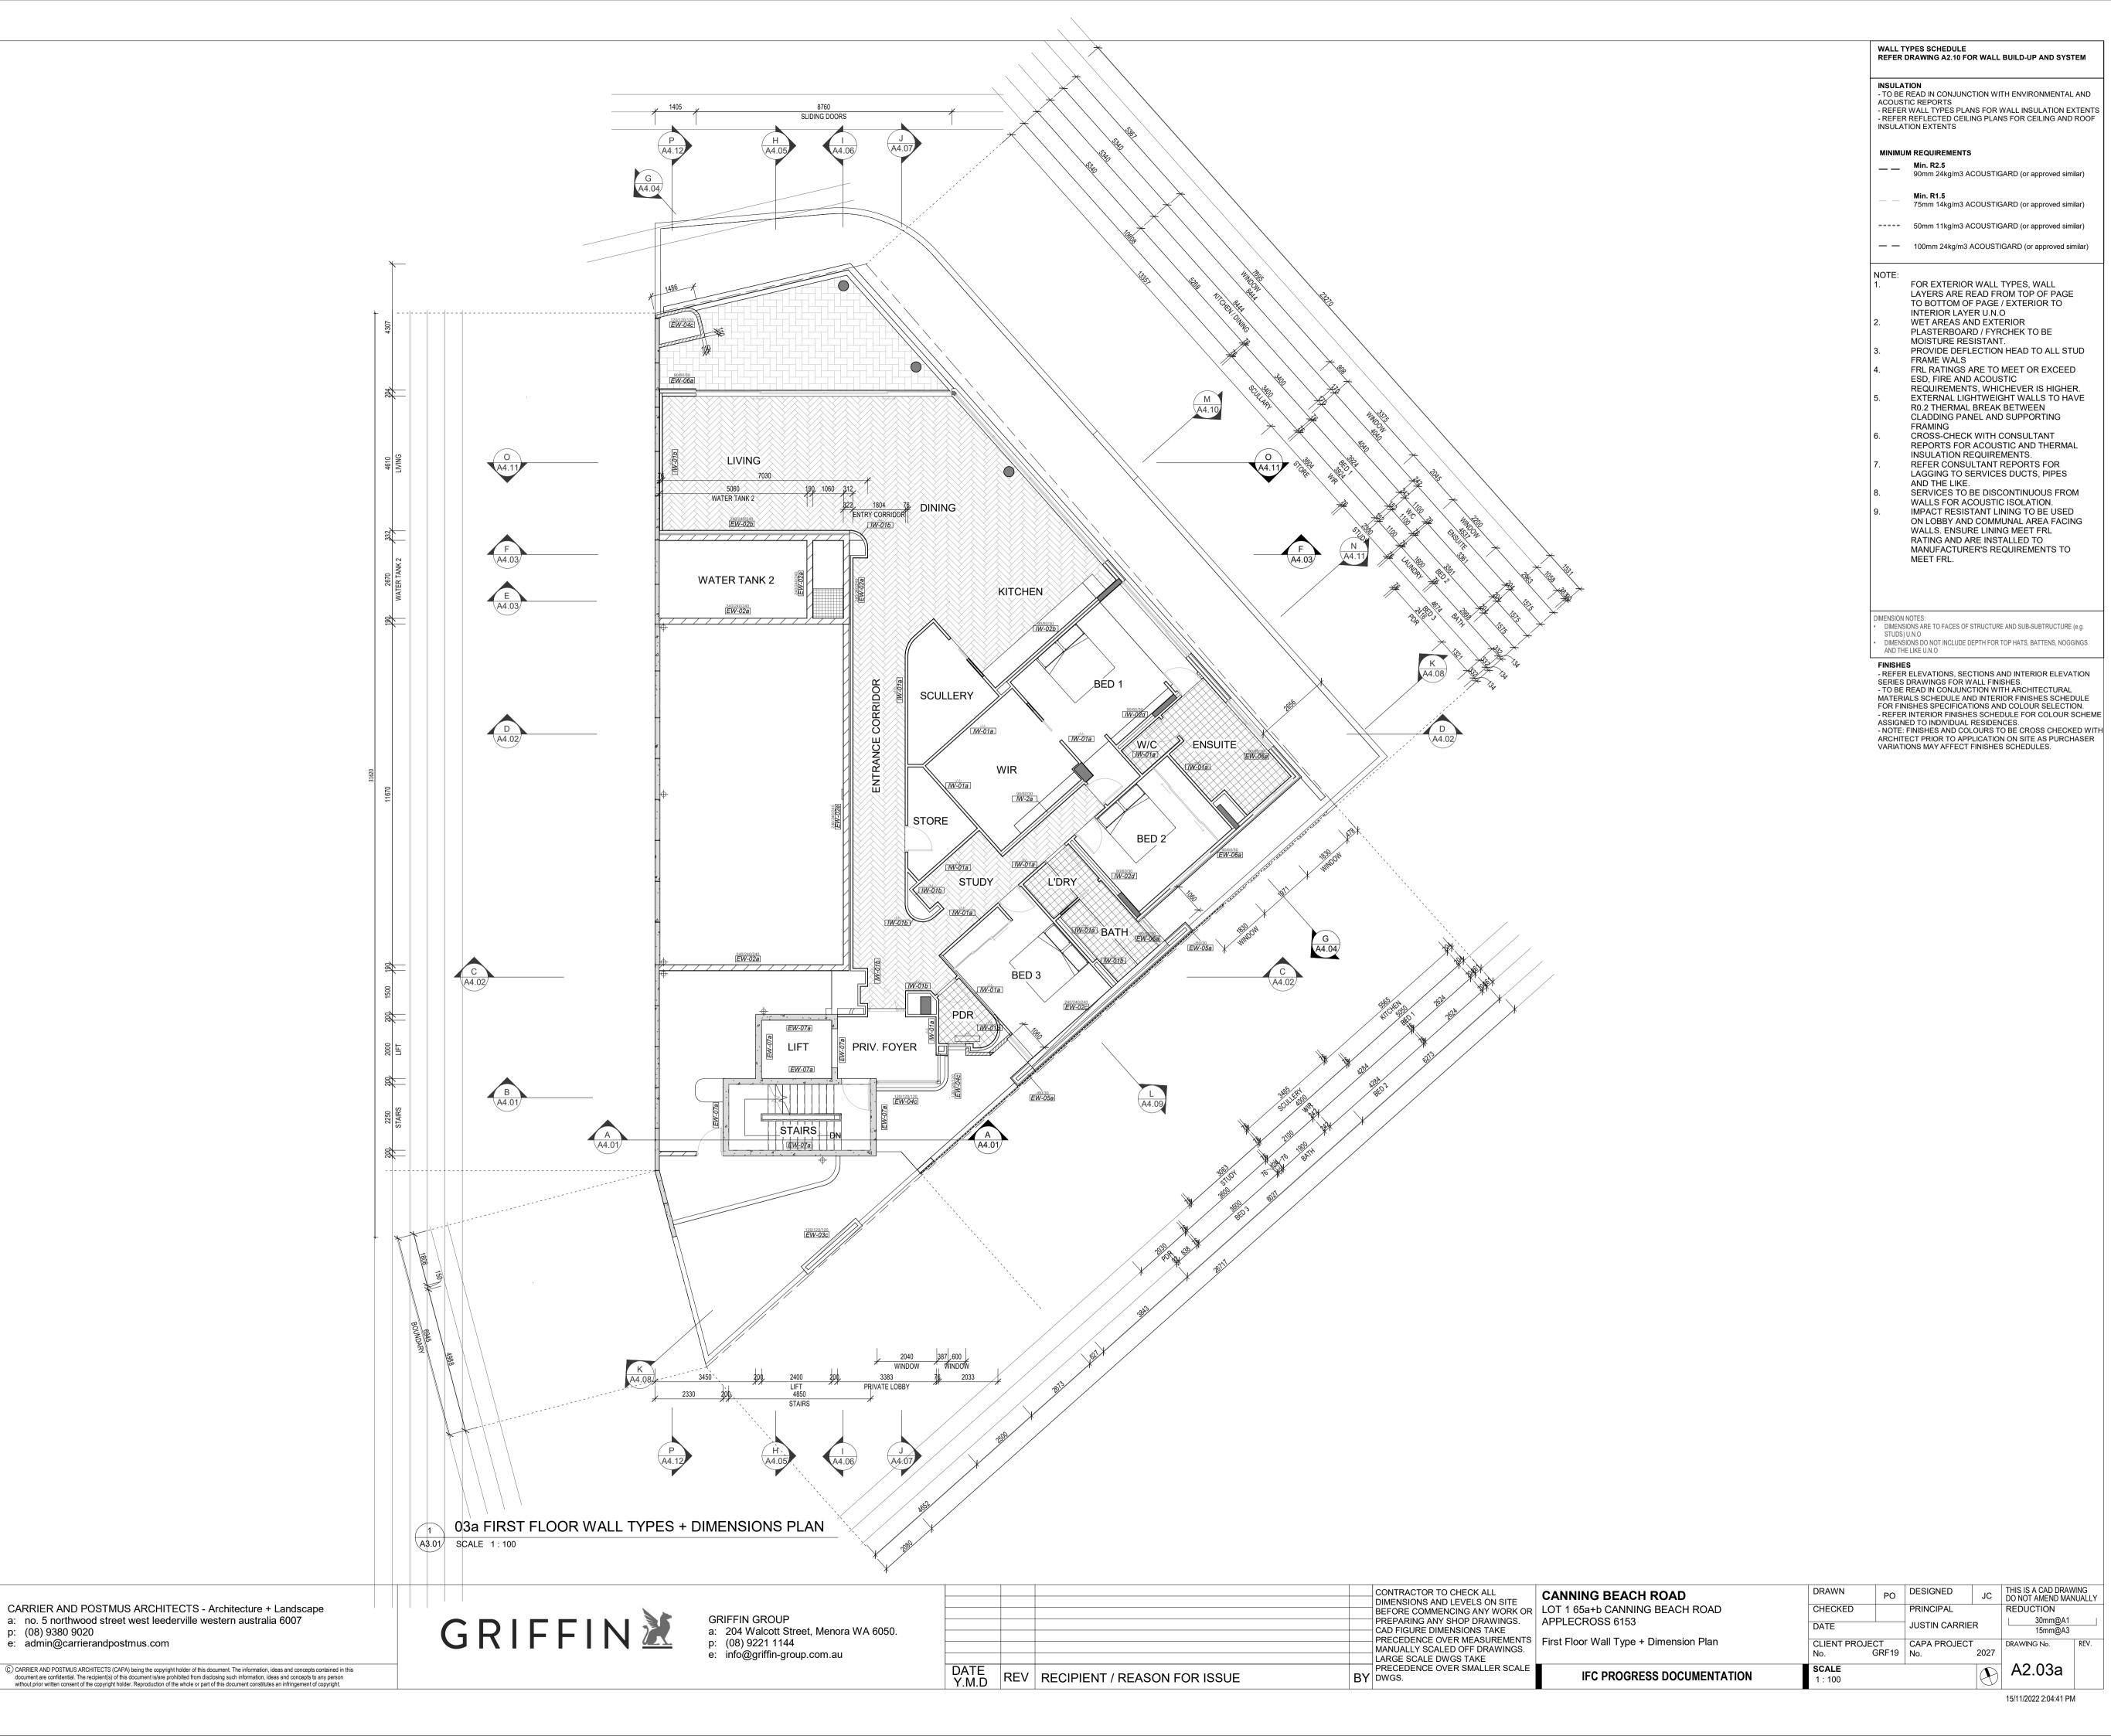
SITE, PRIOR TO THE COMMENCEMENT OF ANY BUILDING WORK. ALL WINDOW DIMENSIONS ARE NOMINAL AND ARE TO BE

COLUMN SETOUT PLANS FOR SLAB AND STRUCTURAL COLUMN SETOUTS.
ENSURE ALL STRUCTURAL STEEL COLUMNS WITHIN 3m OF SITE BOUNDARY TO BE FIRE PROTECTED TO CODES AND STANDARDS. INSTALL FLASHINGS, EDGE TRIMS AND APPROPRIATE SEASL AS

REQUIRED TO ACHIEVE WEATHER TIGHTNESS. FINISH TO BE SAME AS ADJACENT MATERIAL U.N.O.

REFER MASTER MATERIALS SCHEDULE FOR THE FOLLOWING AND MORE:
16.1 STRUCTURE SURFACE FINISHES 16.4 FINISHES
16.2 FIXTURES & FITTINGS 16.5 APPLIANCES
16.3 WATERPROOFING SYSTEMS 16.6 TRIMS


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REFER SLAB SETOUT PLANS FOR SLAB AND STRUCTURAL



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03b FIRST FLOOR SLAB SETOUT PLAN
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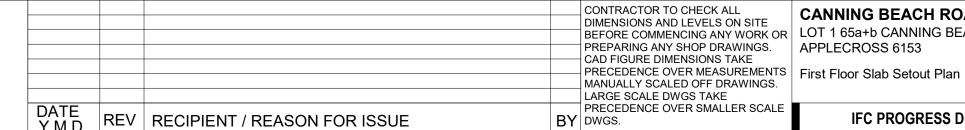
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1:100

LEGEND

TYPICAL CONC. SLAB LEVEL

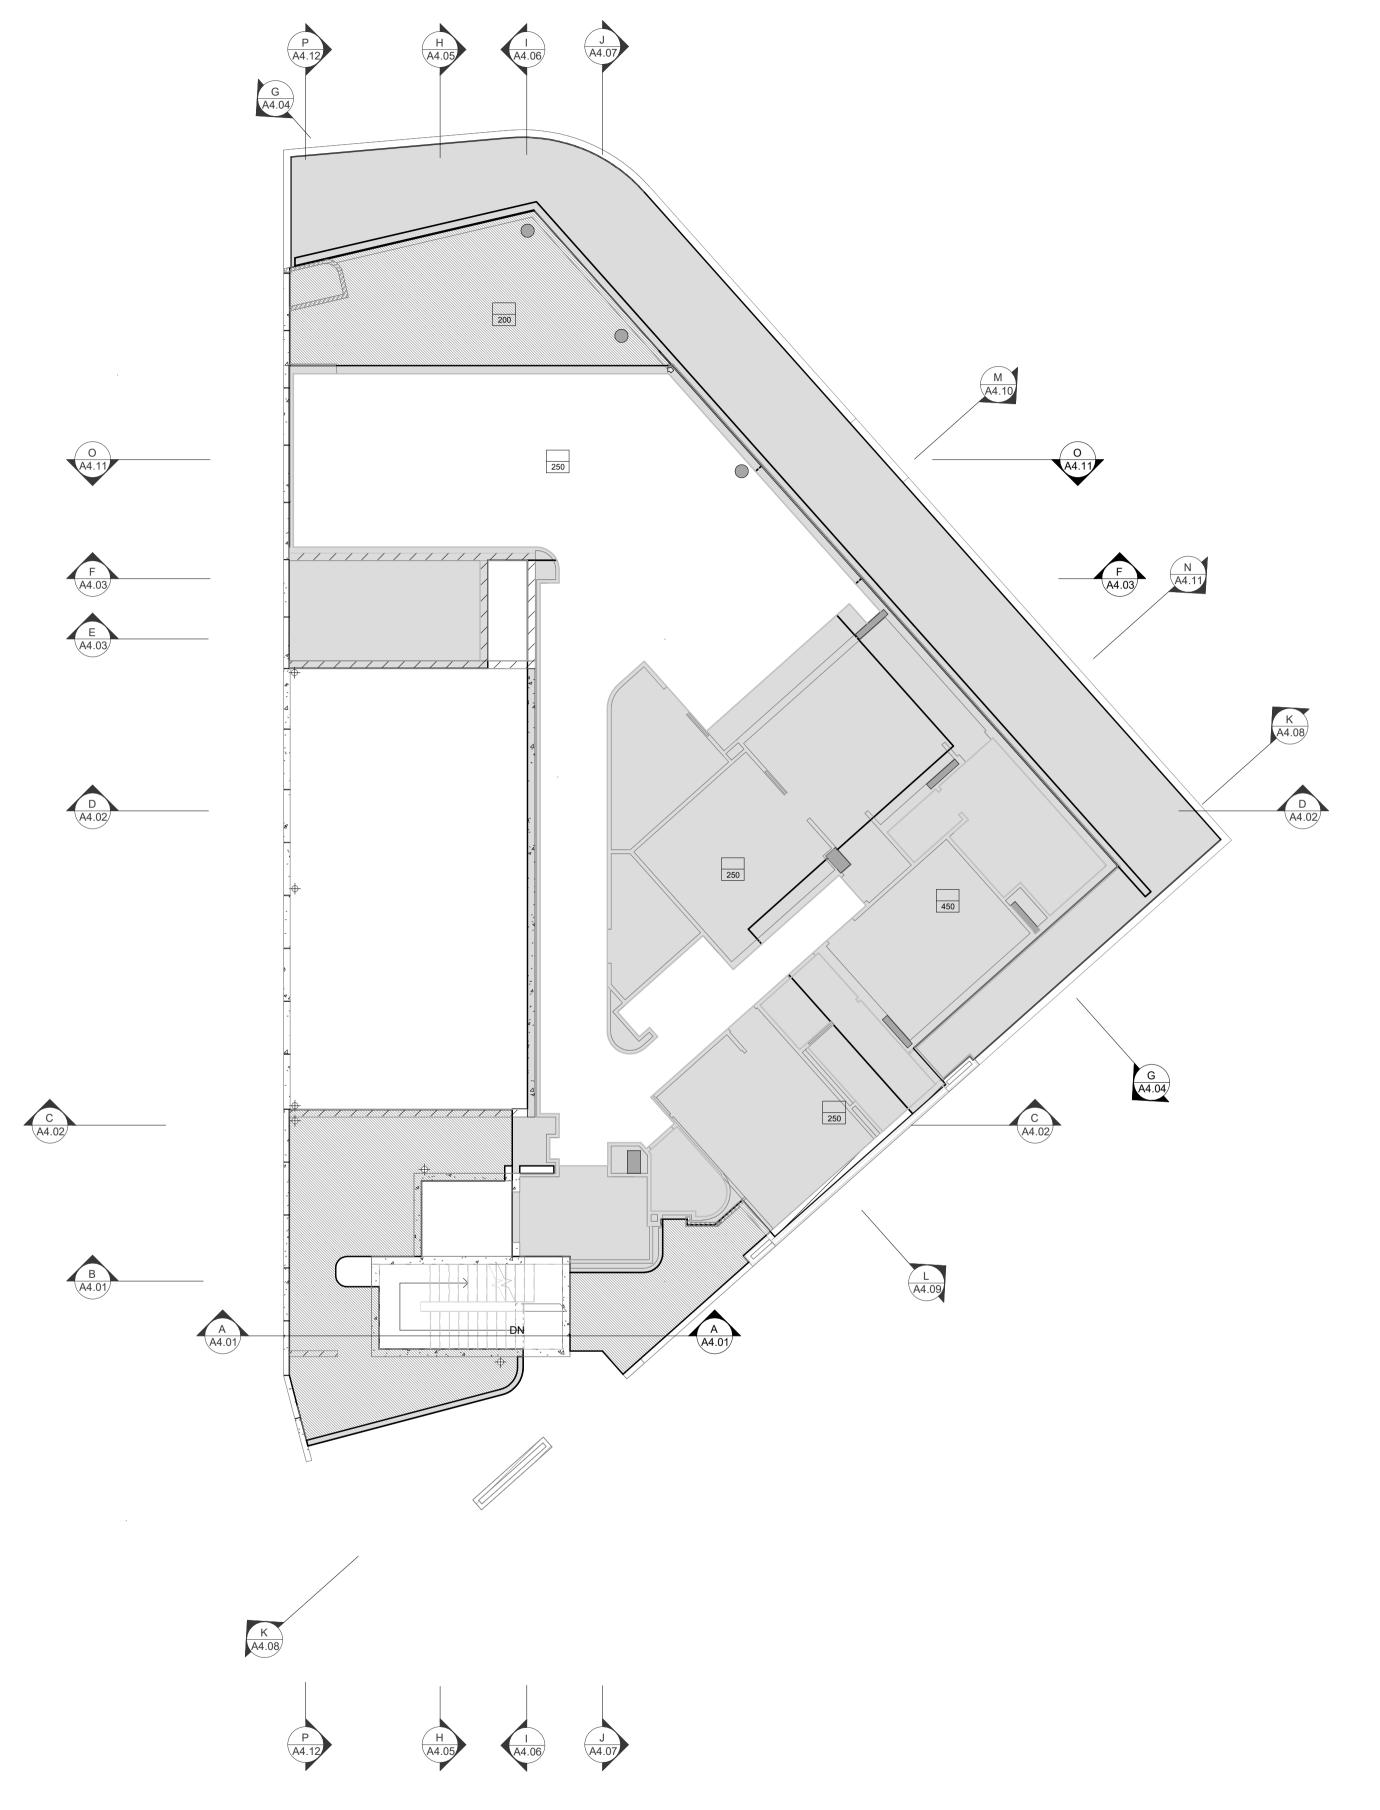AND COLUMN SIZES.

MUST ACHIEVE FRL -/90/90.

AND SLAB SETDOWN FACE.

PLANTING EXTENTS

SERVICES TO BEND BELOW GROUND.

-40mm WET AREA SETDOWN

-100mm LOWER EXTERNAL SLAB XXX SLAB THICKNESS

. STRUCTURAL ENGINEER DRAWINGS TAKE PRECEDENCE FOR SLAB THICKNESS

2. IF DISCREPANCIES BETWEEN ARCHITECTURAL AND STRUCTURAL DRAWINGS OCCUR, NOTIFY THE SUPERINTENDENT FOR ADVICE PRIOR TO SETOUT ON SITE.

3. FIRE COLLAR TO SERVICES PENETRATION THROUGH SLAB. TYPICAL.

7. TYPICALLY, EXTERNAL SLAB STEPS ARE TO EXTERNAL FYRCHEK FACE. 8. ALLOW 500mm BETWEEN PAVING AND TOP OF FOOTING FOR HYDRUALIC

MIN. 1200mm PLANTING DEPTH AT TREES AND MIN. 500mm PLANTING DEPTH FOR

GENERAL PLANTING. REFER LANDSCAPE DRAWINGS FOR SOFT LANDSCAPING

9. FOOTINGS ADJACENT TO GARDEN BEDS TO BE LOWERED TO ALLOW

5. CROSS CHECK SLAB SETOUT WITH WALL SETOUT DRAWINGS. 6. TYPICALLY, WET AREA SETDOWN ARE ALIGNED TO STUD FRAME FACE.

PLASTERBOARD / FYRCHEK TO BE FLUSH AGAINST STUD

4. SERVICES SHAFTS PENETRATING THROUGH S.O.U.

GENERAL NOTES

DIMENSIONS.

AUTHORITY REQUIREMENTS.

WORK COMMENCEMENT.

FLOOR WASTES AND TILING.

CONDITIONS & ACCESS REQUIREMENTS.

SAME AS ADJACENT MATERIAL U.N.O.

BUILDING TAG XX-XX

ABBREVIATION LEGEND

AIR-CONDITIONING

DOWNPIPE ABOVE FINISHED

ACCESS PANEL

APPLIANCE

BALUSTRADE BARRIER KERB

CONTROL JOINT

CONFIRM ON SITE

CONDENSER UNIT

(BOTTOM OF LINING)

DOWNPIPE (AKA RWP)

EXPOSED FIBRE CEMENT SHEET

FLOOR LEVEL W/O FINISHES (AKA SL) FINISHED FLOOR LEVEL

HARDWOOD HOT WATER SUPPLY

INSPECTION POINT

HARDWALL PLASTER

FIRE HYDRANT

FLUSH KERB

FRIDGE FLOOR WASTE

HOSECOCK

HOT PLATE

(FLOAT & SET)

LOAD CENTRE

CEILING LEVEL

COLUMN

DUCT DISHWASHER

ENSUITE EQUAL **EXISTING**

CONCRETE

ABOVE FLOOR LEVEL (W/O FINISH)

BRICK CONTROL JOINT

BASE OF WALL (AKA BoW) COMPRESSED FIBRE

ACDP

AFFL

AGG AP APP BCJ BALU BK BW CFC

COL

CONC C.O.S.

CU DP DU ENS EQ. EXP FC FE FH FK FL

16.2 FIXTURES & FITTINGS 16.5 16.3 WATERPROOFING SYSTEMS 16.6

ALL DIMENSIONS ARE IN MILLIMETRES U.N.O.

WRITTEN DIMENSIONS SHALL TAKE PRECEDENCE OVER SCALED

CONTRACTOR SHALL CARRY OUT WORK IN CONFORMANCE WITH THE B.C.A./N.C.C. RELEVANT STANDARDS AND THE LOCAL

THE MAIN CONTRACTOR IS TO ENSURE THIS DRAWING IS READ IN CONJUNCTION WITH ALL RELEVANT ARCHITECTURAL, STRUCTURAL AND SERVICE CONSULTANT DOCUMENTATION TO ENSURE FULL CO-ORDINATION BETWEEN TRADES PRIOR TO

LARGE SCALE DRAWINGS SHALL TAKE PRECEDENCE OVER SMALLER SCALE DRAWINGS. CONTRACTOR SHALL CARRY OUT WORK IN CONFORMANCE WITH THE B.C.A./N.C.C. RELEVANT STANDARDS AND THE LOCAL AUTHORITY REQUIREMENTS. SEEK CLARIFICATION FROM SUPERINTENDENT FOR ANY DISCREPANCIES. ALL EXTERNAL FLOOR SURFACES TO FALL AWAY FROM

REFER INTERIOR DOCUMENTATION FOR SETOUTS AND EXACT LOCATIONS OF CABINETRY, FITTINGS, FIXTURES, PLUMBING,

REFER TO WALL TYPES PLANS FOR WALL SETOUTS.
REFER SLAB SETOUT PLANS FOR SLAB AND STRUCTURAL COLUMN SETOUTS.
ENSURE ALL STRUCTURAL STEEL COLUMNS WITHIN 3m OF SITE BOUNDARY TO BE FIRE PROTECTED TO CODES AND STANDARDS.
INSTALL FLASHINGS, EDGE TRIMS AND APPROPRIATE SEASL AS REQUIRED TO ACHIEVE WEATHER TIGHTNESS. FINISH TO BE

REFER MASTER MATERIALS SCHEDULE FOR THE FOLLOWING AND MORE: STRUCTURE SURFACE FINISHES 16.4 FINISHES FIXTURES & FITTINGS 16.5 APPLIANCES

LIN'N LDRY M/H MW

O/A OAE

RH RKZ

RPZ

SAG SHWR SK

SMK

W/O WS WM

LAUNDRY

MANHOLE MICROWAVE OVERALL OR APPROVED

EQUIVALENT

PLASTERBOARD

POINT DRAIN (REF. HYD FOR TYPES) PLANTING LEVEL (TOP

RETURN AIR GRILLE

REDUCED PRESSURE

RAINWATER HEAD

SUPPLY AIR GRILLE

LEVEL (AKA SSL)

SEMI-MOUNTABLE STAINLESS STEEL

TRANSITION KERB

SOIL STACK

STANDARDS SOAKWELL (REF. HYD.) TO BE CONFIRMED

TROUGH TOP OF WALL

TYPICAL

(AKA TOW)

UNLESS NOTED OTHERWISE

VANITY BASIN

WHEEL STOP WASHING MACHINE

VENT PIPE

WITHOUT

WITH

OVERHEAD OVERFLOW

OF MULCH)

RAKING

SHOWER SINK STRUCTURAL SLAB


RANGEHOOD

RELATIVE LEVEL

OVEN PANTRY

ALL MATERIALS SHALL BE NEW & COMFORM TO WHAT IS SHOWN ON THE DRAWINGS AND IN THE SCHEDULES. THE CONTRACTOR SHALL CHECK & VERIFY ALL DIMENSIONS ON SITE, PRIOR TO THE COMMENCEMENT OF ANY BUILDING WORK. ALL WINDOW DIMENSIONS ARE NOMINAL AND ARE TO BE MEASURED ON SITE.
THE CONTRACTOR SHALL VISIT THE SITE & NOTE ALL SITE

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03 FIRST FLOOR GENERAL ARRANCEMENT PLAN

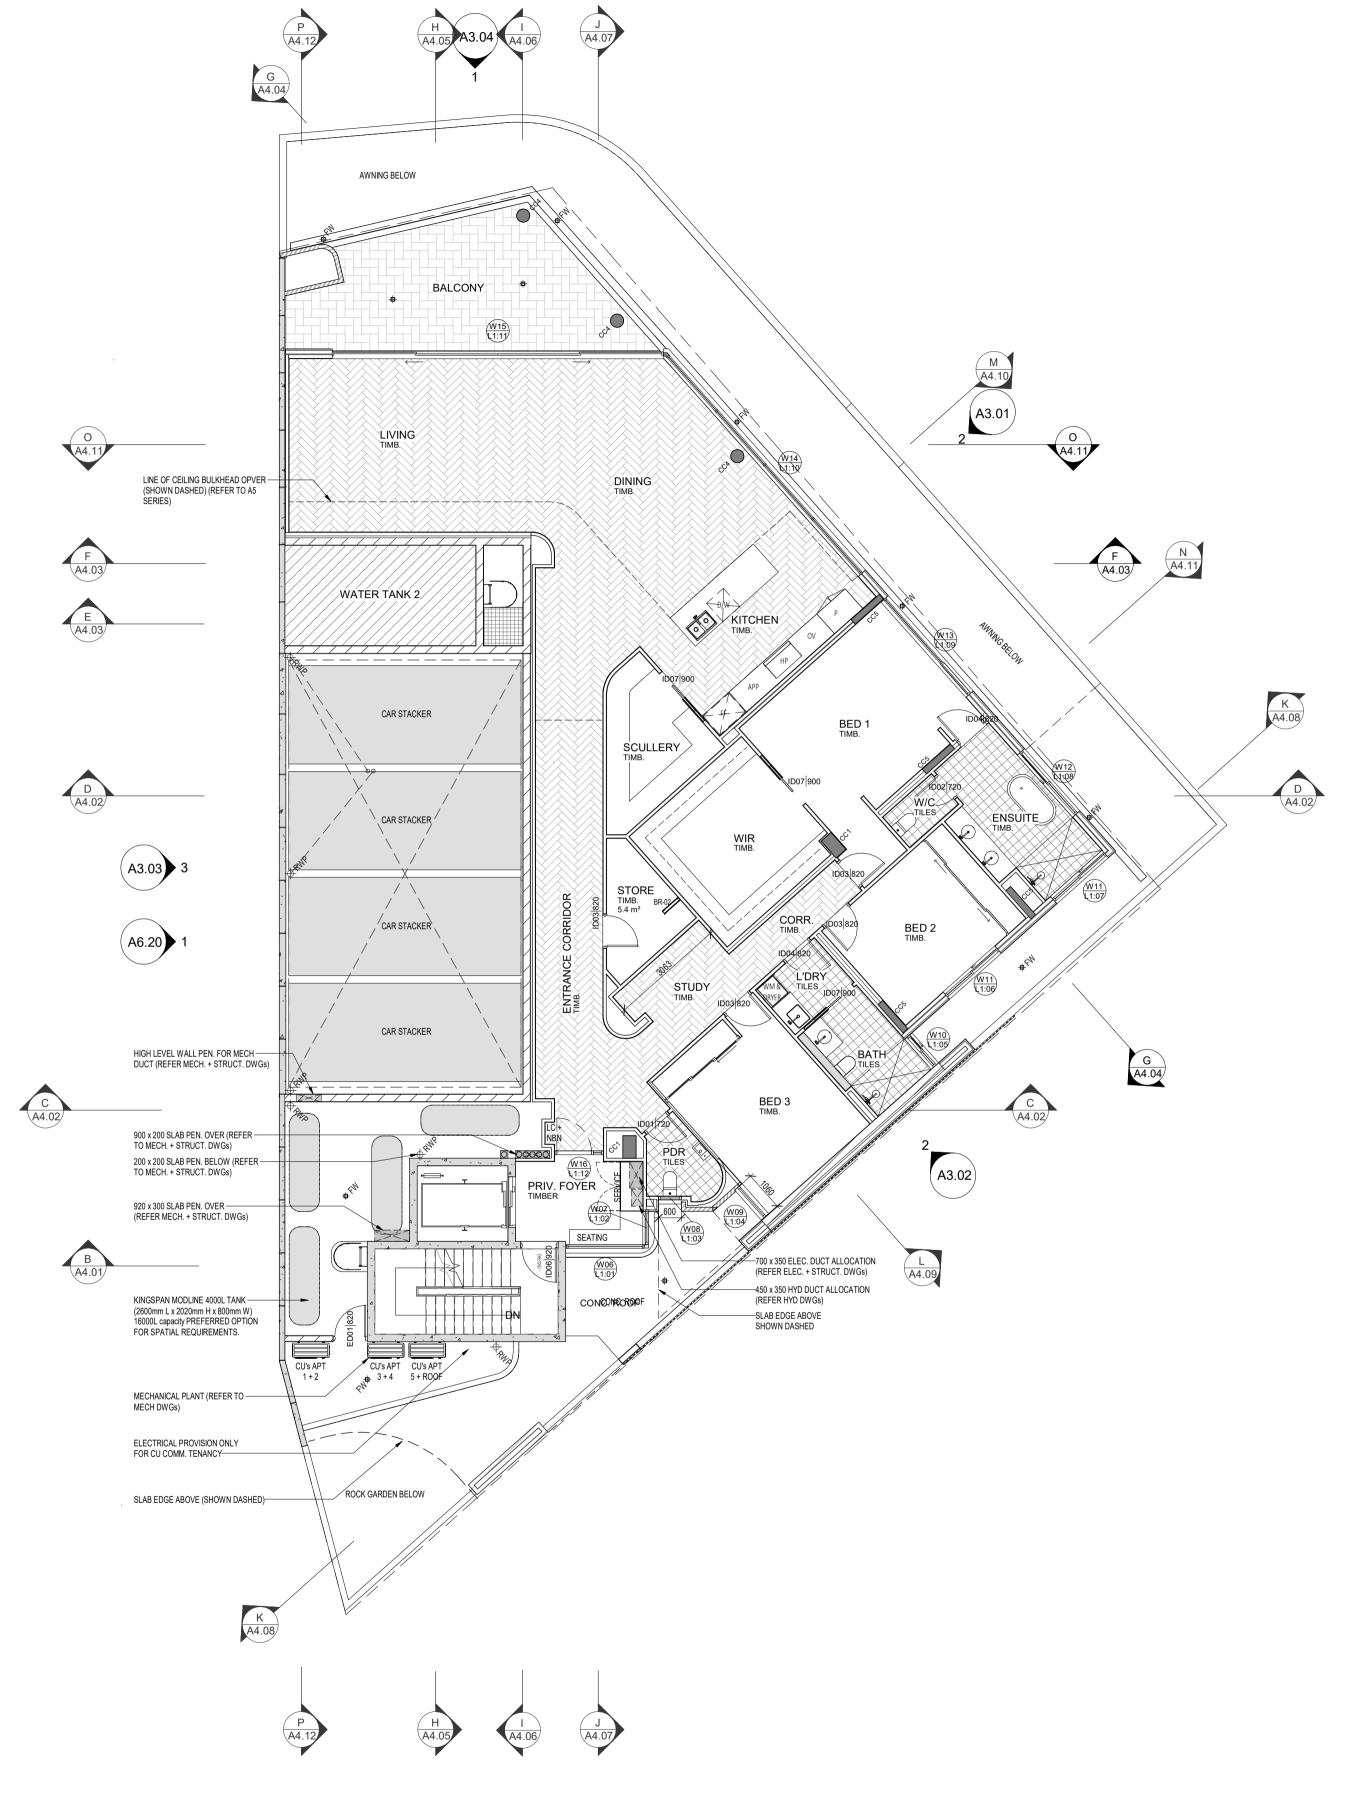SCALE 1: 100

Architecture + Landscape

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				CONTRACTOR TO CHECK ALL
				DIMENSIONS AND LEVELS ON SITE
				BEFORE COMMENCING ANY WORK OF
				PREPARING ANY SHOP DRAWINGS.
				CAD FIGURE DIMENSIONS TAKE
				PRECEDENCE OVER MEASUREMENTS
				MANUALLY SCALED OFF DRAWINGS.
				LARGE SCALE DWGS TAKE
DATE Y.M.D	REV	RECIPIENT / REASON FOR ISSUE	BY	PRECEDENCE OVER SMALLER SCALE DWGS.

CANNING BEACH ROAD
LOT 1 65a+b CANNING BEACH ROAD APPLECROSS 6153
First Floor General Arrangement Plan

IFC PROGRESS DOCUMENTATION

DRAWN	СМ	DESIGNED	JC	THIS IS A CAD DRAW DO NOT AMEND MAI	
CHECKED	JC	PRINCIPAL		REDUCTION 30mm@A1	
DATE		JUSTIN CARRIE	15mm@A3	_	
CLIENT PROJECT	CT GRF19	CAPA PROJECT No.	2027	DRAWING No.	R
SCALE 1:100				A2.03	

GENERAL NOTES

DIMENSIONS.

ALL DIMENSIONS ARE IN MILLIMETRES U.N.O. WRITTEN DIMENSIONS SHALL TAKE PRECEDENCE OVER SCALED

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ENSURE FULL CO-ORDINATION BETWEEN TRADES PRIOR TO WORK COMMENCEMENT.

WORK COMMENCEMENT.

LARGE SCALE DRAWINGS SHALL TAKE PRECEDENCE OVER

SMALLER SCALE DRAWINGS. CONTRACTOR SHALL CARRY OUT

WORK IN CONFORMANCE WITH THE B.C.A./N.C.C. RELEVANT

STANDARDS AND THE LOCAL AUTHORITY REQUIREMENTS.

SEEK CLARIFICATION FROM SUPERINTENDENT FOR ANY

DISCREPANCIES

BUILDING.
REFER INTERIOR DOCUMENTATION FOR SETOUTS AND EXACT LOCATIONS OF CABINETRY, FITTINGS, FIXTURES, PLUMBING, FLOOR WASTES AND TILING.

ALL MATERIALS SHALL BE NEW & COMFORM TO WHAT IS SHOWN ON THE DRAWINGS AND IN THE SCHEDULES.


THE CONTRACTOR SHALL CHECK & VERIFY ALL DIMENSIONS ON SITE, PRIOR TO THE COMMENCEMENT OF ANY BUILDING WORK.
ALL WINDOW DIMENSIONS ARE NOMINAL AND ARE TO BE

REFER SLAB SETOUT PLANS FOR SLAB AND STRUCTURAL COLUMN SETOUTS.
ENSURE ALL STRUCTURAL STEEL COLUMNS WITHIN 3m OF SITE BOUNDARY TO BE FIRE PROTECTED TO CODES AND STANDARDS. INSTALL FLASHINGS, EDGE TRIMS AND APPROPRIATE SEASL AS REQUIRED TO ACHIEVE WEATHER TIGHTNESS. FINISH TO BE SAME AS ADJACENT MATERIAL U.N.O. BUILDING TAG

REFER MASTER MATERIALS SCHEDULE FOR THE FOLLOWING AND MORE:
16.1 STRUCTURE SURFACE FINISHES 16.4 FINISHES
16.2 FIXTURES & FITTINGS 16.5 APPLIANCES
16.3 WATERPROOFING SYSTEMS 16.6 TRIMS

MEASURED ON SITE.
THE CONTRACTOR SHALL VISIT THE SITE & NOTE ALL SITE CONDITIONS & ACCESS REQUIREMENTS.
REFER TO WALL TYPES PLANS FOR WALL SETOUTS.
REFER SLAB SETOUT PLANS FOR SLAB AND STRUCTURAL

DISCREPANCIES.
ALL EXTERNAL FLOOR SURFACES TO FALL AWAY FROM

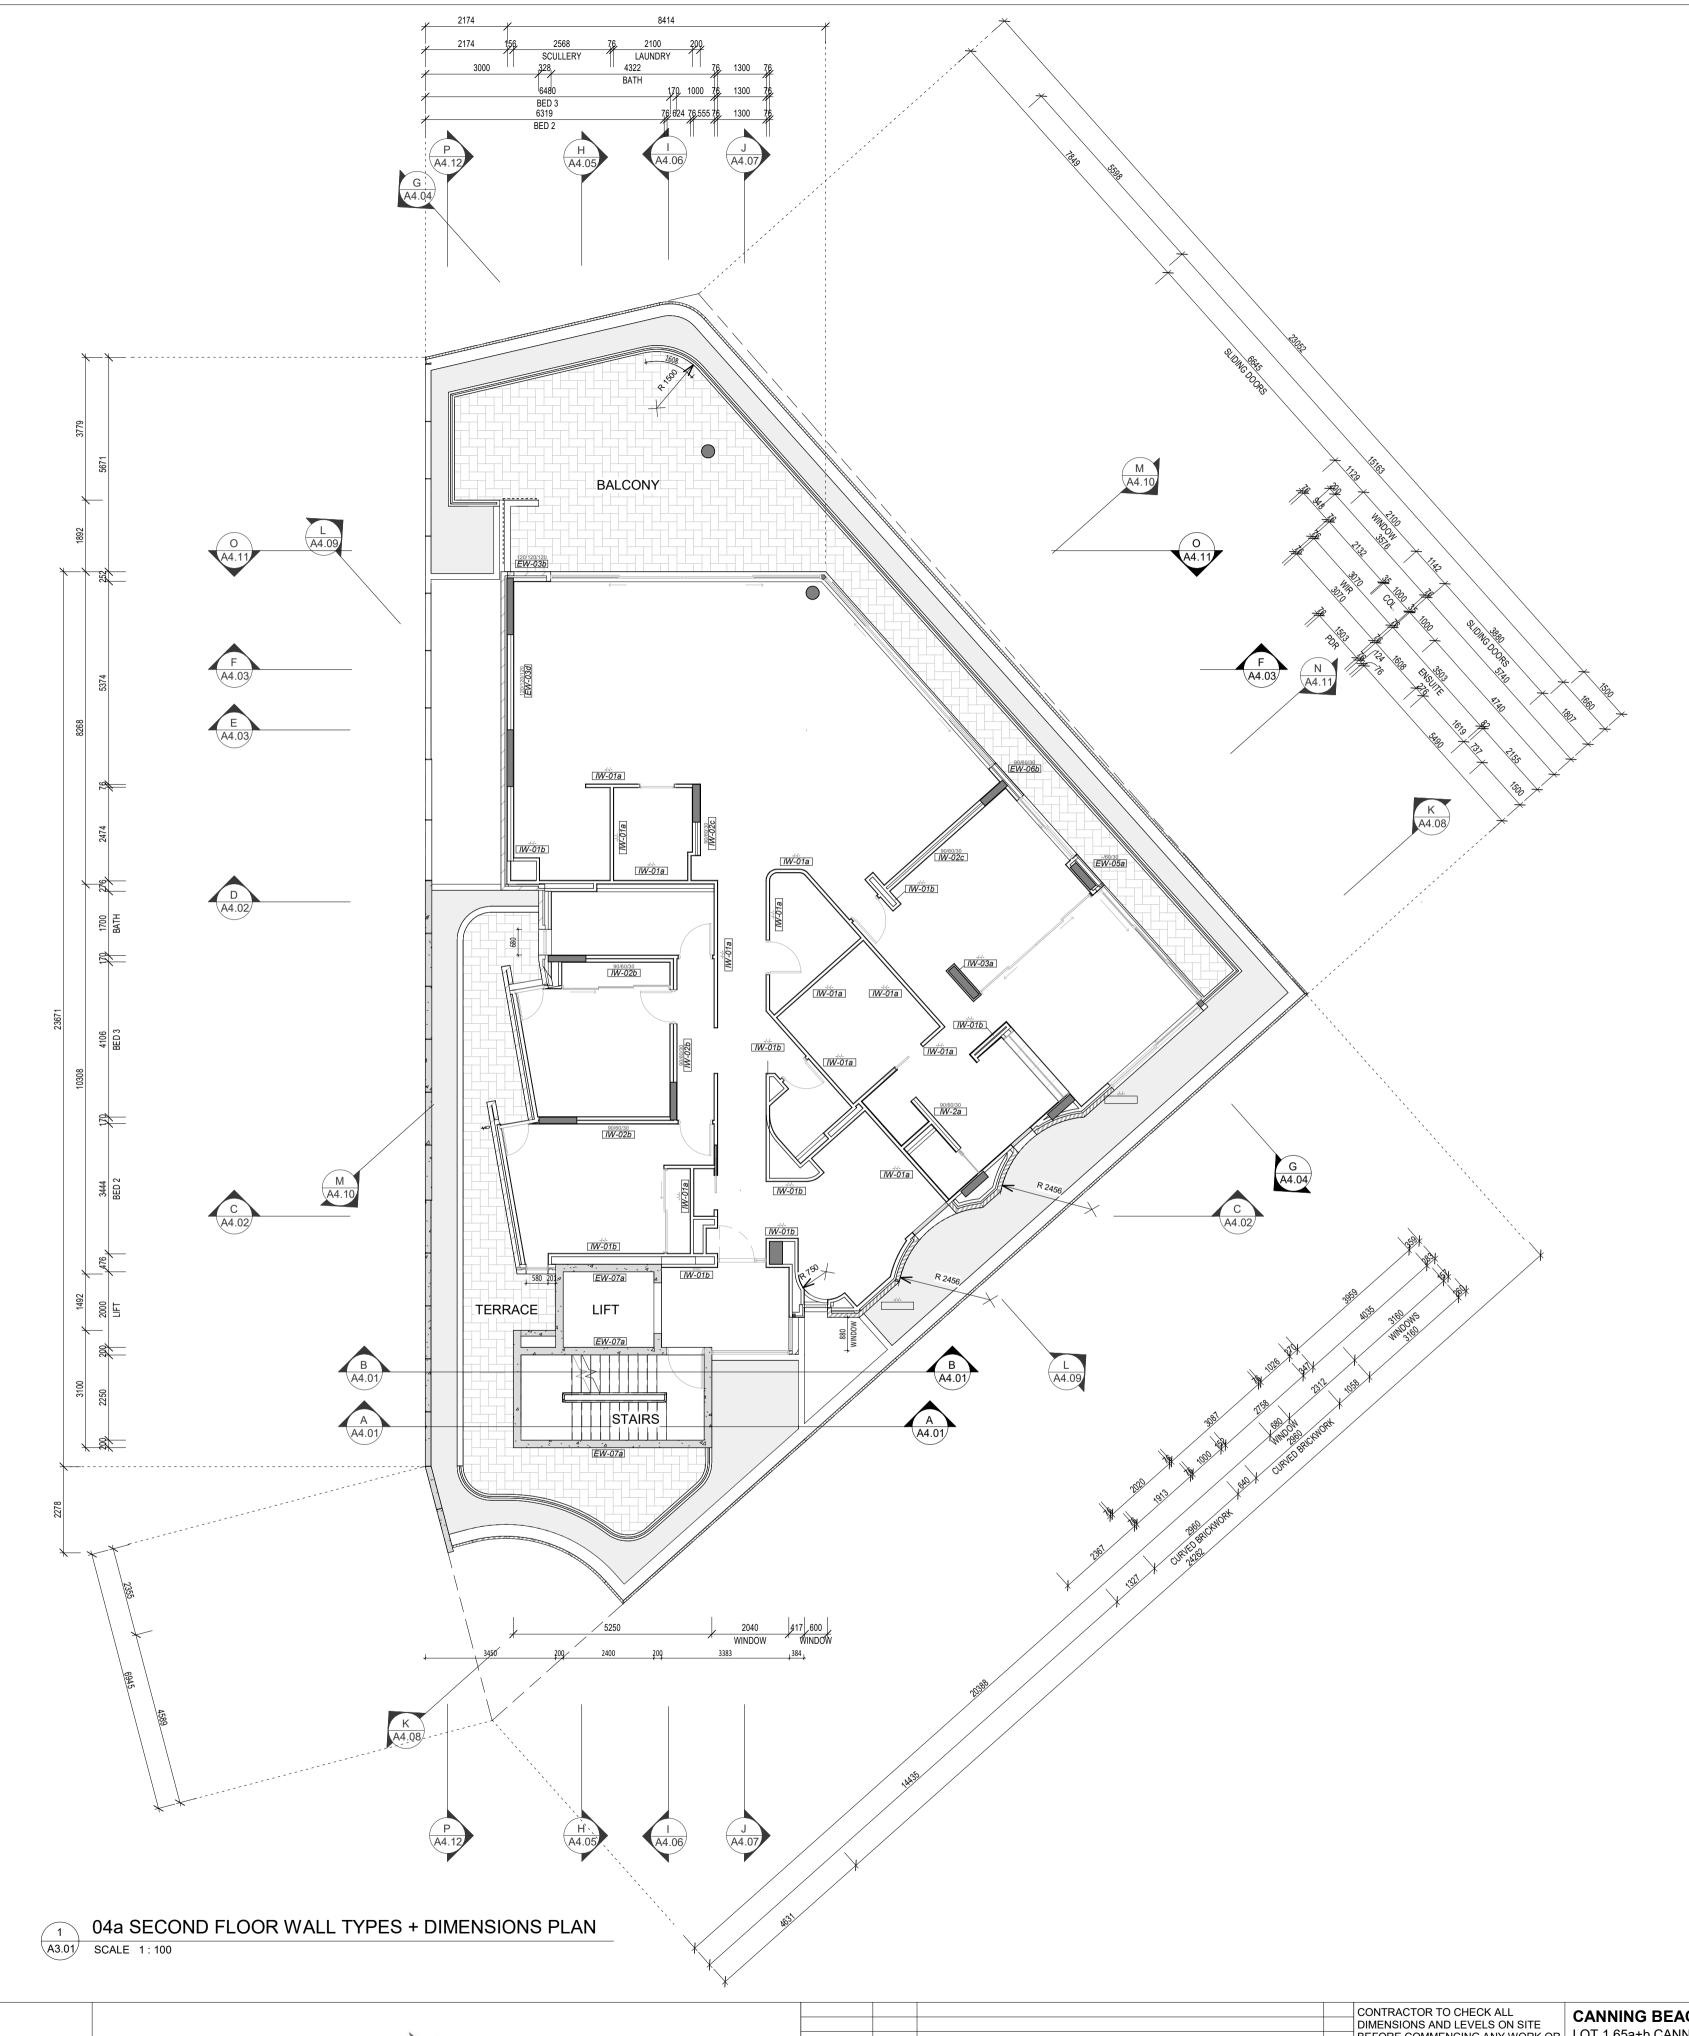

WALL TYPES SCHEDULE REFER DRAWING A2.10 FOR WALL BUILD-UP AND SYSTEM

INSULATION

- TO BE READ IN CONJUNCTION WITH ENVIRONMENTAL AND ACOUSTIC REPORTS

- REFER WALL TYPES PLANS FOR WALL INSULATION EXTENTS

- REFER REFLECTED CEILING PLANS FOR CEILING AND ROOF INSULATION EXTENTS

MINIMUM REQUIREMENTS

— — Min. R2.5 90mm 24kg/m3 ACOUSTIGARD (or approved similar)

75mm 14kg/m3 ACOUSTIGARD (or approved similar)

50mm 11kg/m3 ACOUSTIGARD (or approved similar)

FOR EXTERIOR WALL TYPES, WALL

LAYERS ARE READ FROM TOP OF PAGE TO BOTTOM OF PAGE / EXTERIOR TO INTERIOR LAYER U.N.O WET AREAS AND EXTERIOR

— — 100mm 24kg/m3 ACOUSTIGARD (or approved similar)

PLASTERBOARD / FYRCHEK TO BE MOISTURE RESISTANT. PROVIDE DEFLECTION HEAD TO ALL STUD

PROVIDE DEFLECTION HEAD TO ALL STUD FRAME WALS FRL RATINGS ARE TO MEET OR EXCEED ESD, FIRE AND ACOUSTIC REQUIREMENTS, WHICHEVER IS HIGHER. EXTERNAL LIGHTWEIGHT WALLS TO HAVE RO.2 THERMAL BREAK BETWEEN

CLADDING PANEL AND SUPPORTING FRAMING

CROSS-CHECK WITH CONSULTANT
REPORTS FOR ACOUSTIC AND THERMAL INSULATION REQUIREMENTS. REFER CONSULTANT REPORTS FOR

LAGGING TO SERVICES DUCTS, PIPES AND THE LIKE.
SERVICES TO BE DISCONTINUOUS FROM

WALLS FOR ACOUSTIC ISOLATION.
IMPACT RESISTANT LINING TO BE USED
ON LOBBY AND COMMUNAL AREA FACING
WALLS. ENSURE LINING MEET FRL
RATING AND ARE INSTALLED TO MANUFACTURER'S REQUIREMENTS TO MEET FRL.

DIMENSION NOTES:
DIMENSIONS ARE TO FACES OF STRUCTURE AND SUB-SUBTRUCTURE (e.g. STUDS) U.N.O DIMENSIONS DO NOT INCLUDE DEPTH FOR TOP HATS, BATTENS, NOGGINGS AND THE LIKE U.N.O

- REFER ELEVATIONS, SECTIONS AND INTERIOR ELEVATION

SERIES DRAWINGS FOR WALL FINISHES.

- TO BE READ IN CONJUNCTION WITH ARCHITECTURAL
MATERIALS SCHEDULE AND INTERIOR FINISHES SCHEDULE
FOR FINISHES SPECIFICATIONS AND COLOUR SELECTION. - REFER INTERIOR FINISHES SCHEDULE FOR COLOUR SCHEME ASSIGNED TO INDIVIDUAL RESIDENCES.
- NOTE: FINISHES AND COLOURS TO BE CROSS CHECKED WITH ARCHITECT PRIOR TO APPLICATION ON SITE AS PURCHASER VARIATIONS MAY AFFECT FINISHES SCHEDULES.


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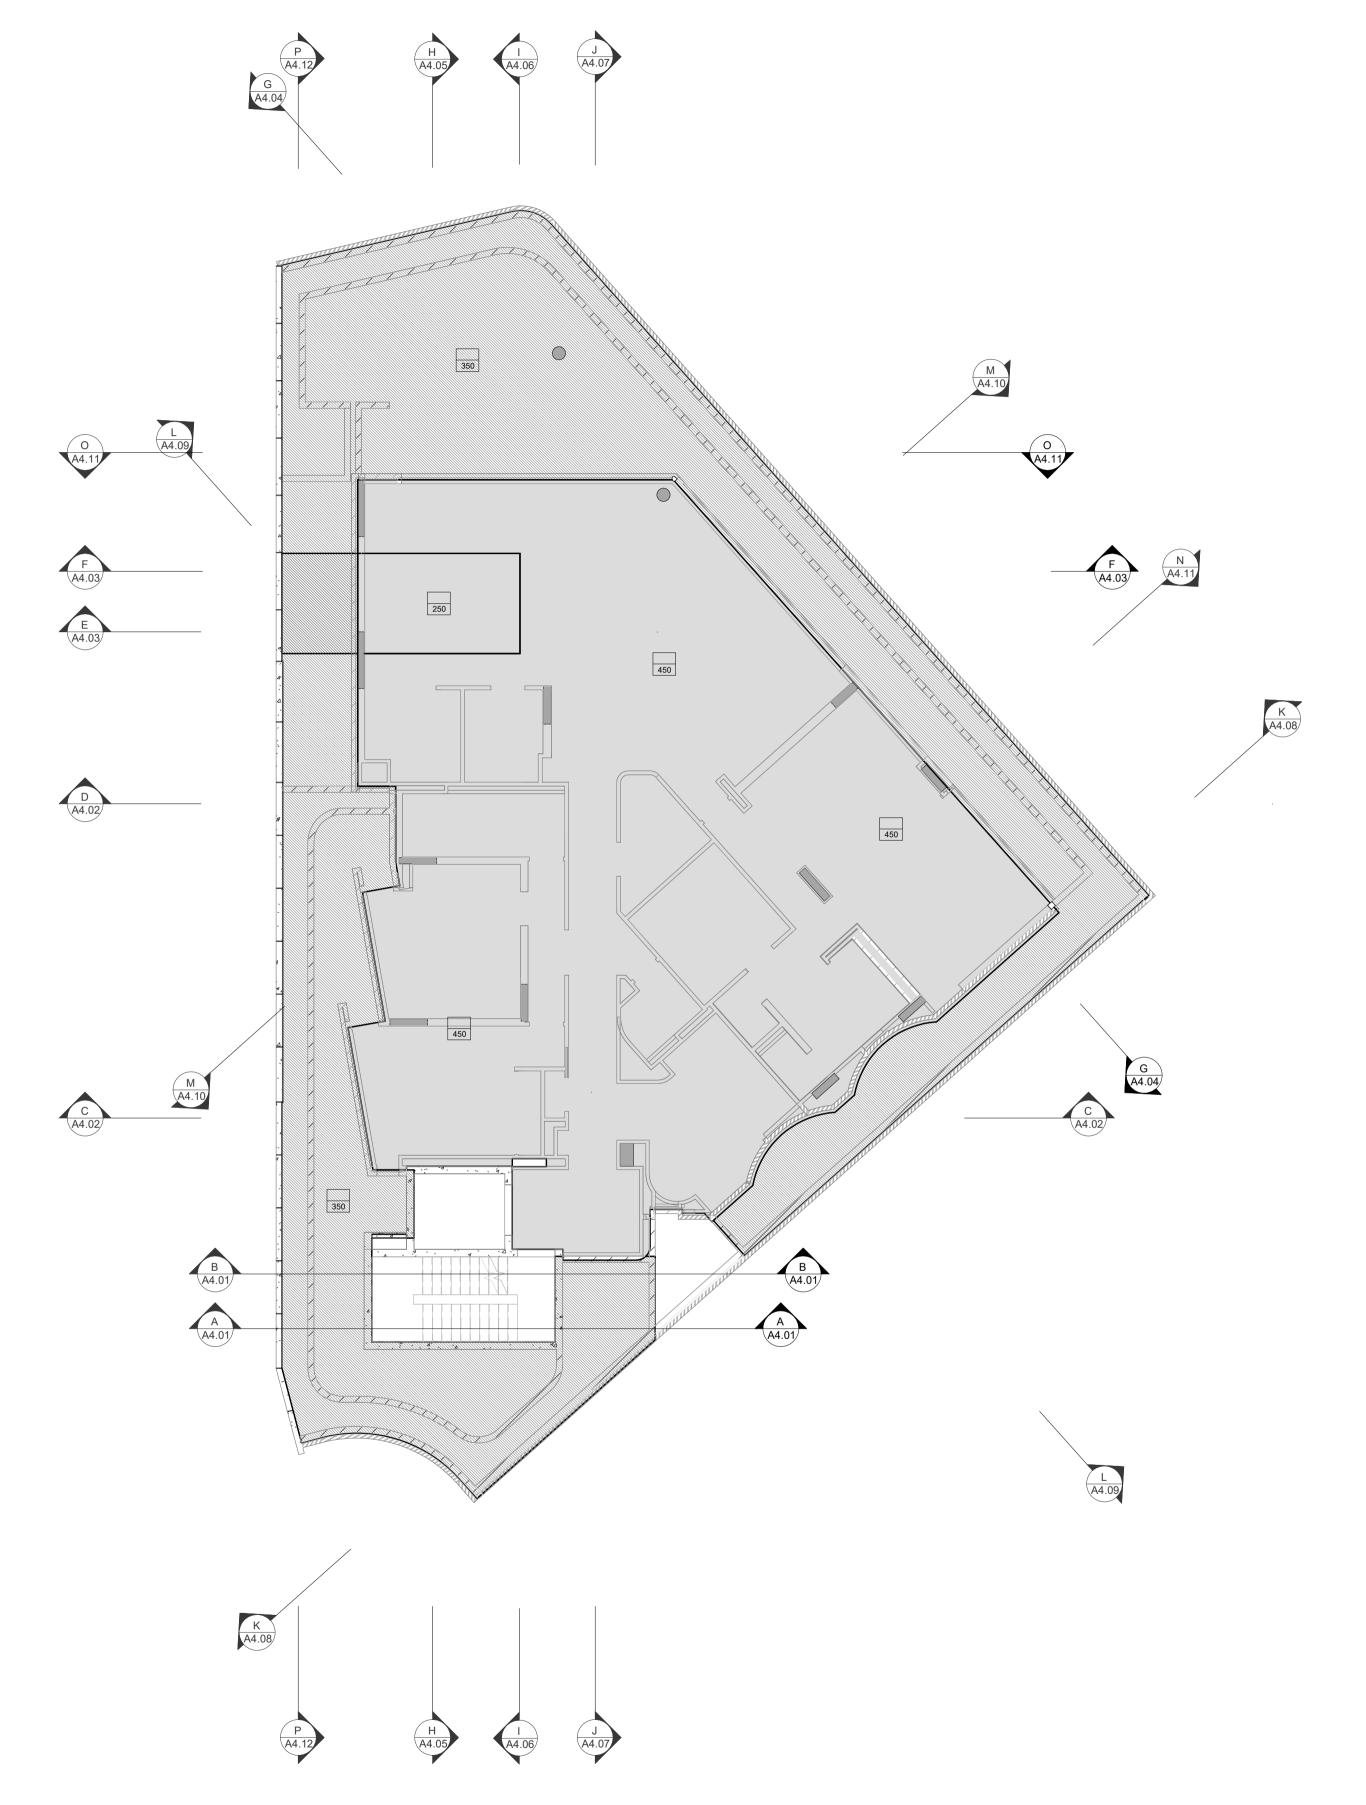
CANNING BEACH ROAD BEFORE COMMENCING ANY WORK OR LOT 1 65a+b CANNING BEACH ROAD APPLECROSS 6153 PRECEDENCE OVER MEASUREMENTS
MANUALLY SCALED OFF DRAWINGS.
LARGE SCALE DWGS TAKE

PRECEDENCE OVER SMALER SCALE

PRECEDENCE OVER SMALER SMALER SCALE

PRECEDENCE OVER SMALER SMALE

PO DESIGNED JC THIS IS A CAD DRAWING DO NOT AMEND MANUALLY CHECKED PRINCIPAL REDUCTION JUSTIN CARRIER CLIENT PROJECT CAPA PROJECT No. GRF19 No. DRAWING No. 2027 A2.04a **SCALE** 1:100 IFC PROGRESS DOCUMENTATION

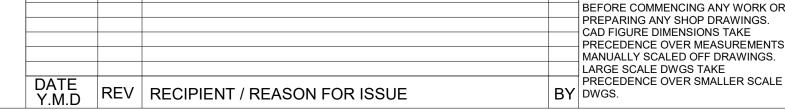

04b SECOND FLOOR SLAB SETOUT PLAN

SCALE 1:100


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CONTRACTOR TO CHECK ALL CANNING BEACH ROAD DIMENSIONS AND LEVELS ON SITE BEFORE COMMENCING ANY WORK OR LOT 1 65a+b CANNING BEACH ROAD PREPARING ANY SHOP DRAWINGS. APPLECROSS 6153 CAD FIGURE DIMENSIONS TAKE PRECEDENCE OVER MEASUREMENTS | Second Floor Slab Setout Plan

PO DESIGNED JC THIS IS A CAD DRAWING DO NOT AMEND MANUALLY DRAWN CHECKED PRINCIPAL REDUCTION DATE JUSTIN CARRIER CLIENT PROJECT CAPA PROJECT No. GRF19 No. 2 DRAWING No. 2027 A2.04b SCALE IFC PROGRESS DOCUMENTATION 1:100

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DIMENSIONS. CONTRACTOR SHALL CARRY OUT WORK IN CONFORMANCE WITH THE B.C.A./N.C.C. RELEVANT STANDARDS AND THE LOCAL AUTHORITY REQUIREMENTS. THE MAIN CONTRACTOR IS TO ENSURE THIS DRAWING IS READ IN CONJUNCTION WITH ALL RELEVANT ARCHITECTURAL, STRUCTURAL AND SERVICE CONSULTANT DOCUMENTATION TO ENSURE FULL CO-ORDINATION BETWEEN TRADES PRIOR TO WORK COMMENCEMENT. LARGE SCALE DRAWINGS SHALL TAKE PRECEDENCE OVER SMALLER SCALE DRAWINGS. CONTRACTOR SHALL CARRY OUT WORK IN CONFORMANCE WITH THE B.C.A./N.C.C. RELEVANT STANDARDS AND THE LOCAL AUTHORITY REQUIREMENTS. SEEK CLARIFICATION FROM SUPERINTENDENT FOR ANY DISCREPANCIES. ALL EXTERNAL FLOOR SURFACES TO FALL AWAY FROM REFER INTERIOR DOCUMENTATION FOR SETOUTS AND EXACT LOCATIONS OF CABINETRY, FITTINGS, FIXTURES, PLUMBING, FLOOR WASTES AND TILING. ALL MATERIALS SHALL BE NEW & COMFORM TO WHAT IS SHOWN ON THE DRAWINGS AND IN THE SCHEDULES. THE CONTRACTOR SHALL CHECK & VERIFY ALL DIMENSIONS ON SITE, PRIOR TO THE COMMENCEMENT OF ANY BUILDING WORK. ALL WINDOW DIMENSIONS ARE NOMINAL AND ARE TO BE MEASURED ON SITE.
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INSTALL FLASHINGS, EDGE TRIMS AND APPROPRIATE SEASL AS REQUIRED TO ACHIEVE WEATHER TIGHTNESS. FINISH TO BE SAME AS ADJACENT MATERIAL U.N.O. BUILDING TAG XX-XX REFER MASTER MATERIALS SCHEDULE FOR THE FOLLOWING AND MORE: 16.1 STRUCTURE SURFACE FINISHES 16.4 16.2 FIXTURES & FITTINGS 16.5 16.3 WATERPROOFING SYSTEMS 16.6 STRUCTURE SURFACE FINISHES 16.4 FINISHES FIXTURES & FITTINGS 16.5 APPLIANCES ABBREVIATION LEGEND LIN'N LDRY M/H MW O/A OAE ACDP AIR-CONDITIONING DOWNPIPE ABOVE FINISHED LAUNDRY AFFL MANHOLE MICROWAVE OVERALL OR APPROVED ABOVE FLOOR LEVEL (W/O FINISH) AGG AP APP BCJ BALU BK BW CFC AGGREGATÉ EQUIVALENT ACCESS PANEL OVERHEAD OVERFLOW **APPLIANCE** OVEN PANTRY BRICK CONTROL JOINT BALUSTRADE BARRIER KERB PLASTERBOARD BASE OF WALL (AKA BoW) COMPRESSED FIBRE POINT DRAIN (REF. HYD FOR TYPES) PLANTING LEVEL (TOP CONTROL JOINT OF MULCH) CEILING LEVEL RETURN AIR GRILLE RH RKZ (BOTTOM OF LINING) RANGEHOOD COL COLUMN RAKING RL RPZ CONC C.O.S. CU DP DU DW ENS EQ. EX. EXP FC FE FH FK FL CONCRETE RELATIVE LEVEL CONFIRM ON SITE REDUCED PRESSURE CONDENSER UNIT DOWNPIPE (AKA RWP) RAINWATER HEAD SAG SHWR SK SL SUPPLY AIR GRILLE DUCT DISHWASHER SHOWER SINK STRUCTURAL SLAB **ENSUITE** EQUAL **EXISTING** LEVEL (AKA SSL) EXPOSED FIBRE CEMENT SHEET SMK SEMI-MOUNTABLE STAINLESS STEEL FIRE HYDRANT SOIL STACK FLUSH KERB STANDARDS SOAKWELL (REF. HYD.) TO BE CONFIRMED FLOOR LEVEL W/O FINISHES (AKA SL) FFL FR FW HB HC HP HW HWS FINISHED FLOOR LEVEL FRIDGE TRANSITION KERB FLOOR WASTE TROUGH TOP OF WALL HOSECOCK (AKA TOW) HOT PLATE TYPICAL HARDWOOD HOT WATER SUPPLY **UNLESS NOTED** OTHERWISE HARDWALL PLASTER **VANITY BASIN** (FLOAT & SET) INSPECTION POINT VENT PIPE WITH W/O WS WM WITHOUT LOAD CENTRE WHEEL STOP WASHING MACHINE

GENERAL NOTES

ALL DIMENSIONS ARE IN MILLIMETRES U.N.O.

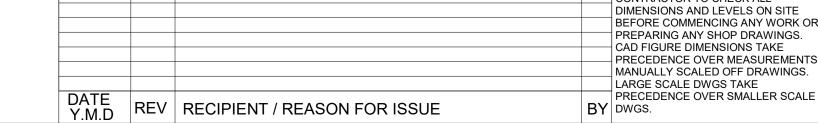WRITTEN DIMENSIONS SHALL TAKE PRECEDENCE OVER SCALED

LEGEND TYPICAL CONC. SLAB LEVEL -40mm WET AREA SETDOWN +80mm (H) HOB

-100mm LOWER EXTERNAL SLAB XXX SLAB THICKNESS

. STRUCTURAL ENGINEER DRAWINGS TAKE PRECEDENCE FOR SLAB THICKNESS AND COLUMN SIZES.

2. IF DISCREPANCIES BETWEEN ARCHITECTURAL AND STRUCTURAL DRAWINGS OCCUR, NOTIFY THE SUPERINTENDENT FOR ADVICE PRIOR TO SETOUT ON SITE. 3. FIRE COLLAR TO SERVICES PENETRATION THROUGH SLAB. TYPICAL.


4. SERVICES SHAFTS PENETRATING THROUGH S.O.U. MUST ACHIEVE FRL -/90/90. 5. CROSS CHECK SLAB SETOUT WITH WALL SETOUT DRAWINGS.

6. TYPICALLY, WET AREA SETDOWN ARE ALIGNED TO STUD FRAME FACE. PLASTERBOARD / FYRCHEK TO BE FLUSH AGAINST STUD AND SLAB SETDOWN FACE.

7. TYPICALLY, EXTERNAL SLAB STEPS ARE TO EXTERNAL FYRCHEK FACE. 8. ALLOW 500mm BETWEEN PAVING AND TOP OF FOOTING FOR HYDRUALIC

SERVICES TO BEND BELOW GROUND. 9. FOOTINGS ADJACENT TO GARDEN BEDS TO BE LOWERED TO ALLOW
MIN. 1200mm PLANTING DEPTH AT TREES AND MIN. 500mm PLANTING DEPTH FOR GENERAL PLANTING. REFER LANDSCAPE DRAWINGS FOR SOFT LANDSCAPING

PLANTING EXTENTS

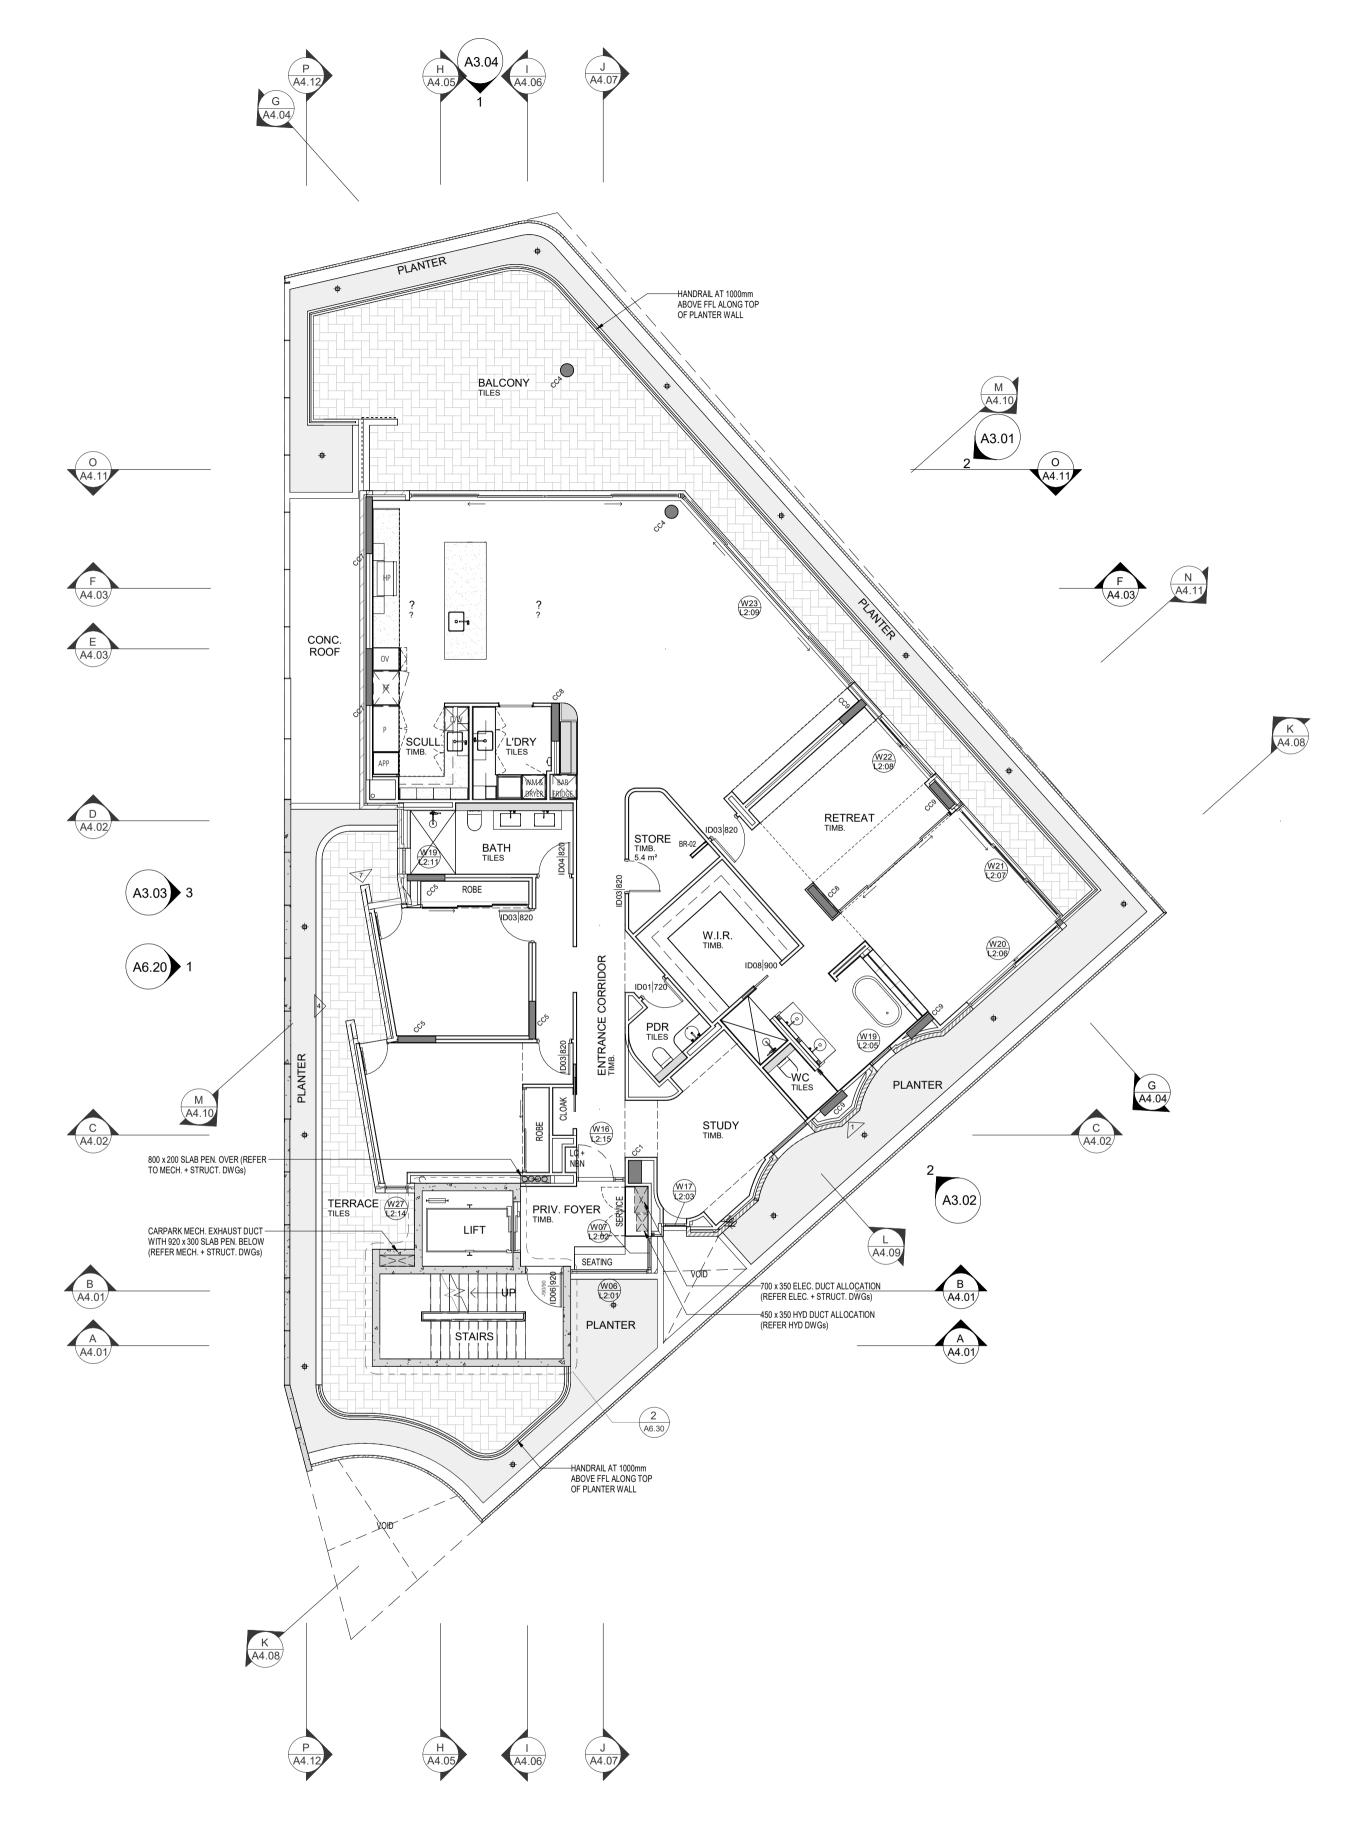

04 SECOND FLOOR GENERAL ARRANCEMENT PLAN

SCALE 1: 100

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				CAD FIGURE DIMENSIONS TAKE
				PRECEDENCE OVER MEASUREMENTS MANUALLY SCALED OFF DRAWINGS.
				LARGE SCALE DWGS TAKE
DATE Y.M.D	REV	RECIPIENT / REASON FOR ISSUE	BY	PRECEDENCE OVER SMALLER SCALE DWGS.

	CANNING BEACH ROAD
2	CANNING BEACH ROAD LOT 1 65a+b CANNING BEACH ROAD APPLECROSS 6153
	Second Floor General Arrangement Plan

INING BEACH ROAD	DRAWN	СМ	DESIGNED	JC	THIS IS A CAD DRAW DO NOT AMEND MAN	
1 65a+b CANNING BEACH ROAD	CHECKED	JC	PRINCIPAL		REDUCTION 30mm@A1	
.ECROSS 6153	DATE		JUSTIN CARRIE	15mm@A3		
nd Floor General Arrangement Plan	CLIENT PROJECT	CT GRF19	CAPA PROJECT No.	2027	DRAWING No.	RE
IFC PROGRESS DOCUMENTATION	SCALE 1:100				A2.04	

GENERAL NOTES

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DIMENSIONS.
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REFER MASTER MATERIALS SCHEDULE FOR THE FOLLOWING AND MORE:


16.1 STRUCTURE SURFACE FINISHES 16.4 FINISHES

16.2 FIXTURES & FITTINGS 16.5 APPLIANCES

16.3 WATERPROOFING SYSTEMS 16.6 TRIMS

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DISCREPANCIES.
ALL EXTERNAL FLOOR SURFACES TO FALL AWAY FROM

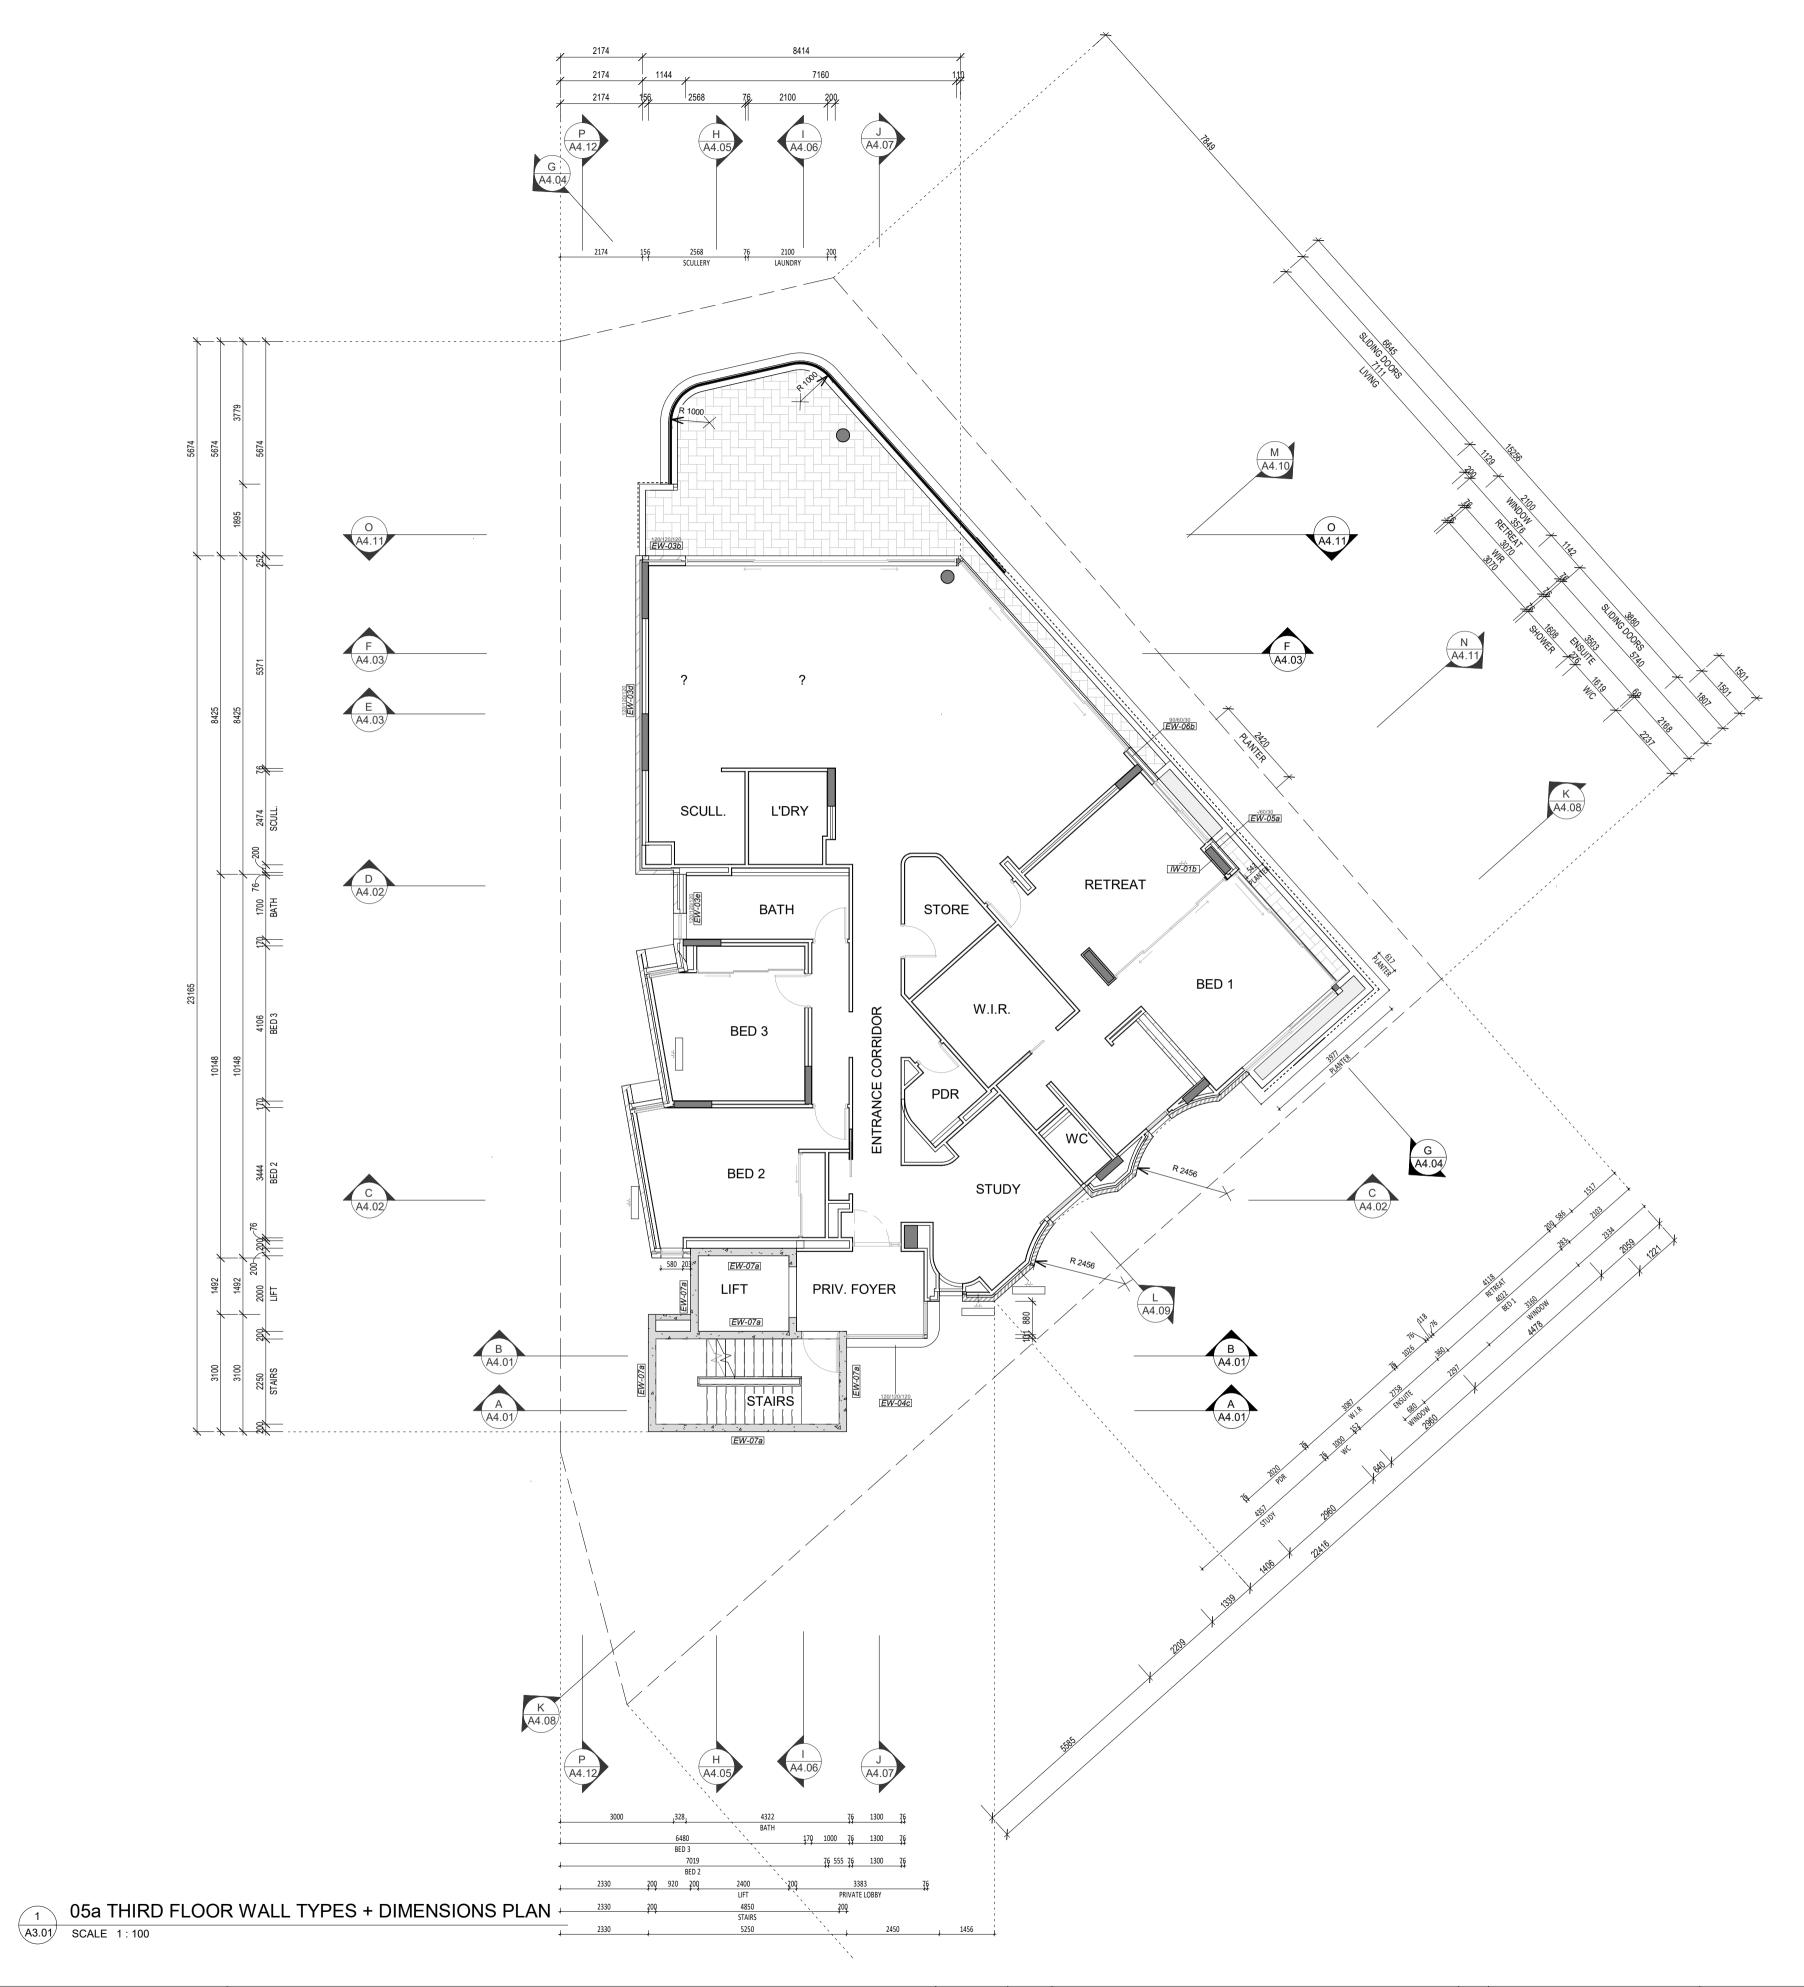


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CANNING BEACH ROAD BEFORE COMMENCING ANY WORK OR LOT 1 65a+b CANNING BEACH ROAD APPLECROSS 6153

CONTRACTOR TO CHECK ALL

PRECEDENCE OVER MEASUREMENTS
MANUALLY SCALED OFF DRAWINGS.
LARGE SCALE DWGS TAKE

LARGE SCALE DWGS TAKE IFC PROGRESS DOCUMENTATION

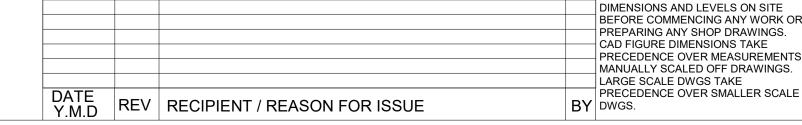PO DESIGNED JC THIS IS A CAD DRAWING DO NOT AMEND MANUALLY CHECKED PRINCIPAL REDUCTION JUSTIN CARRIER CLIENT PROJECT CAPA PROJECT No. GRF19 No. 2 DRAWING No. 2027 A2.05a **SCALE** 1:100

WALL TYPES SCHEDULE REFER DRAWING A2.10 FOR WALL BUILD-UP AND SYSTEM

INSULATION

- TO BE READ IN CONJUNCTION WITH ENVIRONMENTAL AND ACOUSTIC REPORTS

- REFER WALL TYPES PLANS FOR WALL INSULATION EXTENTS

- REFER REFLECTED CEILING PLANS FOR CEILING AND ROOF INSULATION EXTENTS

— — Min. R2.5 90mm 24kg/m3 ACOUSTIGARD (or approved similar)

50mm 11kg/m3 ACOUSTIGARD (or approved similar) — — 100mm 24kg/m3 ACOUSTIGARD (or approved similar)

> FOR EXTERIOR WALL TYPES, WALL LAYERS ARE READ FROM TOP OF PAGE TO BOTTOM OF PAGE / EXTERIOR TO

PROVIDE DEFLECTION HEAD TO ALL STUD

FRL RATINGS ARE TO MEET OR EXCEED ESD, FIRE AND ACOUSTIC
REQUIREMENTS, WHICHEVER IS HIGHER.
EXTERNAL LIGHTWEIGHT WALLS TO HAVE

CROSS-CHECK WITH CONSULTANT
REPORTS FOR ACOUSTIC AND THERMAL

SERVICES TO BE DISCONTINUOUS FROM WALLS FOR ACOUSTIC ISOLATION.

IMPACT RESISTANT LINING TO BE USED
ON LOBBY AND COMMUNAL AREA FACING
WALLS. ENSURE LINING MEET FRL
RATING AND ARER INSTALLED TO

MANUFACTURER'S REQUIREMENTS TO

DIMENSION NOTES:
DIMENSIONS ARE TO FACES OF STRUCTURE AND SUB-SUBTRUCTURE (e.g. STUDS) U.N.O DIMENSIONS DO NOT INCLUDE DEPTH FOR TOP HATS, BATTENS, NOGGINGS AND THE LIKE U.N.O

- REFER ELEVATIONS, SECTIONS AND INTERIOR ELEVATION

- REFER INTERIOR FINISHES SCHEDULE FOR COLOUR SCHEME ASSIGNED TO INDIVIDUAL RESIDENCES.
- NOTE: FINISHES AND COLOURS TO BE CROSS CHECKED WITH

ARCHITECT PRIOR TO APPLICATION ON SITE AS PURCHASER VARIATIONS MAY AFFECT FINISHES SCHEDULES.

SERIES DRAWINGS FOR WALL FINISHES. - TO BE READ IN CONJUNCTION WITH ARCHITECTURAL MATERIALS SCHEDULE AND INTERIOR FINISHES SCHEDULE FOR FINISHES SPECIFICATIONS AND COLOUR SELECTION.

R0.2 THERMAL BREAK BETWEEN CLADDING PANEL AND SUPPORTING

INSULATION REQUIREMENTS. REFER CONSULTANT REPORTS FOR LAGGING TO SERVICES DUCTS, PIPES

INTERIOR LAYER U.N.O WET AREAS AND EXTERIOR PLASTERBOARD / FYRCHEK TO BE

MOISTURE RESISTANT.

FRAME WALS


FRAMING


AND THE LIKE.

MEET FRL.

75mm 14kg/m3 ACOUSTIGARD (or approved similar)

MINIMUM REQUIREMENTS

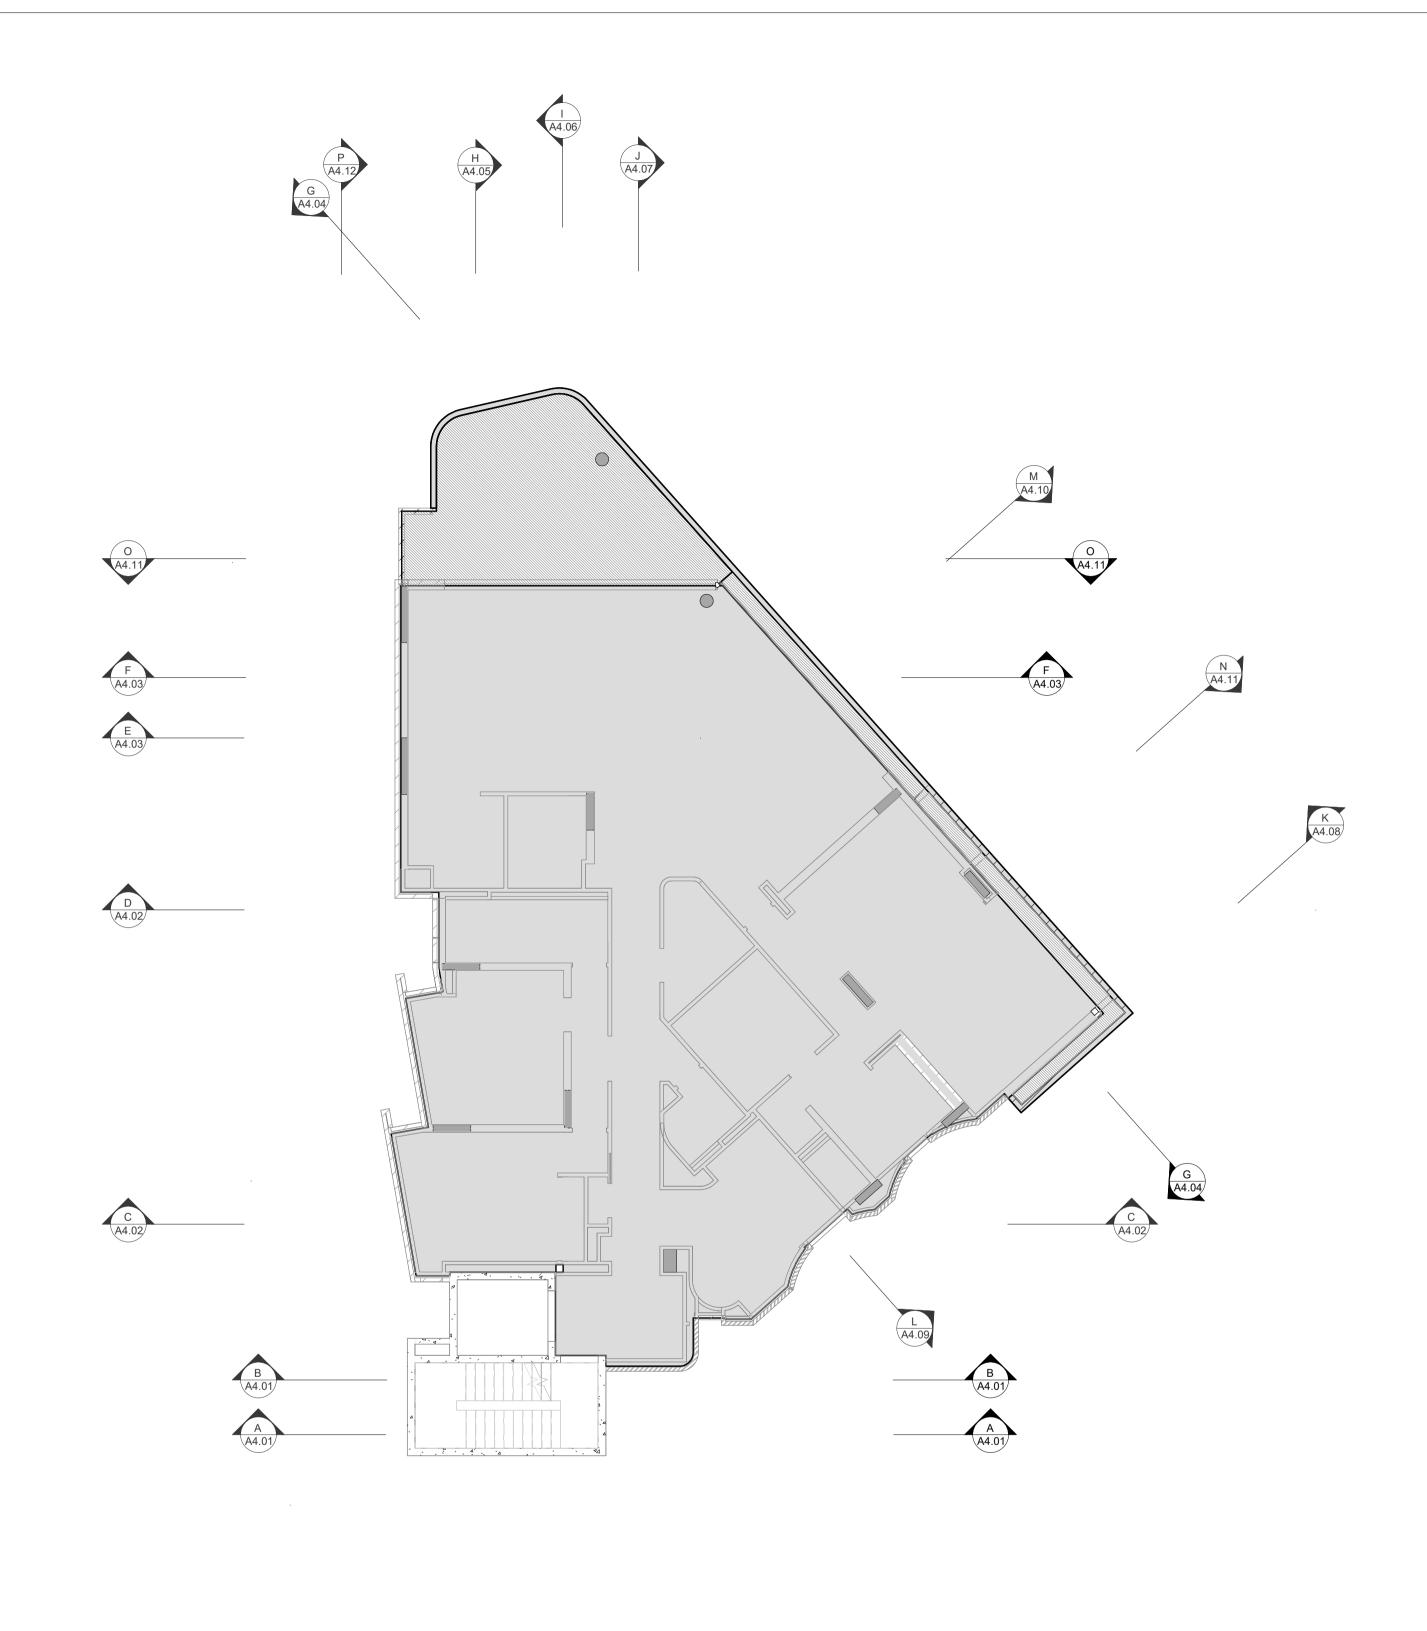

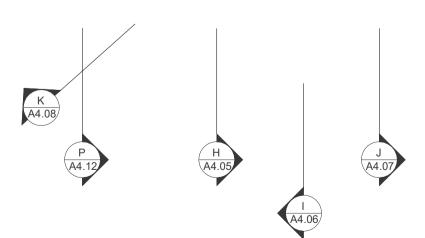

05b THIRD FLOOR SLAB SETOUT PLAN

A3.01 SCALE 1:100



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CANNING BEACH ROAD BEFORE COMMENCING ANY WORK OR LOT 1 65a+b CANNING BEACH ROAD

JC THIS IS A CAD DRAWING DO NOT AMEND MANUALLY PO DESIGNED CHECKED PRINCIPAL REDUCTION JUSTIN CARRIER CLIENT PROJECT CAPA PROJECT No. GRF19 No. 2 DRAWING No. 2027

A2.05b

REV | RECIPIENT / REASON FOR ISSUE BY DWGS.

SCALE IFC PROGRESS DOCUMENTATION 1:100

<u>LEGEND</u>

TYPICAL CONC. SLAB LEVEL

AND COLUMN SIZES.

MUST ACHIEVE FRL -/90/90.

AND SLAB SETDOWN FACE.

PLANTING EXTENTS

SERVICES TO BEND BELOW GROUND.

-40mm WET AREA SETDOWN

-100mm LOWER EXTERNAL SLAB XXX SLAB THICKNESS

. STRUCTURAL ENGINEER DRAWINGS TAKE PRECEDENCE FOR SLAB THICKNESS

2. IF DISCREPANCIES BETWEEN ARCHITECTURAL AND STRUCTURAL DRAWINGS OCCUR, NOTIFY THE SUPERINTENDENT FOR ADVICE PRIOR TO SETOUT ON SITE.

3. FIRE COLLAR TO SERVICES PENETRATION THROUGH SLAB. TYPICAL.

CROSS CHECK SLAB SETOUT WITH WALL SETOUT DRAWINGS.
 TYPICALLY, WET AREA SETDOWN ARE ALIGNED TO STUD FRAME FACE.

7. TYPICALLY, EXTERNAL SLAB STEPS ARE TO EXTERNAL FYRCHEK FACE. 8. ALLOW 500mm BETWEEN PAVING AND TOP OF FOOTING FOR HYDRUALIC

MIN. 1200mm PLANTING DEPTH AT TREES AND MIN. 500mm PLANTING DEPTH FOR

GENERAL PLANTING. REFER LANDSCAPE DRAWINGS FOR SOFT LANDSCAPING

9. FOOTINGS ADJACENT TO GARDEN BEDS TO BE LOWERED TO ALLOW

4. SERVICES SHAFTS PENETRATING THROUGH S.O.U.

PLASTERBOARD / FYRCHEK TO BE FLUSH AGAINST STUD

GENERAL NOTES

DIMENSIONS.

ALL DIMENSIONS ARE IN MILLIMETRES U.N.O.

AUTHORITY REQUIREMENTS.

WORK COMMENCEMENT.

FLOOR WASTES AND TILING.

CONDITIONS & ACCESS REQUIREMENTS.

SAME AS ADJACENT MATERIAL U.N.O.

BUILDING TAG XX-XX

ABBREVIATION LEGEND

AGGREGATÉ

APPLIANCE

ACCESS PANEL

CONTROL JOINT

CONFIRM ON SITE

CONDENSER UNIT

DOWNPIPE (AKA RWP)

EXPOSED FIBRE CEMENT SHEET

FIRE EXTINGUISHER

FLOOR LEVEL W/O FINISHES (AKA SL) FINISHED FLOOR LEVEL

HARDWOOD HOT WATER SUPPLY

(FLOAT & SET) INSPECTION POINT

LOAD CENTRE

HARDWALL PLASTER

FIRE HYDRANT FLUSH KERB

FRIDGE FLOOR WASTE

HOSECOCK

HOT PLATE

(BOTTOM OF LINING)

CEILING LEVEL

COLUMN

DUCT DISHWASHER

ENSUITE EQUAL **EXISTING**

CONCRETE

AIR-CONDITIONING DOWNPIPE ABOVE FINISHED

ABOVE FLOOR LEVEL (W/O FINISH)

BRICK CONTROL JOINT BALUSTRADE BARRIER KERB

BASE OF WALL (AKA BoW) COMPRESSED FIBRE

ACDP

AFFL

AGG AP APP BCJ BALU BK BW CFC

COL

CONC C.O.S.

CU DP DU ENS EQ. EX. FC FE FH FK FL

WRITTEN DIMENSIONS SHALL TAKE PRECEDENCE OVER SCALED

CONTRACTOR SHALL CARRY OUT WORK IN CONFORMANCE WITH THE B.C.A./N.C.C. RELEVANT STANDARDS AND THE LOCAL

THE MAIN CONTRACTOR IS TO ENSURE THIS DRAWING IS READ IN CONJUNCTION WITH ALL RELEVANT ARCHITECTURAL, STRUCTURAL AND SERVICE CONSULTANT DOCUMENTATION TO ENSURE FULL CO-ORDINATION BETWEEN TRADES PRIOR TO

LARGE SCALE DRAWINGS SHALL TAKE PRECEDENCE OVER SMALLER SCALE DRAWINGS. CONTRACTOR SHALL CARRY OUT WORK IN CONFORMANCE WITH THE B.C.A./N.C.C. RELEVANT STANDARDS AND THE LOCAL AUTHORITY REQUIREMENTS. SEEK CLARIFICATION FROM SUPERINTENDENT FOR ANY DISCREPANCIES. ALL EXTERNAL FLOOR SURFACES TO FALL AWAY FROM

REFER INTERIOR DOCUMENTATION FOR SETOUTS AND EXACT LOCATIONS OF CABINETRY, FITTINGS, FIXTURES, PLUMBING,

REFER TO WALL TYPES PLANS FOR WALL SETOUTS.
REFER SLAB SETOUT PLANS FOR SLAB AND STRUCTURAL COLUMN SETOUTS.
ENSURE ALL STRUCTURAL STEEL COLUMNS WITHIN 3m OF SITE BOUNDARY TO BE FIRE PROTECTED TO CODES AND STANDARDS.
INSTALL FLASHINGS, EDGE TRIMS AND APPROPRIATE SEASL AS REQUIRED TO ACHIEVE WEATHER TIGHTNESS. FINISH TO BE

REFER MASTER MATERIALS SCHEDULE FOR THE FOLLOWING AND MORE:

LIN'N LDRY M/H MW

O/A OAE

RH RKZ

RPZ

SAG SHWR SK

SMK

W/O WS WM

LAUNDRY

MANHOLE MICROWAVE OVERALL OR APPROVED

EQUIVALENT OVERHEAD

PLASTERBOARD

POINT DRAIN (REF. HYD FOR TYPES) PLANTING LEVEL (TOP

RETURN AIR GRILLE

REDUCED PRESSURE

RAINWATER HEAD

SUPPLY AIR GRILLE

LEVEL (AKA SSL)

SEMI-MOUNTABLE

STAINLESS STEEL SOIL STACK STANDARDS

TRANSITION KERB

TROUGH TOP OF WALL

TYPICAL

(AKA TOW)

UNLESS NOTED OTHERWISE

VANITY BASIN

WHEEL STOP WASHING MACHINE

VENT PIPE WITH

WITHOUT

SOAKWELL (REF. HYD.) TO BE CONFIRMED

OVERFLOW

OF MULCH)

RAKING

SHOWER SINK STRUCTURAL SLAB


RANGEHOOD

RELATIVE LEVEL

OVEN PANTRY

16.1 STRUCTURE SURFACE FINISHES 16.4 FINISHES
16.2 FIXTURES & FITTINGS 16.5 APPLIANCES
16.3 WATERPROOFING SYSTEMS 16.6 TRIMS

ALL MATERIALS SHALL BE NEW & COMFORM TO WHAT IS SHOWN ON THE DRAWINGS AND IN THE SCHEDULES. THE CONTRACTOR SHALL CHECK & VERIFY ALL DIMENSIONS ON SITE, PRIOR TO THE COMMENCEMENT OF ANY BUILDING WORK. ALL WINDOW DIMENSIONS ARE NOMINAL AND ARE TO BE MEASURED ON SITE.
THE CONTRACTOR SHALL VISIT THE SITE & NOTE ALL SITE

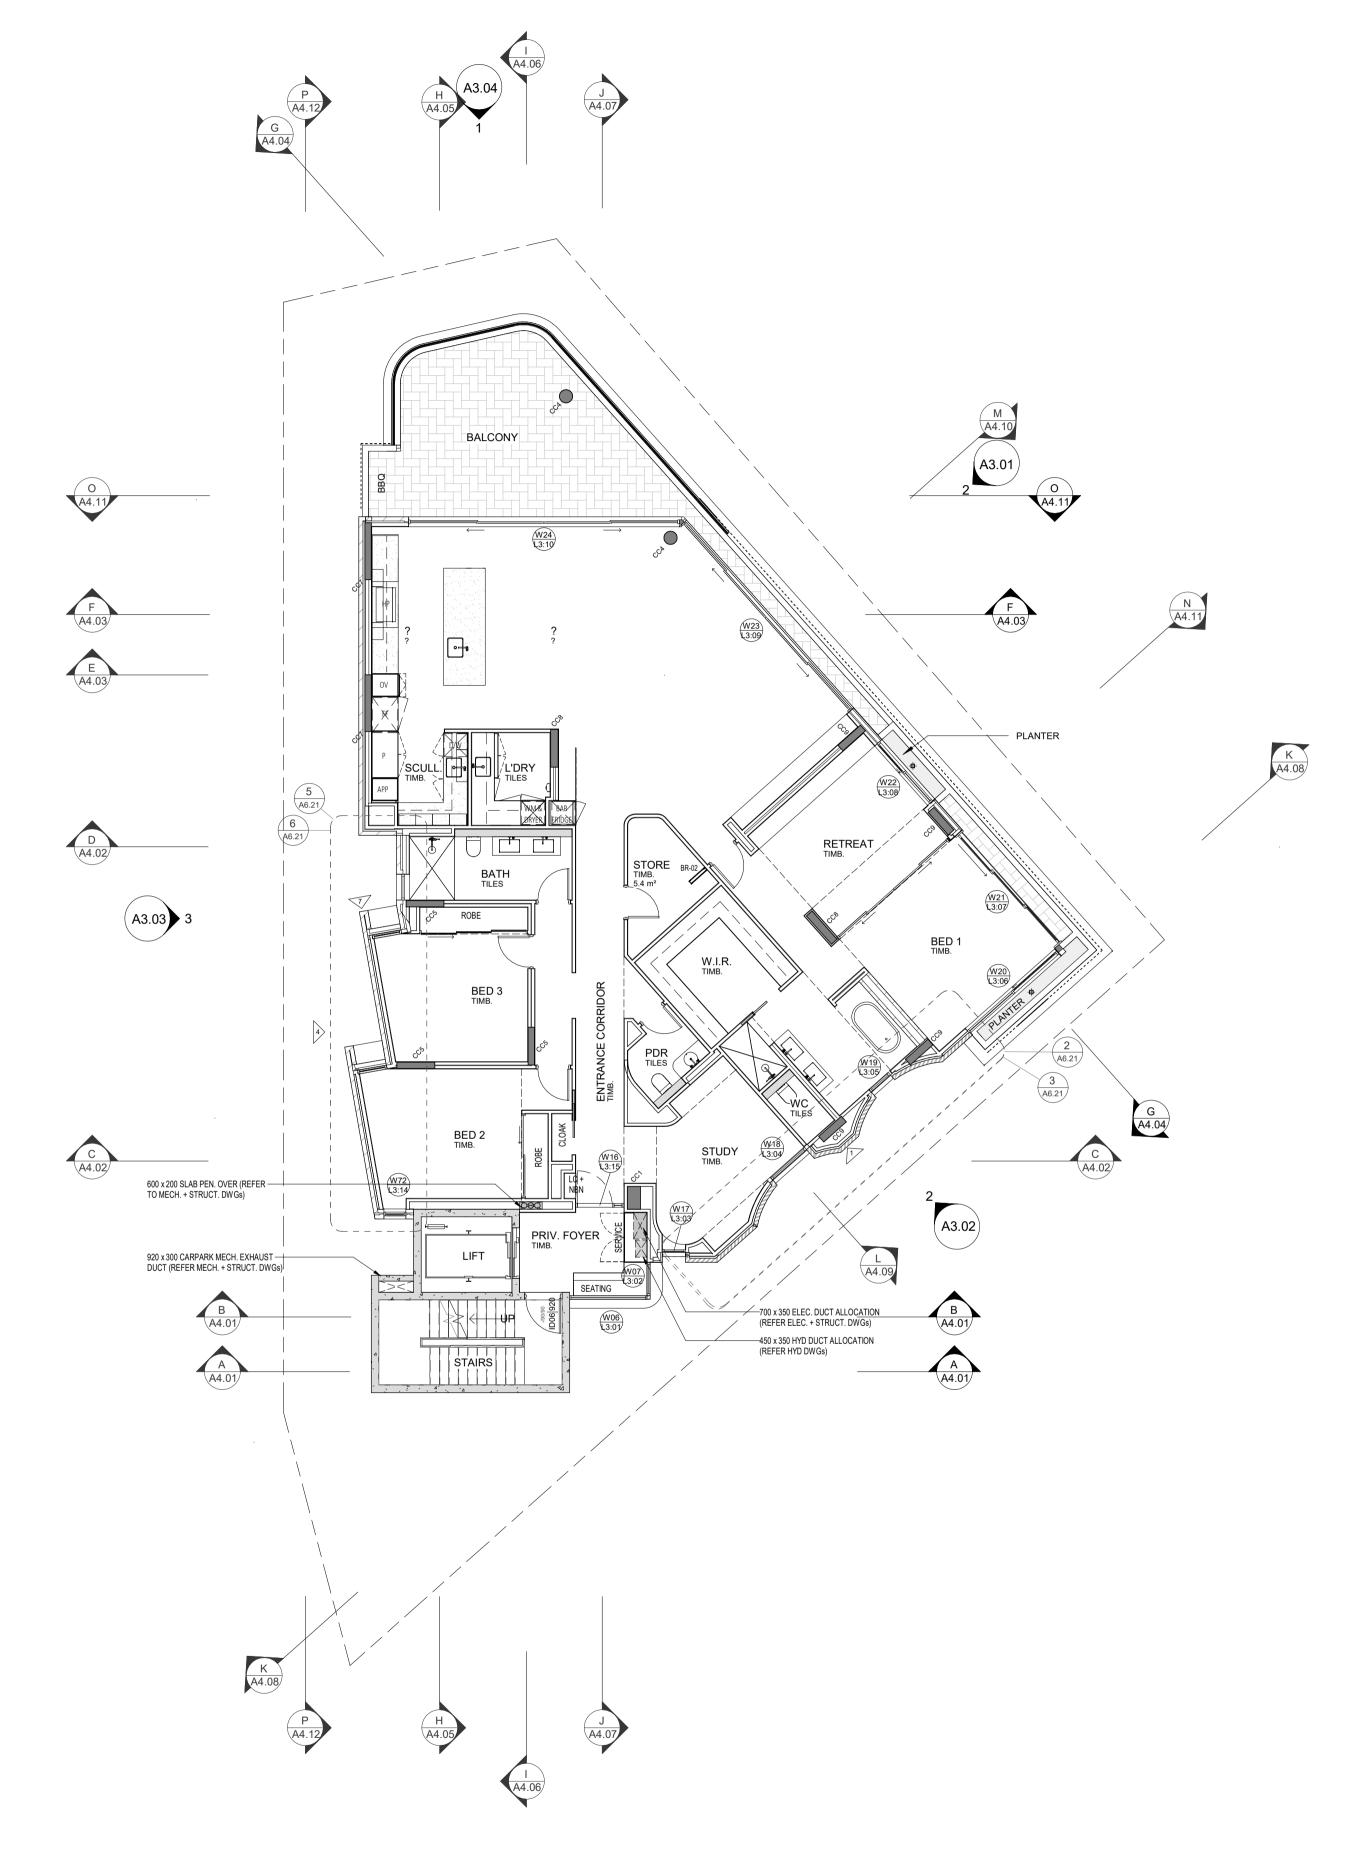

05 THIRD FLOOR GENERAL ARRANCEMENT PLAN
SCALE 1:100

Architecture + Landscape

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				CONTRACTOR TO CHECK ALL
				DIMENSIONS AND LEVELS ON SITE
				BEFORE COMMENCING ANY WORK OR
				PREPARING ANY SHOP DRAWINGS.
				CAD FIGURE DIMENSIONS TAKE
				PRECEDENCE OVER MEASUREMENTS
	n			MANUALLY SCALED OFF DRAWINGS. LARGE SCALE DWGS TAKE
	U			
DATE Y.M.D	REV	RECIPIENT / REASON FOR ISSUE	BY	PRECEDENCE OVER SMALLER SCALE DWGS.

	CANNING BEACH ROAD
3	CANNING BEACH ROAD LOT 1 65a+b CANNING BEACH ROAD APPLECROSS 6153
3	Third Floor General Arrangement Plan

NING BEACH ROAD	DRAWN	СМ	DESIGNED	JC	THIS IS A CAD DRAW DO NOT AMEND MAN	
65a+b CANNING BEACH ROAD	CHECKED	JC	PRINCIPAL		REDUCTION	
ECROSS 6153	DATE		JUSTIN CARRIE	R	30mm@A1 15mm@A3	
Floor General Arrangement Plan	CLIENT PROJECT	CT GRF19	CAPA PROJECT No.	2027	DRAWING No.	REV
IFC PROGRESS DOCUMENTATION	SCALE 1: 100				A2.05	0

GENERAL NOTES

ALL DIMENSIONS ARE IN MILLIMETRES U.N.O. WRITTEN DIMENSIONS SHALL TAKE PRECEDENCE OVER SCALED DIMENSIONS.

DIMENSIONS.
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ENSURE FULL CO-ORDINATION BETWEEN TRADES PRIOR TO WORK COMMENCEMENT.

WORK COMMENCEMENT.

LARGE SCALE DRAWINGS SHALL TAKE PRECEDENCE OVER
SMALLER SCALE DRAWINGS. CONTRACTOR SHALL CARRY OUT
WORK IN CONFORMANCE WITH THE B.C.A./N.C.C. RELEVANT
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SEEK CLARIFICATION FROM SUPERINTENDENT FOR ANY

ALL EXTERNAL FLOOR SURFACES TO FALL AWAY FROM BUILDING.
REFER INTERIOR DOCUMENTATION FOR SETOUTS AND EXACT LOCATIONS OF CABINETRY, FITTINGS, FIXTURES, PLUMBING, FLOOR WASTES AND TILING.
ALL MATERIALS SHALL BE NEW & COMFORM TO WHAT IS SHOWN ON THE DRAWINGS AND IN THE SCHEDULES.
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THE CONTRACTOR SHALL VISIT THE SITE & NOTE ALL SITE CONDITIONS & ACCESS REQUIREMENTS.


REFER TO WALL TYPES PLANS FOR WALL SETOUTS.

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16.1 STRUCTURE SURFACE FINISHES 16.4 FINISHES
16.2 FIXTURES & FITTINGS 16.5 APPLIANCES
16.3 WATERPROOFING SYSTEMS 16.6 TRIMS

REFER SLAB SETOUT PLANS FOR SLAB AND STRUCTURAL COLUMN SETOUTS.
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DISCREPANCIES.
ALL EXTERNAL FLOOR SURFACES TO FALL AWAY FROM



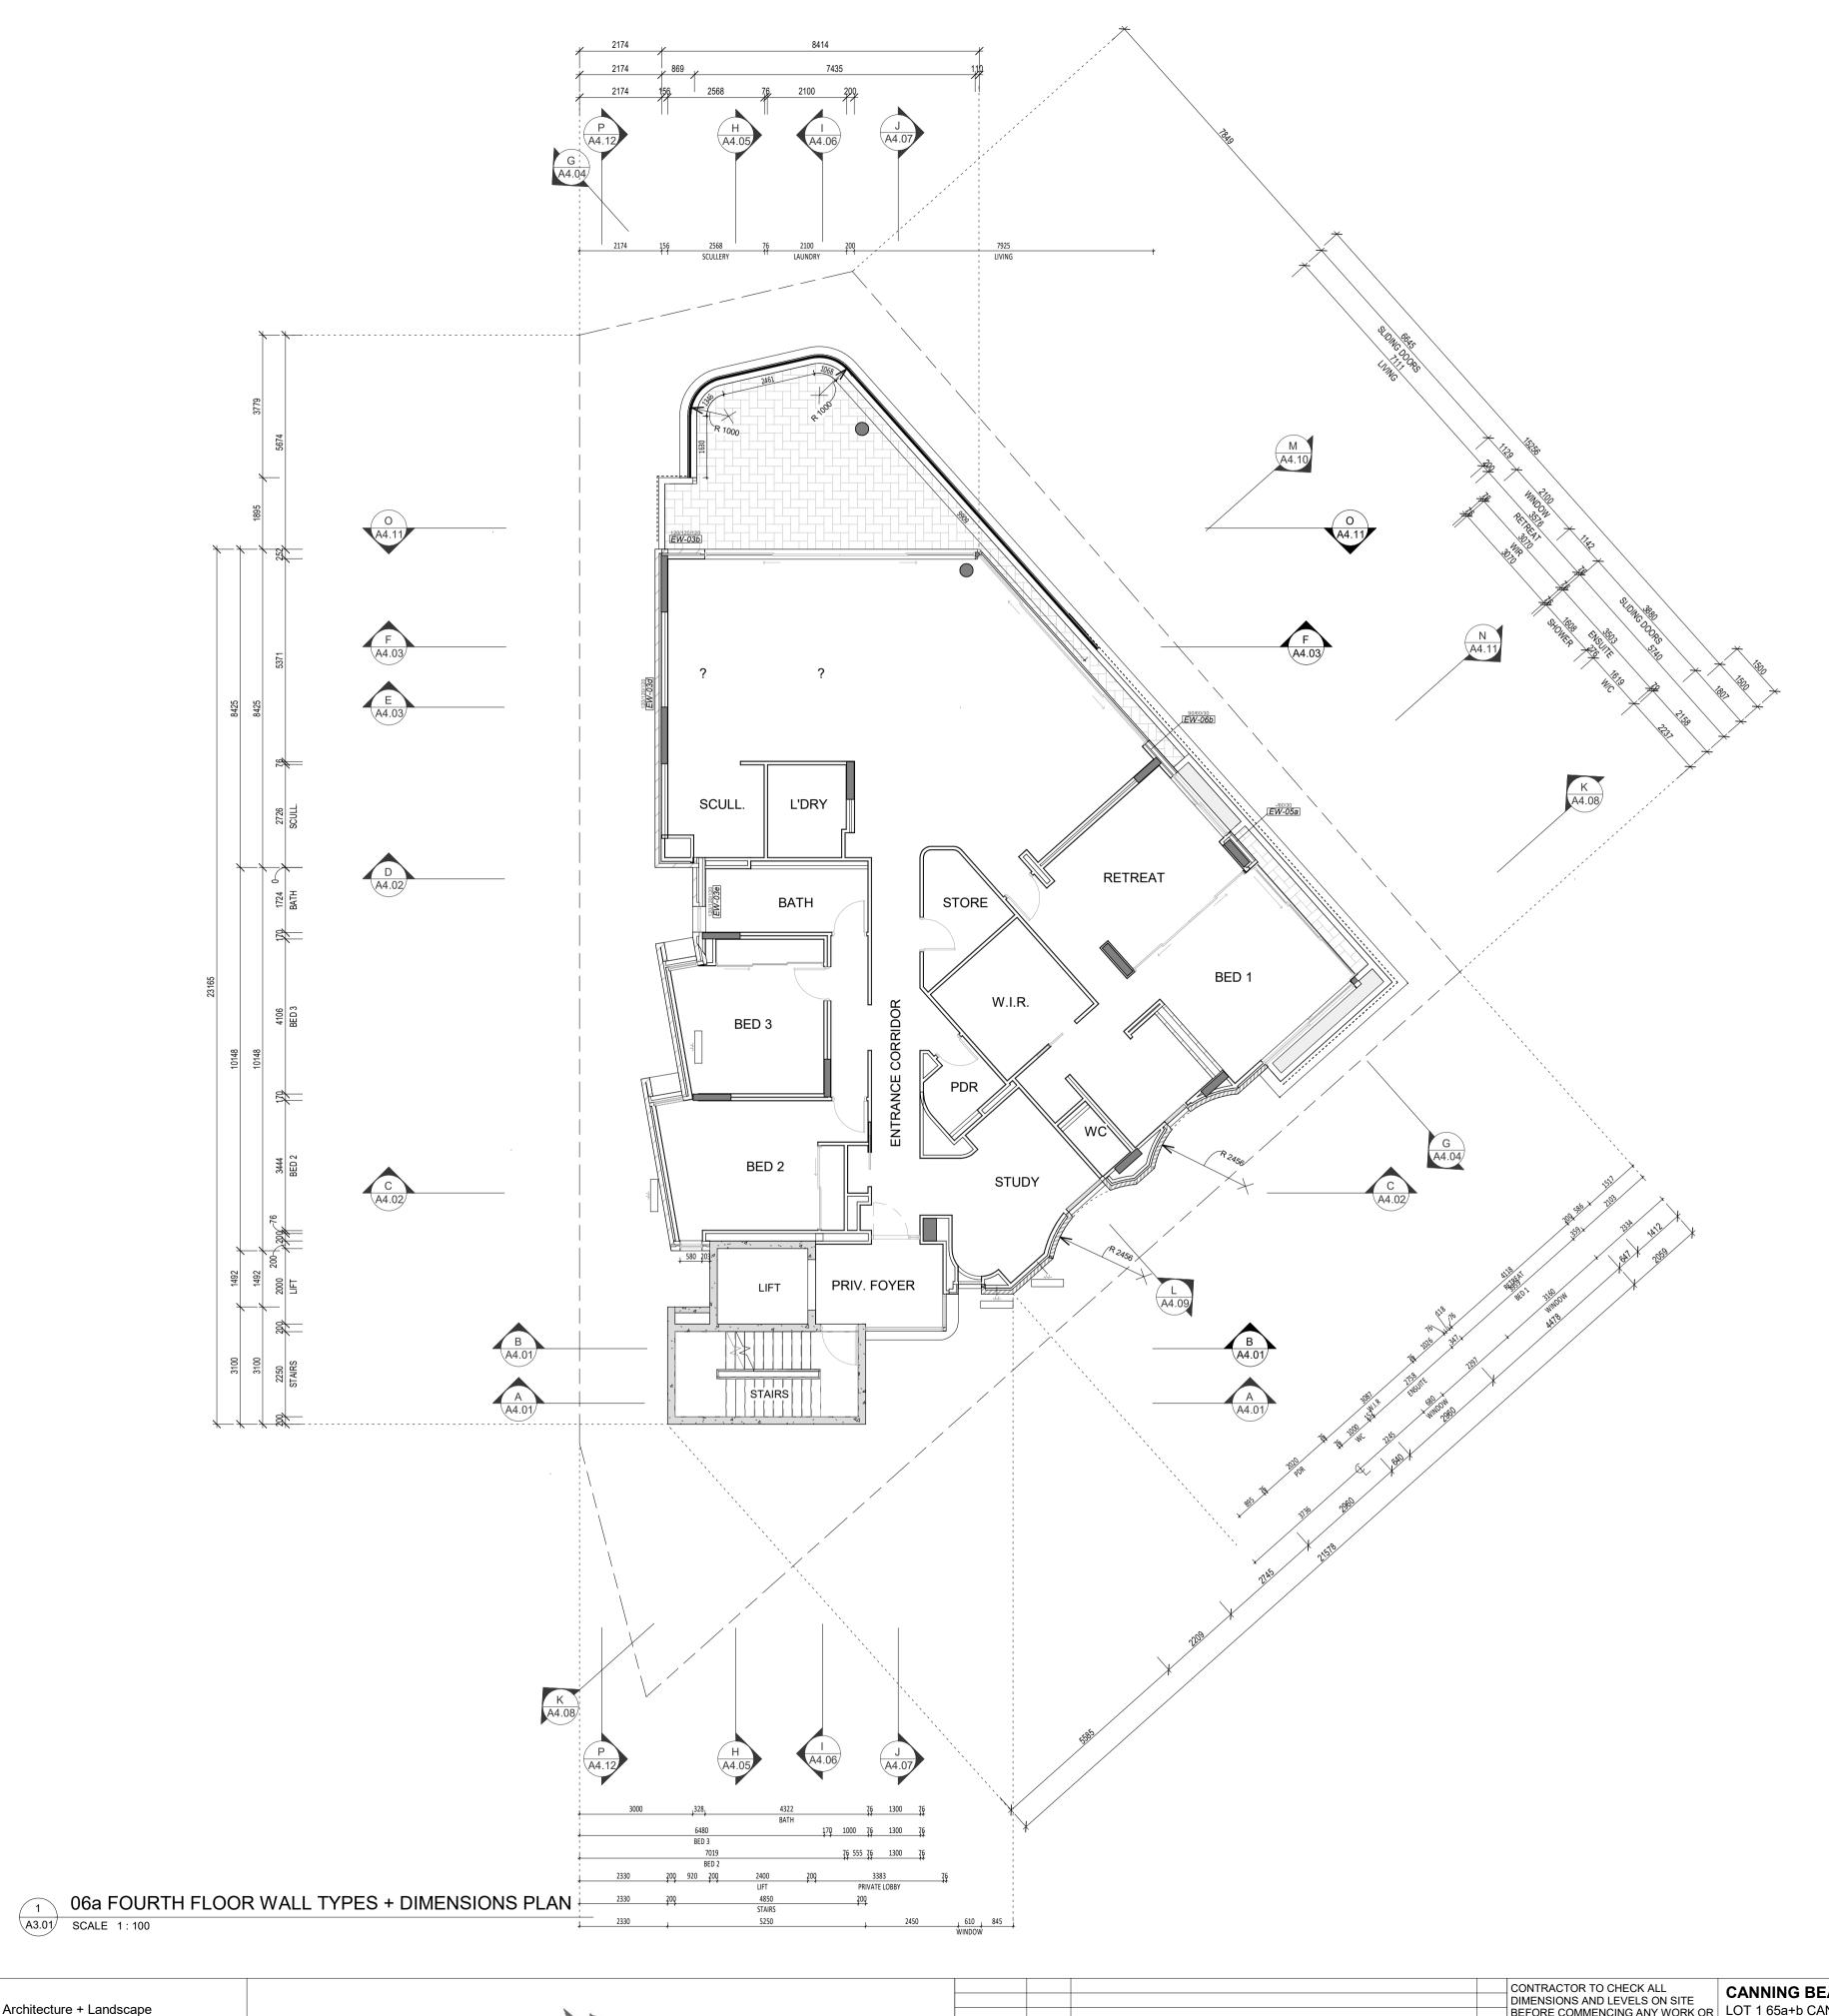

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PREPARING ANY SHOP DRAWINGS.
CAD FIGURE DIMENSIONS TAKE
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MANUALLY SCALED OFF DRAWINGS.
LARGE SCALE DWGS TAKE
PRECEDENCE OVER SMALLER SCALE
DWGS.

CANNING BEACH ROAD
LOT 1 65a+b CANNING BEACH ROAD
APPLECROSS 6153
Fourth Floor Wall Type + Dimension Plan

IFC PROGRESS DOCUMENTATION

DRAWN
Author DESIGNED
Designed NOT AMEND MANUALLY

CHECKED
Checker RINCIPAL
DATE

Floor Wall Type + Dimension Plan

CLIENT PROJECT
No. GRF19

CAPA PROJECT
No. GRF19

CAPA PROJECT
No. REV.

A2.06a

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DESIGNED
Designed NOT AMEND MANUALLY

REDUCTION


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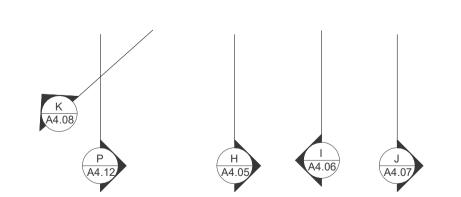
REDUCTION

REV.

A2.06a

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1 06b FOURTH FLOOR SLAB SETOUT PLAN
A3.01 SCALE 1:100

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				CAD FIGURE DIMENSIONS TAKE PRECEDENCE OVER MEASUREMENTS MANUALLY SCALED OFF DRAWINGS.
				LARGE SCALE DWGS TAKE
DATE Y.M.D	REV	RECIPIENT / REASON FOR ISSUE	BY	PRECEDENCE OVER SMALLER SCALE DWGS.

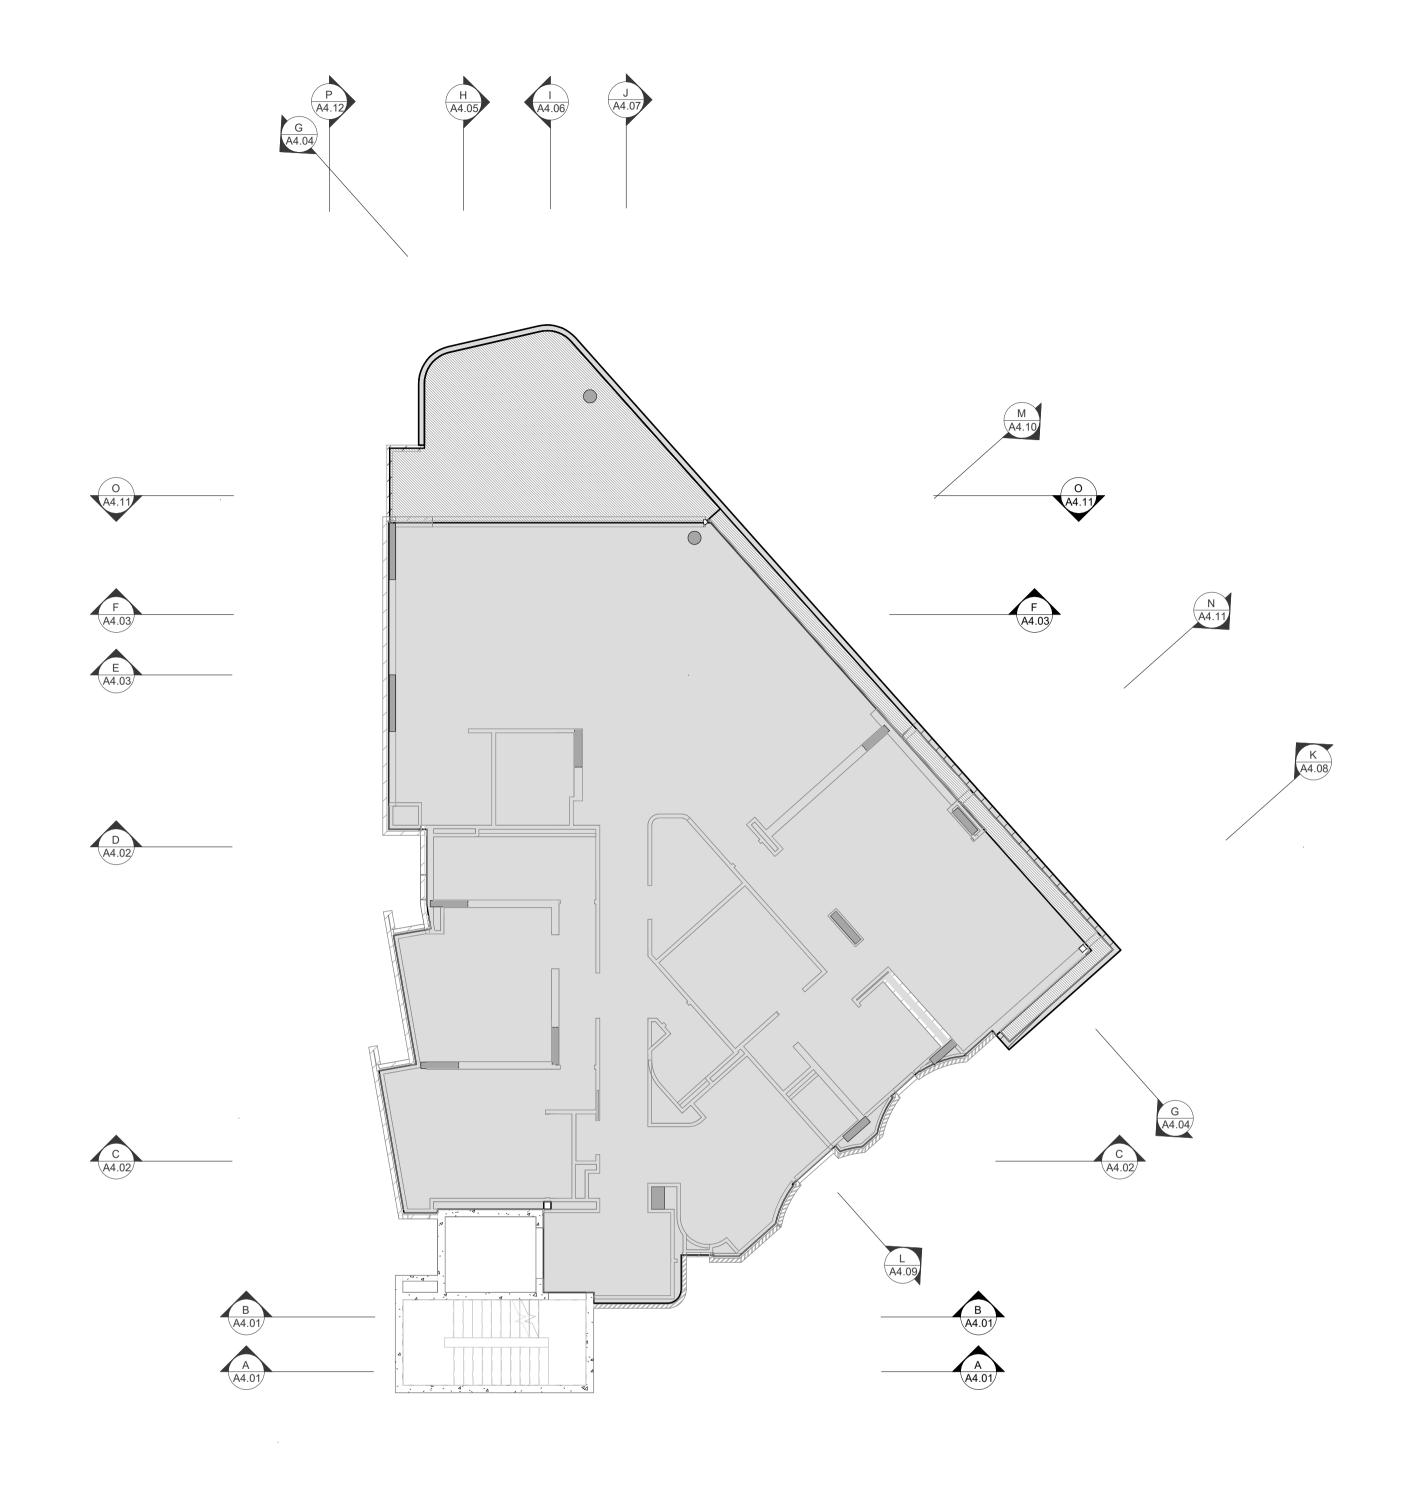CANNING BEACH ROAD R LOT 1 65a+b CANNING BEACH ROAD APPLECROSS 6153

THIS IS A CAD DRAWING Designed NOT AMEND MANUALLY Author DESIGNED Checker CHECKED REDUCTION DATE JUSTIN CARRIER Fourth Floor Slab Setout Plan CLIENT PROJECT CAPA PROJECT No. GRF19 No. 20 DRAWING No. 2027 A2.06b **SCALE** 1: 100 IFC PROGRESS DOCUMENTATION

LEGEND

TYPICAL CONC. SLAB LEVEL

-40mm WET AREA SETDOWN +80mm (H) HOB

-100mm LOWER EXTERNAL SLAB XXX SLAB THICKNESS

STRUCTURAL ENGINEER DRAWINGS TAKE PRECEDENCE FOR SLAB THICKNESS AND COLUMN SIZES.
 IF DISCREPANCIES BETWEEN ARCHITECTURAL AND STRUCTURAL DRAWINGS.

3. FIRE COLLAR TO SERVICES PENETRATION THROUGH SLAB. TYPICAL.

7. TYPICALLY, EXTERNAL SLAB STEPS ARE TO EXTERNAL FYRCHEK FACE. 8. ALLOW 500mm BETWEEN PAVING AND TOP OF FOOTING FOR HYDRUALIC SERVICES TO BEND BELOW GROUND.

9. FOOTINGS ADJACENT TO GARDEN BEDS TO BE LOWERED TO ALLOW

5. CROSS CHECK SLAB SETOUT WITH WALL SETOUT DRAWINGS. TYPICALLY, WET AREA SETDOWN ARE ALIGNED TO STUD FRAME FACE. PLASTERBOARD / FYRCHEK TO BE FLUSH AGAINST STUD

SERVICES SHAFTS PENETRATING THROUGH S.O.U.
 MUST ACHIEVE FRL -/90/90.


AND SLAB SETDOWN FACE.

PLANTING EXTENTS

OCCUR, NOTIFY THE SUPERINTENDENT FOR ADVICE PRIOR TO SETOUT ON SITE.

MIN. 1200mm PLANTING DEPTH AT TREES AND MIN. 500mm PLANTING DEPTH FOR GENERAL PLANTING. REFER LANDSCAPE DRAWINGS FOR SOFT LANDSCAPING

15/11/2022 2:05:17 PM

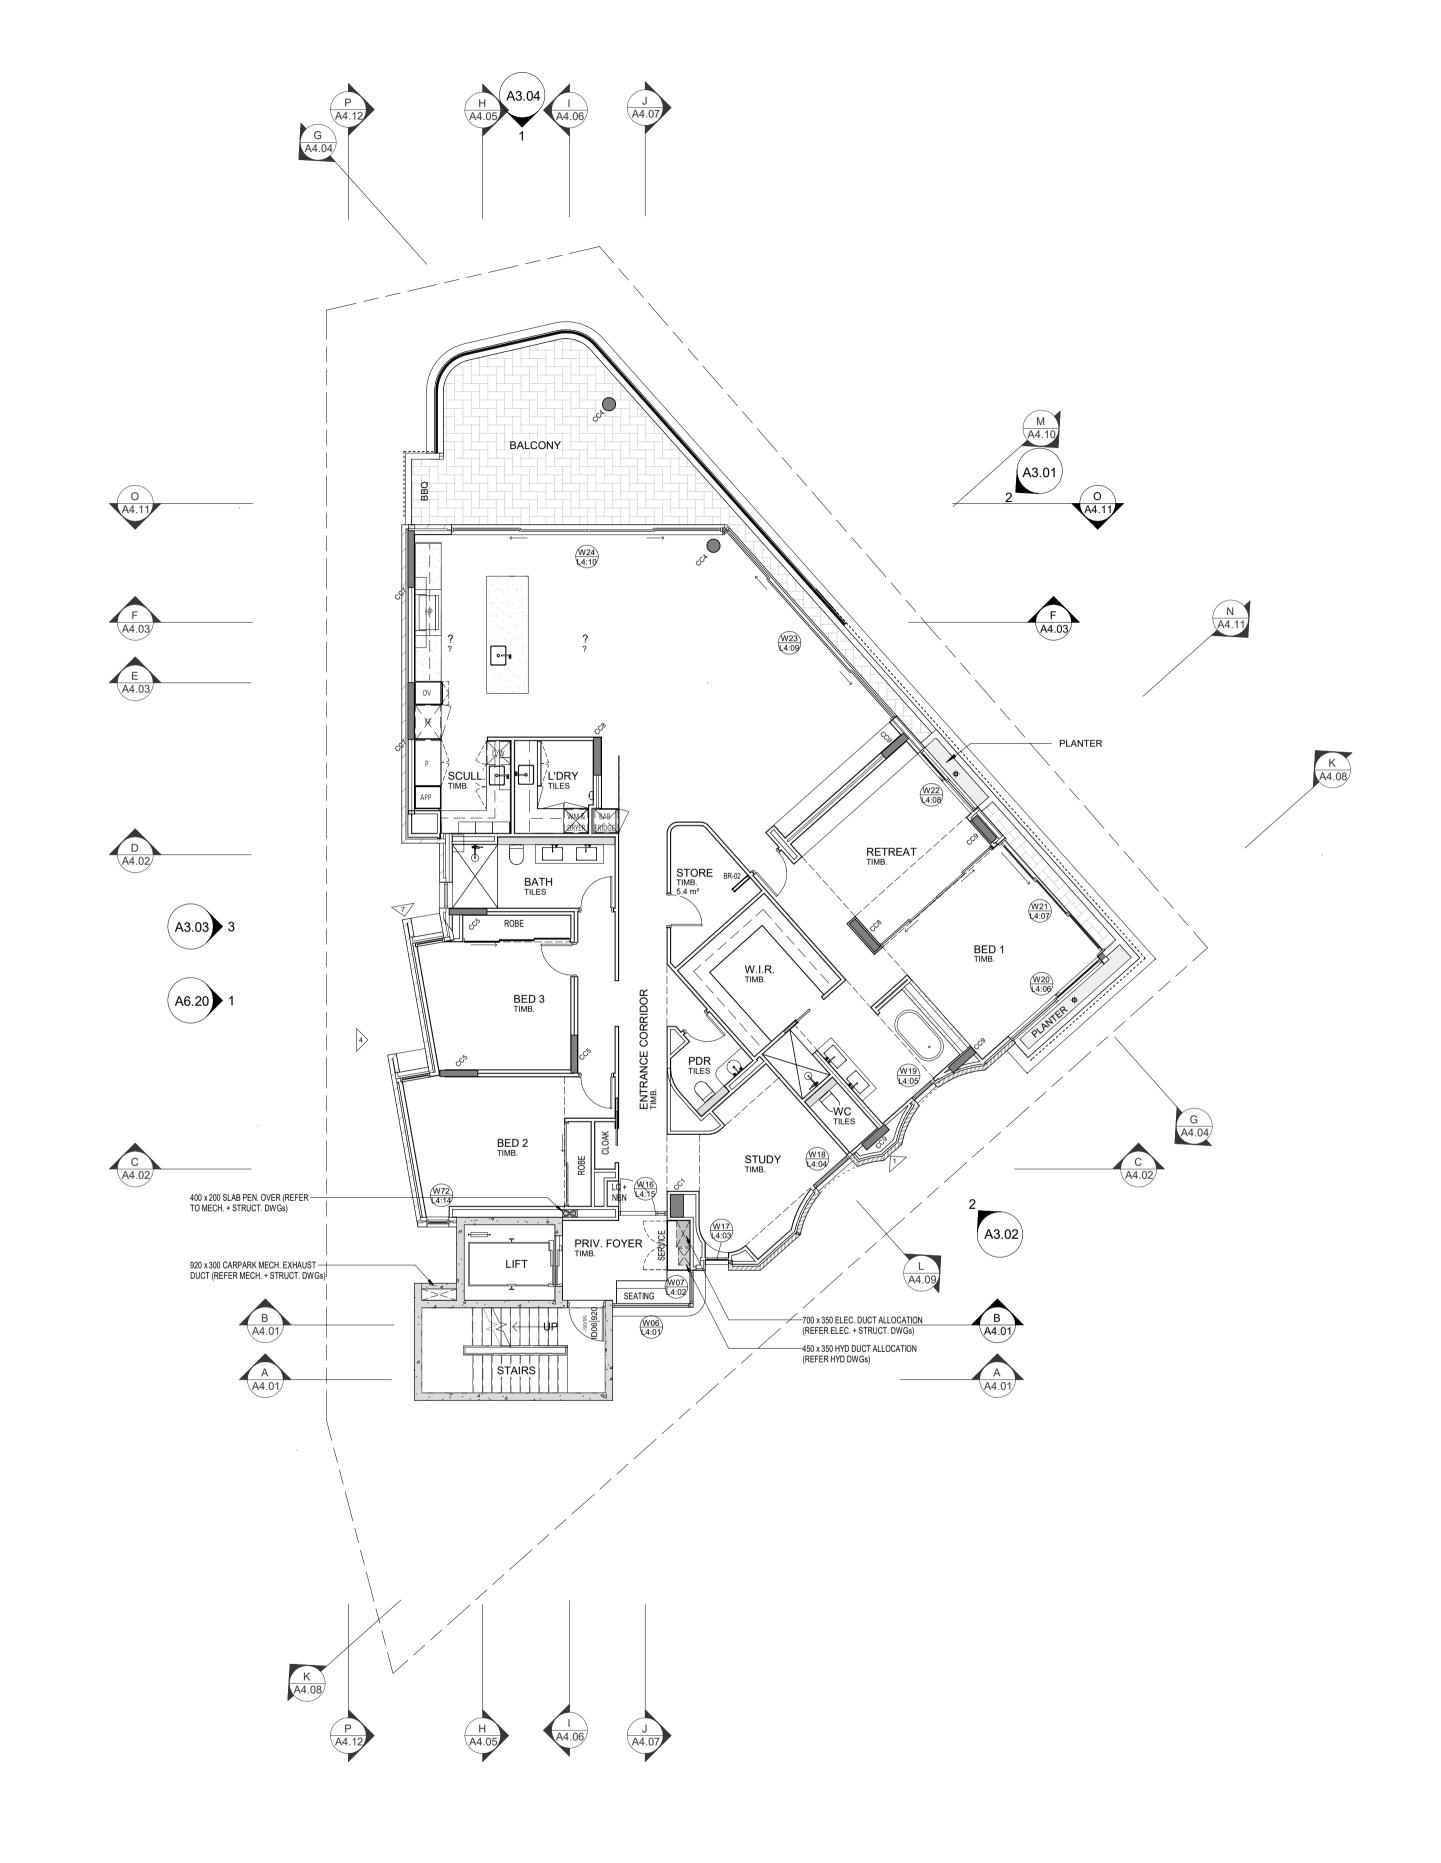

06 FOURTH FLOOR GENERAL ARRANCEMENT PLAN

SCALE 1:100

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	1'		, J	CONTRACTOR TO CHECK ALL
				DIMENSIONS AND LEVELS ON SITE
			1	BEFORE COMMENCING ANY WORK OR
				PREPARING ANY SHOP DRAWINGS.
			1	CAD FIGURE DIMENSIONS TAKE
				PRECEDENCE OVER MEASUREMENTS MANUALLY SCALED OFF DRAWINGS.
				LARGE SCALE DWGS TAKE
DATE			1	PRECEDENCE OVER SMALLER SCALE
N D	REV	RECIPIENT / REASON FOR ISSUE	BY	DWGS.

CANNING BEACH ROAD
LOT 1 65a+b CANNING BEACH ROAD
APPLECROSS 6153
KE
REMENTS
WINGS.
WINGS.

IFC PROGRESS DOCUMENTATION

DRAWN

Author DESIGNED

CHECKED

Checker JUSTIN CARRIER

CLIENT PROJECT
No. GRF19

CAPA PROJECT
No. GRF19


CAPA PROJECT
No. ACAD DRAWING

REDUCTION

30mm@A1
15mm@A3

DRAWING No. REV.

A2.06

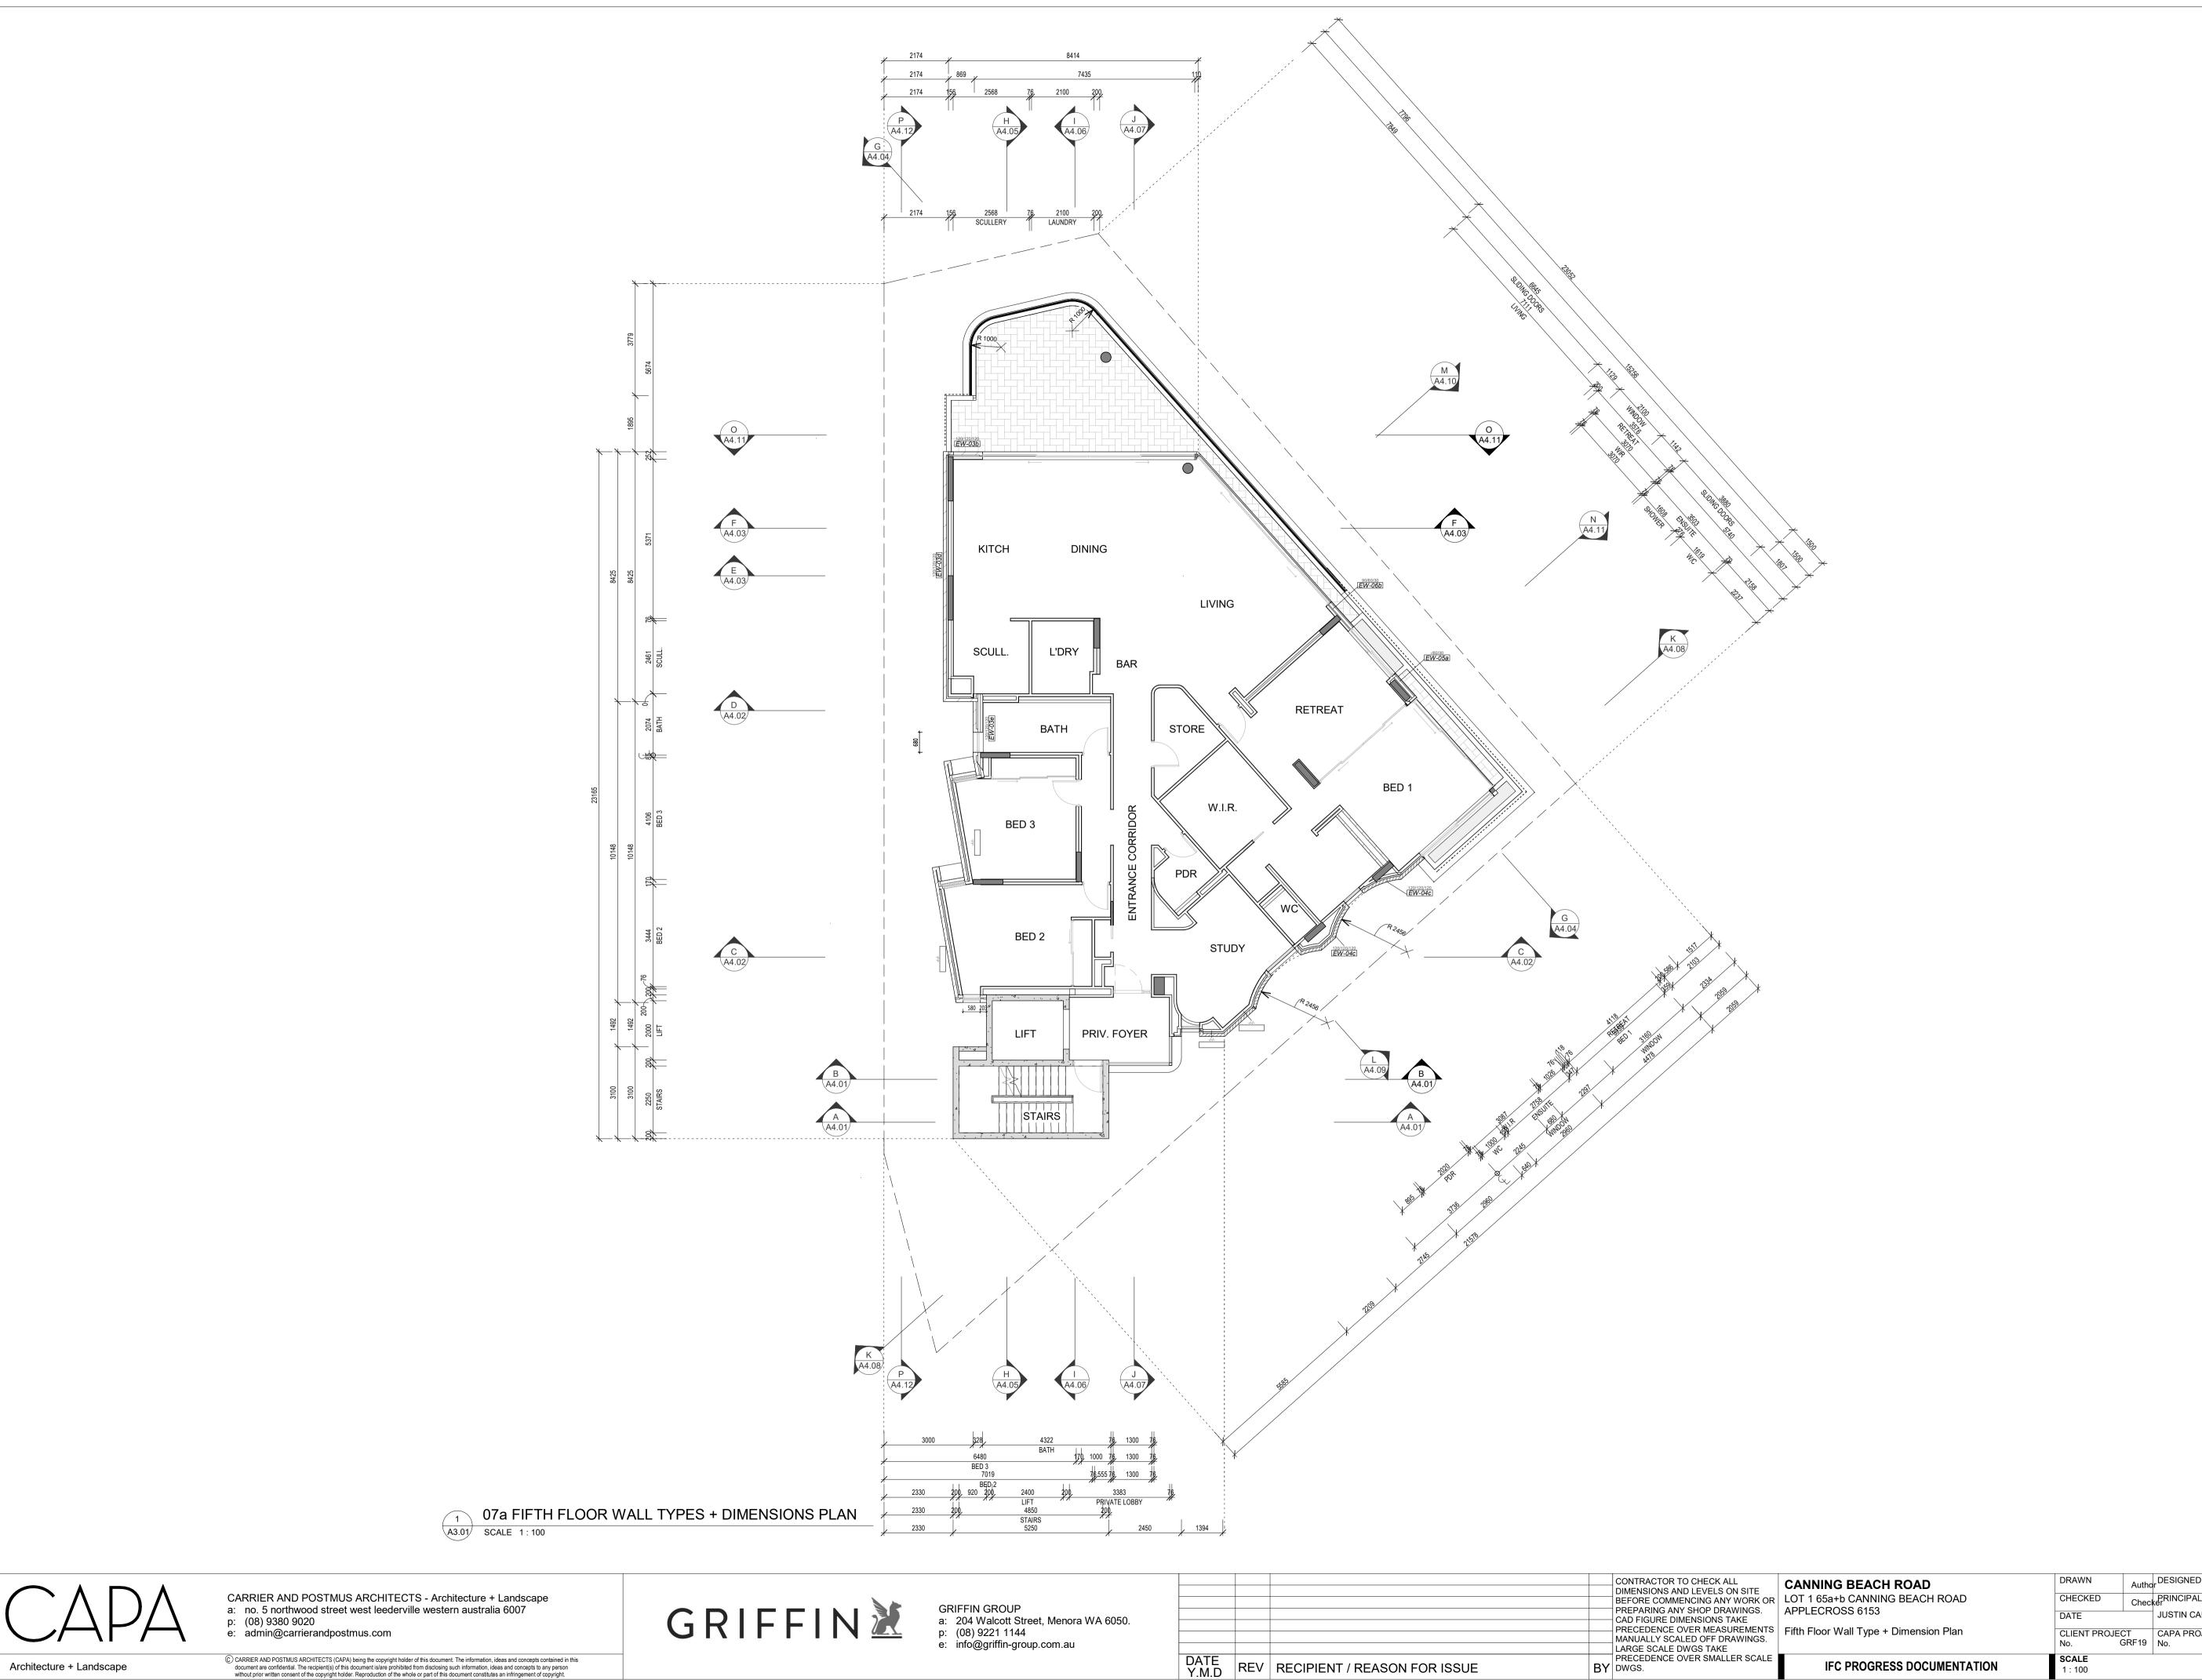


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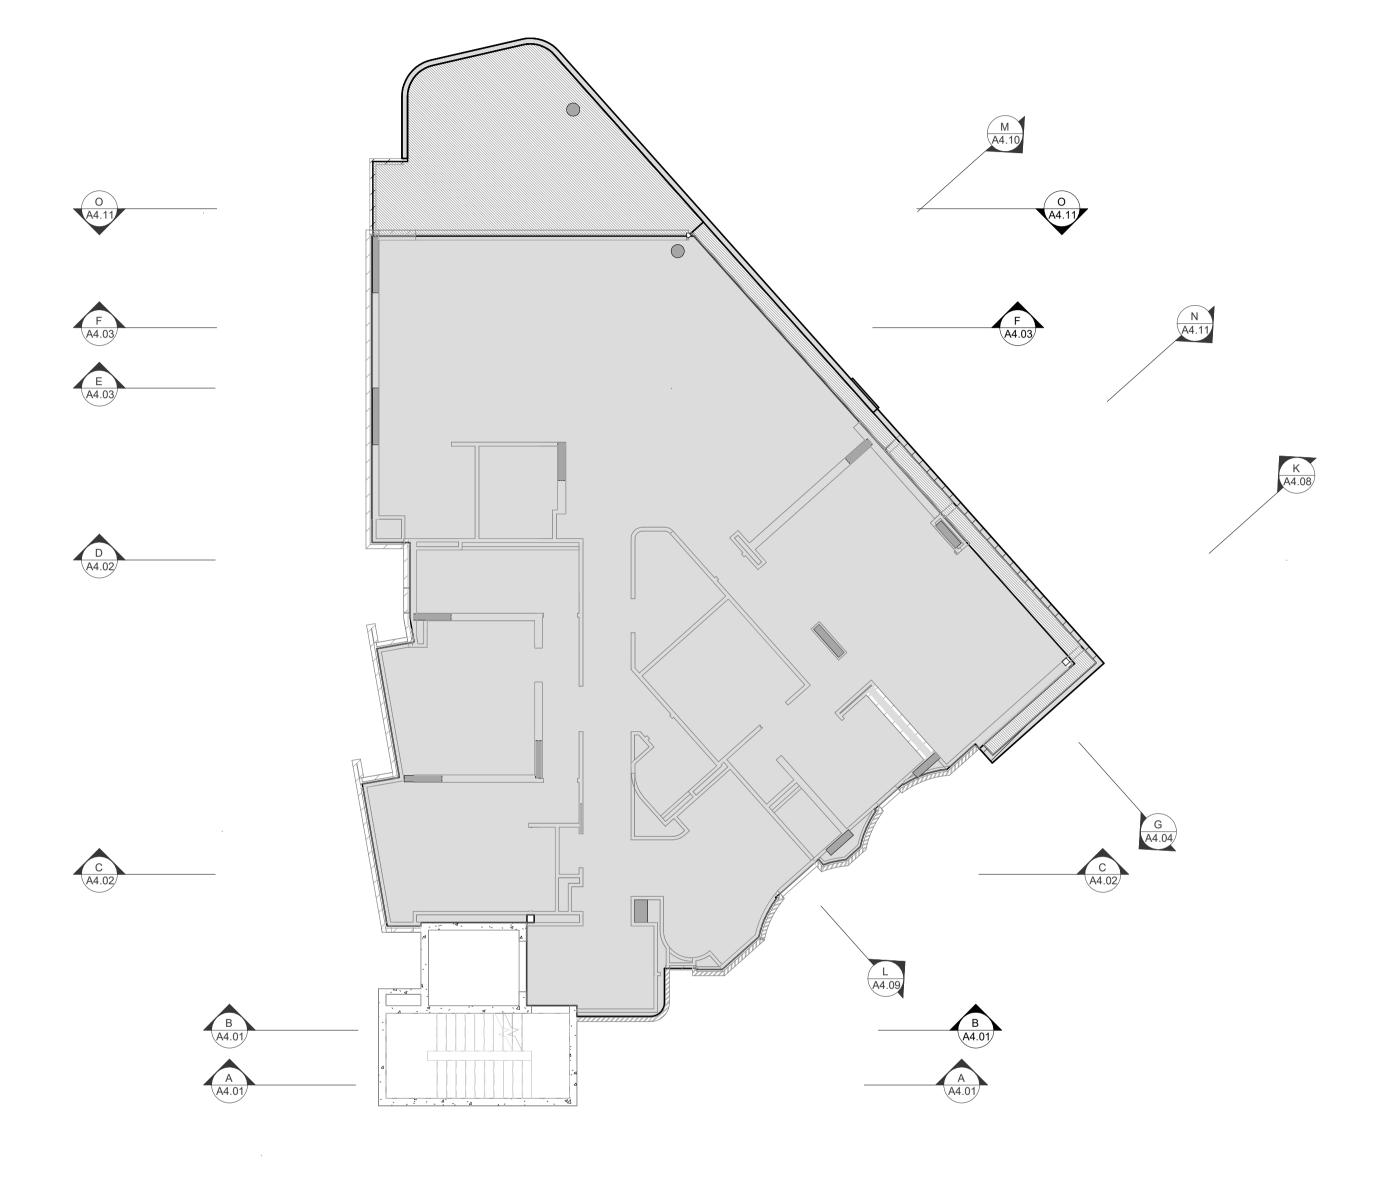
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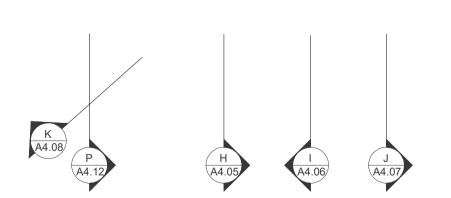
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IFC PROGRESS DOCUMENTATION

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07b FIFTH FLOOR SLAB SETOUT PLAN

A3.01 SCALE 1:100

Architecture + Landscape


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CANNING BEACH ROAD BEFORE COMMENCING ANY WORK OR LOT 1 65a+b CANNING BEACH ROAD

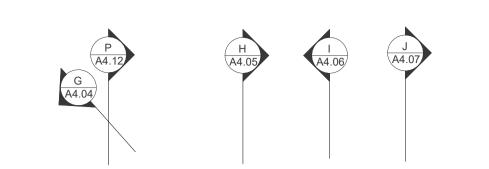IFC PROGRESS DOCUMENTATION

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4. SERVICES SHAFTS PENETRATING THROUGH S.O.U.

<u>LEGEND</u>

TYPICAL CONC. SLAB LEVEL

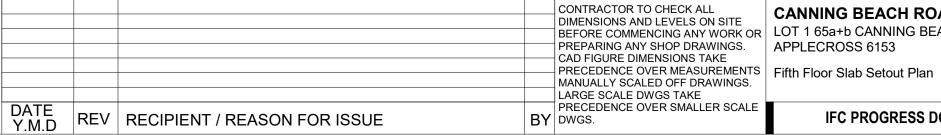-40mm WET AREA SETDOWN

AND COLUMN SIZES.

MUST ACHIEVE FRL -/90/90.

AND SLAB SETDOWN FACE.

SERVICES TO BEND BELOW GROUND.

-100mm LOWER EXTERNAL SLAB XXX SLAB THICKNESS

. STRUCTURAL ENGINEER DRAWINGS TAKE PRECEDENCE FOR SLAB THICKNESS

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6. TYPICALLY, WET AREA SETDOWN ARE ALIGNED TO STUD FRAME FACE.


7. TYPICALLY, EXTERNAL SLAB STEPS ARE TO EXTERNAL FYRCHEK FACE.

8. ALLOW 500mm BETWEEN PAVING AND TOP OF FOOTING FOR HYDRUALIC

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GENERAL PLANTING. REFER LANDSCAPE DRAWINGS FOR SOFT LANDSCAPING

PLASTERBOARD / FYRCHEK TO BE FLUSH AGAINST STUD

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07 FIFTH FLOOR GENERAL ARRANCEMENT PLAN

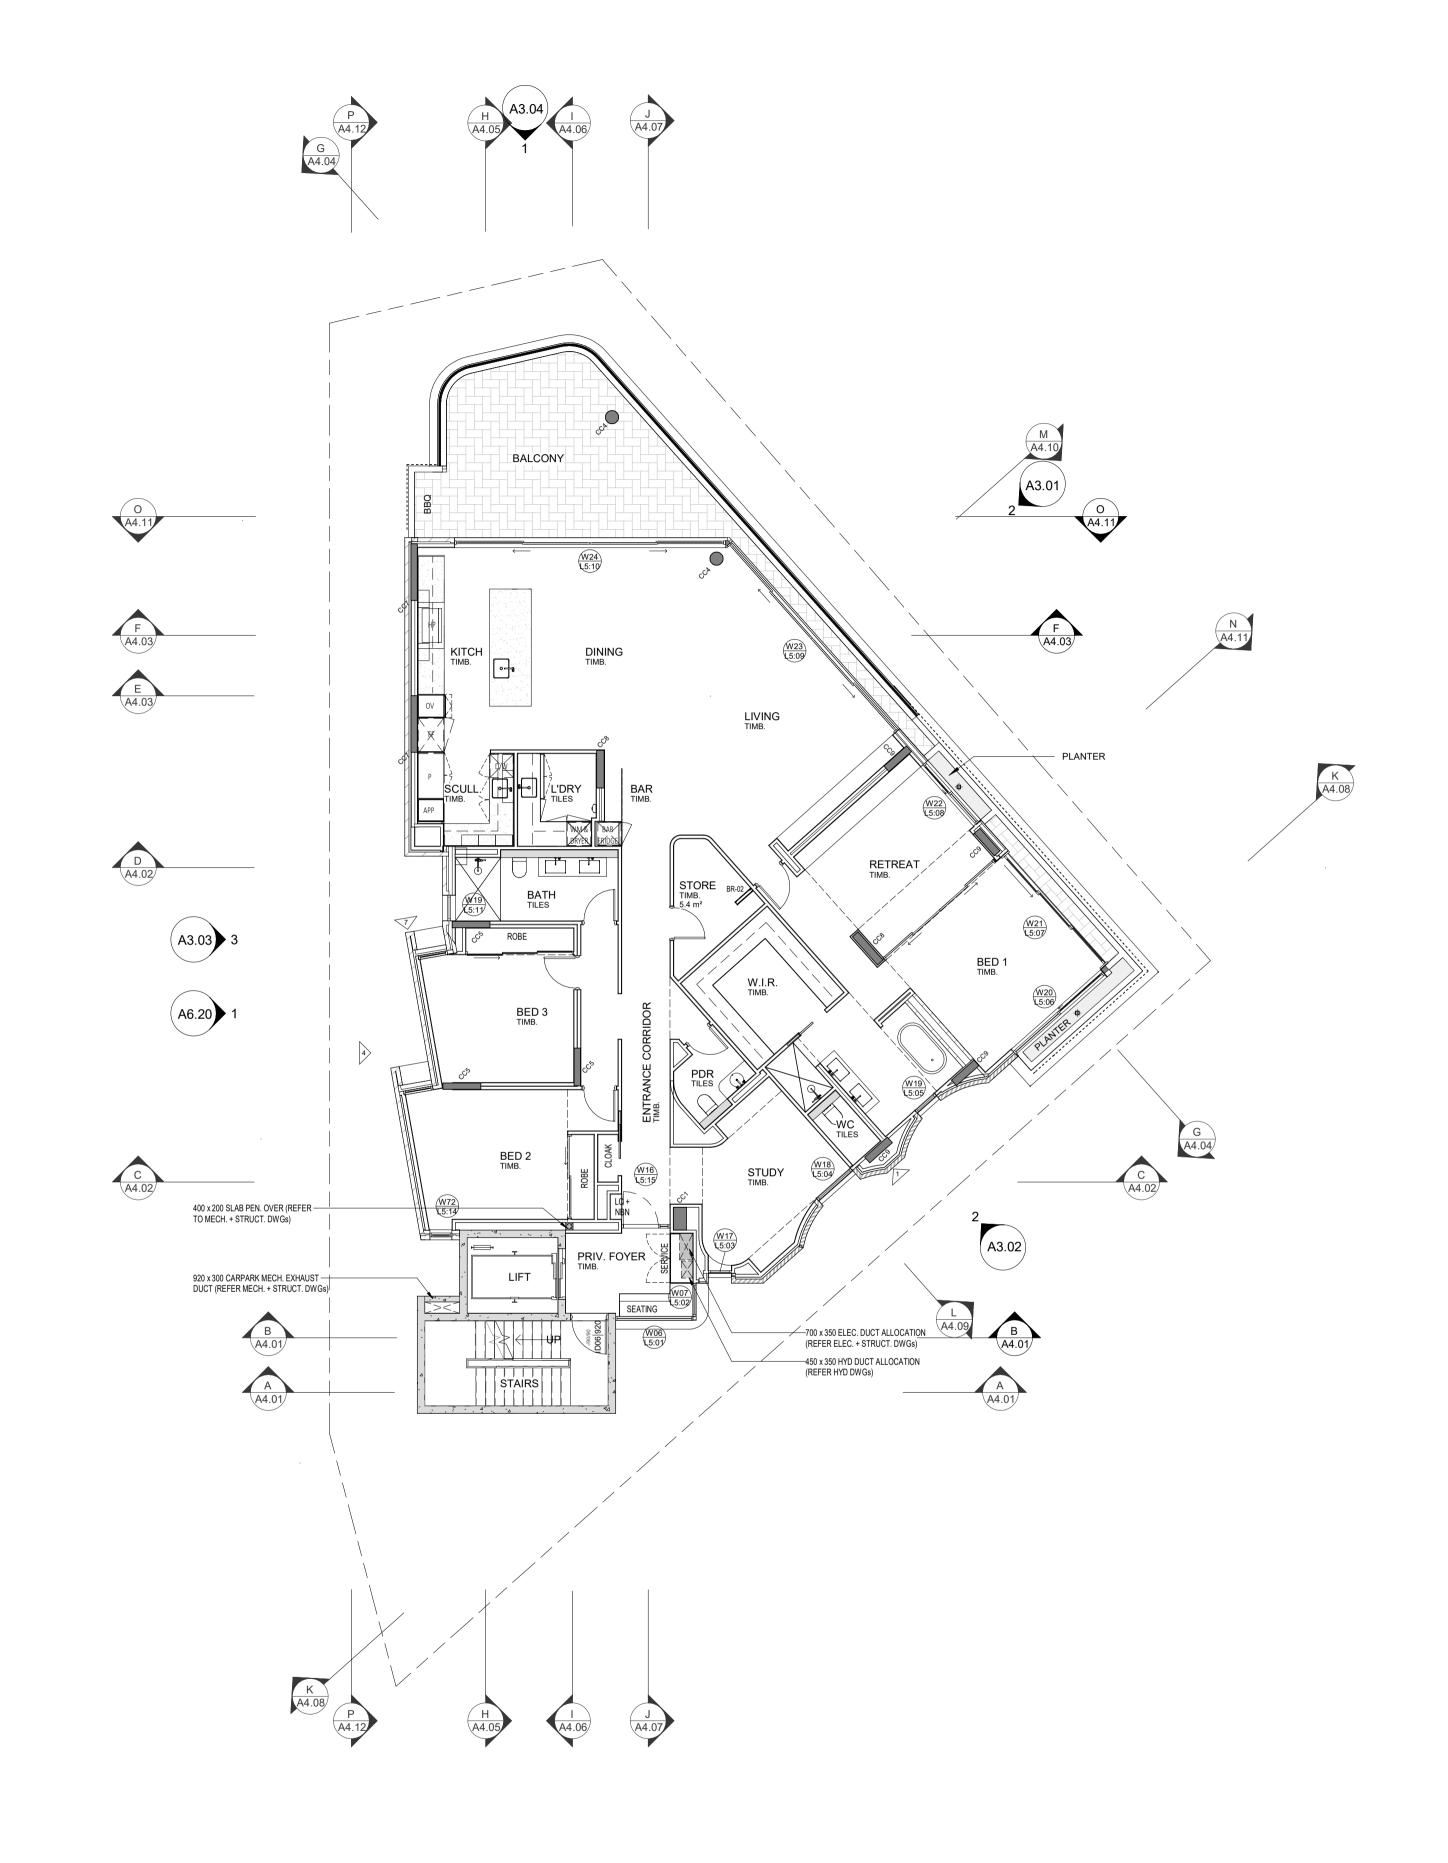SCALE 1:100

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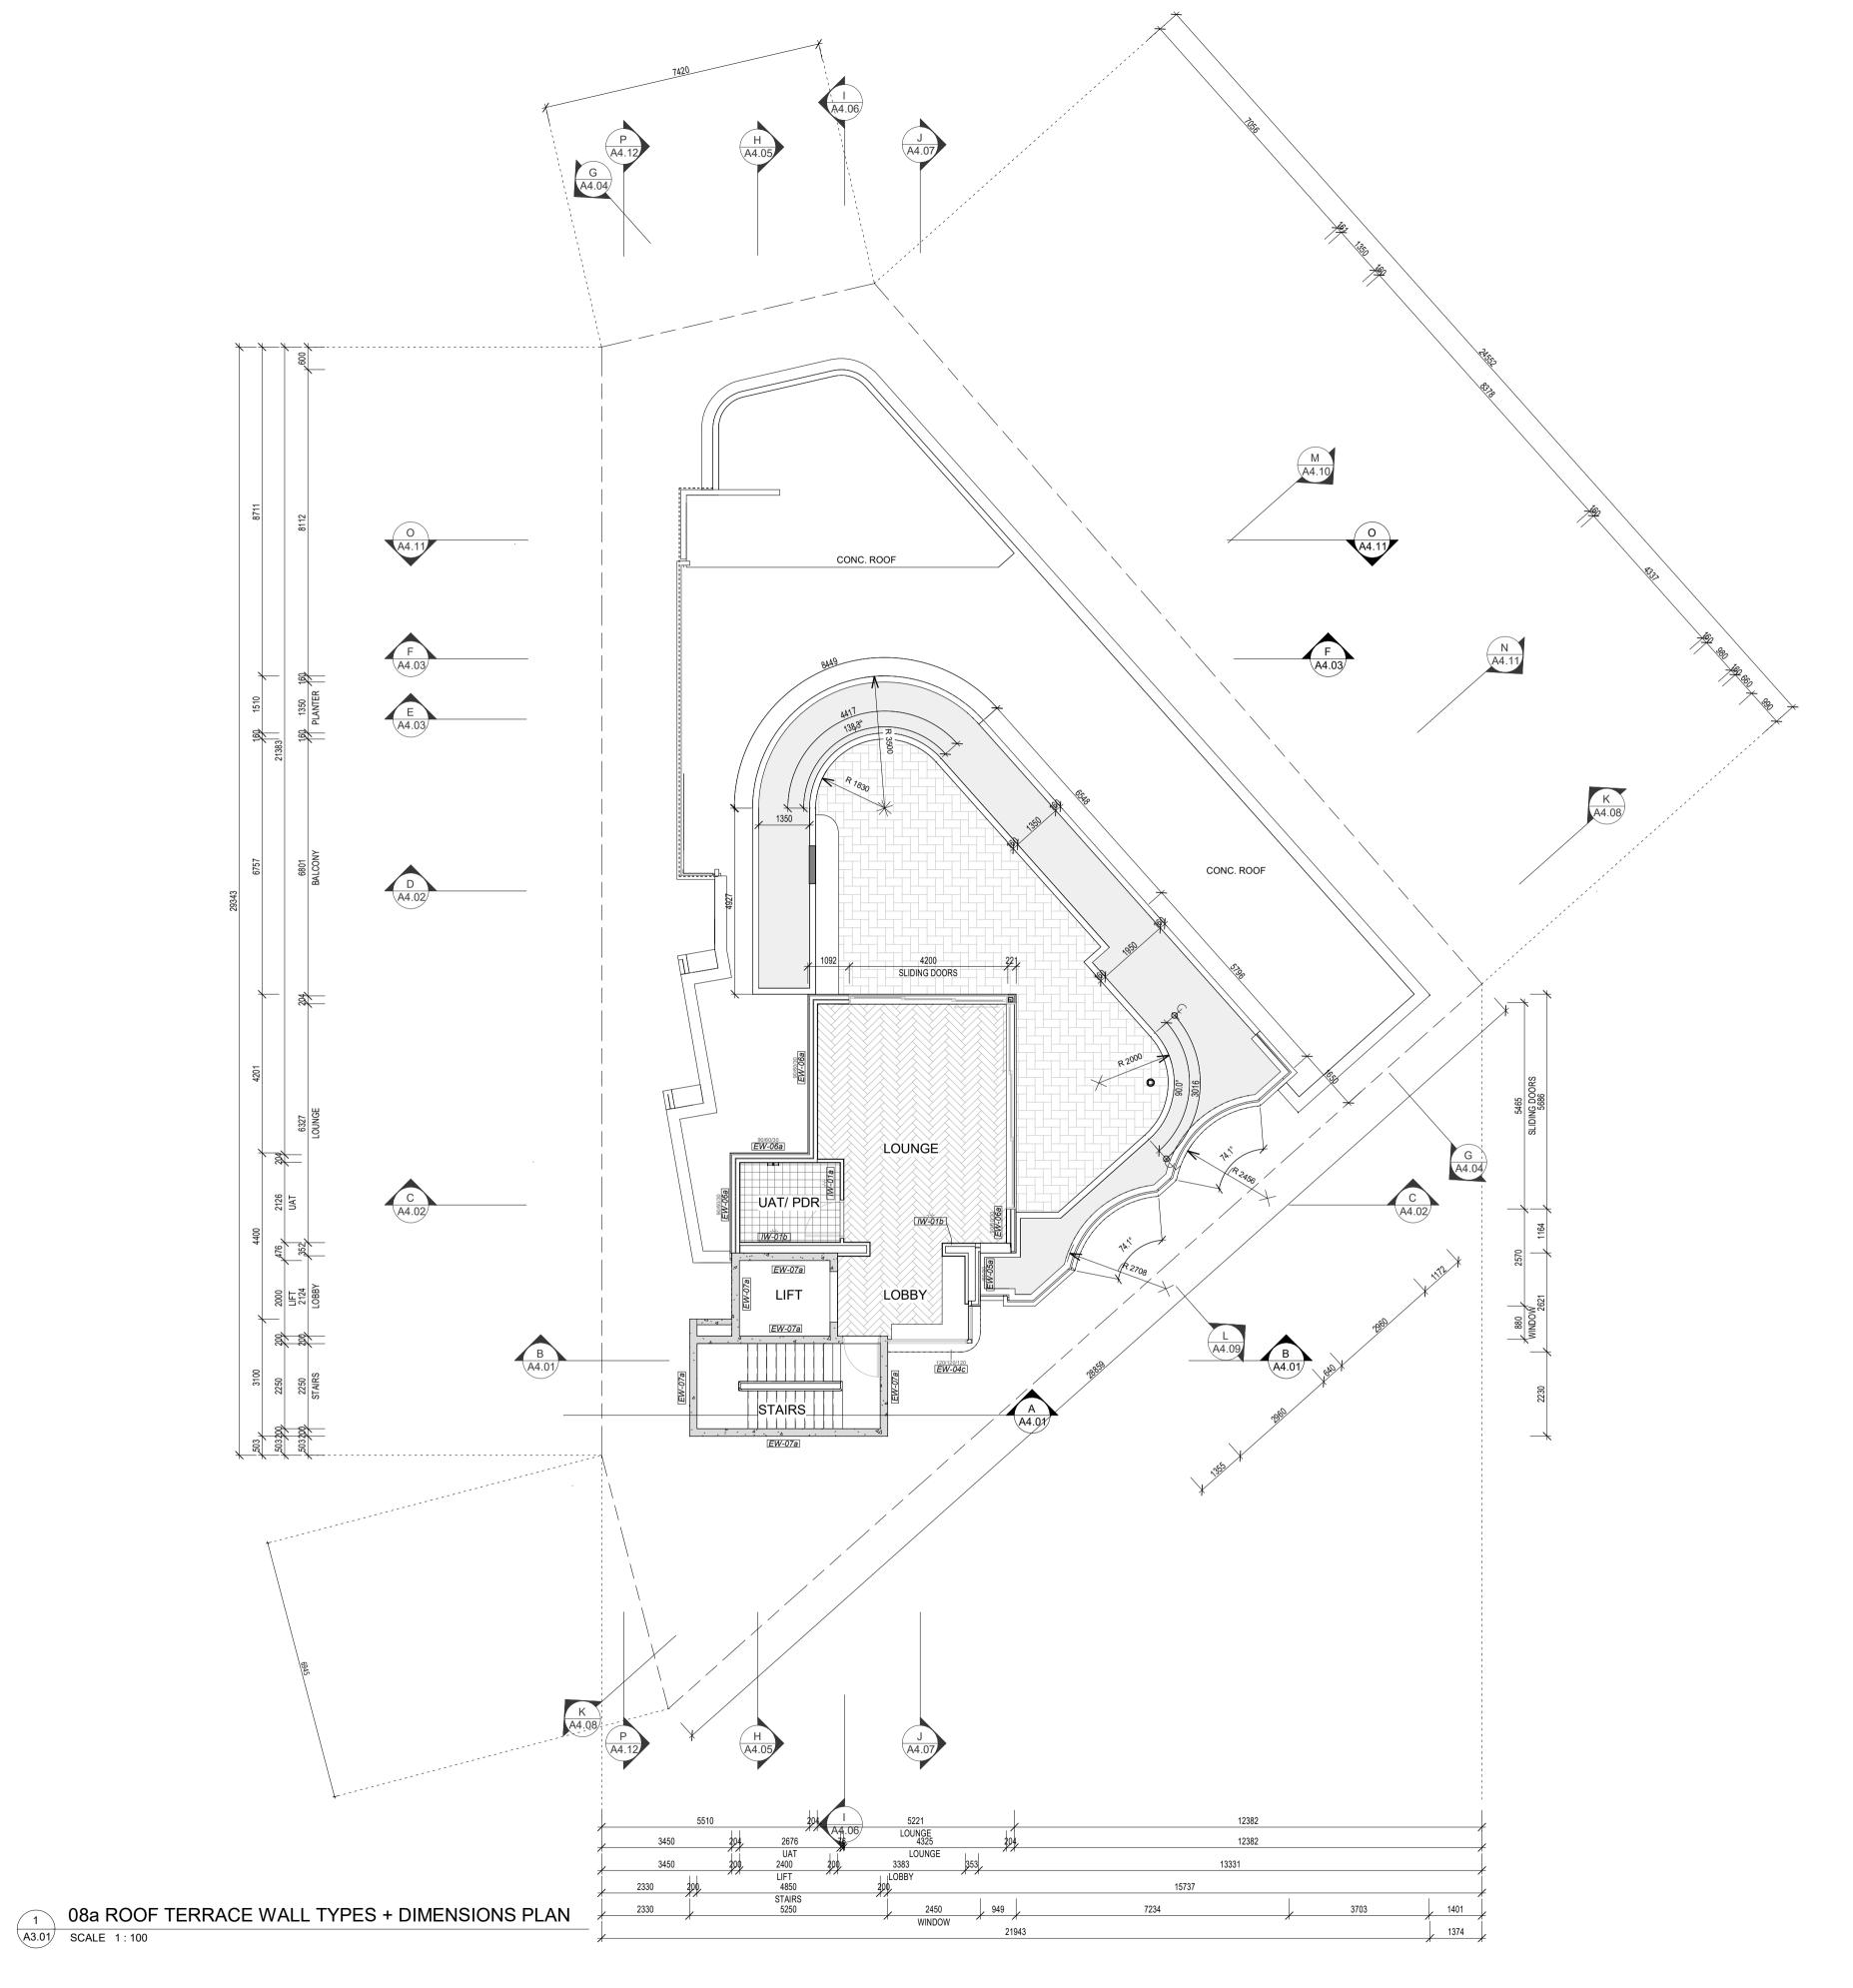


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				LARGE SCALE DWGS TAKE
DATE Y M D	REV	RECIPIENT / REASON FOR ISSUE	BY	PRECEDENCE OVER SMALLER SCALE DWGS.

	CANNING BEACH ROAD
R	CANNING BEACH ROAD LOT 1 65a+b CANNING BEACH ROAD APPLECROSS 6153
S	Fifth Floor General Arrangement Plan

IFC PROGRESS DOCUMENTATION



WALL TYPES SCHEDULE REFER DRAWING A2.10 FOR WALL BUILD-UP AND SYSTEM

INSULATION

- TO BE READ IN CONJUNCTION WITH ENVIRONMENTAL AND ACOUSTIC REPORTS

- REFER WALL TYPES PLANS FOR WALL INSULATION EXTENTS

- REFER REFLECTED CEILING PLANS FOR CEILING AND ROOF INSULATION EXTENTS

MINIMUM REQUIREMENTS

— — Min. R2.5 90mm 24kg/m3 ACOUSTIGARD (or approved similar)

75mm 14kg/m3 ACOUSTIGARD (or approved similar)

50mm 11kg/m3 ACOUSTIGARD (or approved similar)

— 100mm 24kg/m3 ACOUSTIGARD (or approved similar)

FOR EXTERIOR WALL TYPES, WALL LAYERS ARE READ FROM TOP OF PAGE TO BOTTOM OF PAGE / EXTERIOR TO INTERIOR LAYER U.N.O

WET AREAS AND EXTERIOR PLASTERBOARD / FYRCHEK TO BE

MOISTURE RESISTANT. PROVIDE DEFLECTION HEAD TO ALL STUD

FRAME WALS FRL RATINGS ARE TO MEET OR EXCEED ESD, FIRE AND ACOUSTIC
REQUIREMENTS, WHICHEVER IS HIGHER.
EXTERNAL LIGHTWEIGHT WALLS TO HAVE

R0.2 THERMAL BREAK BETWEEN CLADDING PANEL AND SUPPORTING FRAMING

CROSS-CHECK WITH CONSULTANT
REPORTS FOR ACOUSTIC AND THERMAL INSULATION REQUIREMENTS. REFER CONSULTANT REPORTS FOR

LAGGING TO SERVICES DUCTS, PIPES AND THE LIKE. SERVICES TO BE DISCONTINUOUS FROM WALLS FOR ACOUSTIC ISOLATION.

WALLS FOR ACOUSTIC ISOLATION.
IMPACT RESISTANT LINING TO BE USED
ON LOBBY AND COMMUNAL AREA FACING
WALLS. ENSURE LINING MEET FRL
RATING AND ARE INSTALLED TO MANUFACTURER'S REQUIREMENTS TO MEET FRL.

DIMENSION NOTES:
DIMENSIONS ARE TO FACES OF STRUCTURE AND SUB-SUBTRUCTURE (e.g. STUDS) U.N.O DIMENSIONS DO NOT INCLUDE DEPTH FOR TOP HATS, BATTENS, NOGGINGS AND THE LIKE U.N.O

- REFER ELEVATIONS, SECTIONS AND INTERIOR ELEVATION

SERIES DRAWINGS FOR WALL FINISHES. - TO BE READ IN CONJUNCTION WITH ARCHITECTURAL MATERIALS SCHEDULE AND INTERIOR FINISHES SCHEDULE FOR FINISHES SPECIFICATIONS AND COLOUR SELECTION. - REFER INTERIOR FINISHES SCHEDULE FOR COLOUR SCHEME ASSIGNED TO INDIVIDUAL RESIDENCES.
- NOTE: FINISHES AND COLOURS TO BE CROSS CHECKED WITH ARCHITECT PRIOR TO APPLICATION ON SITE AS PURCHASER VARIATIONS MAY AFFECT FINISHES SCHEDULES.



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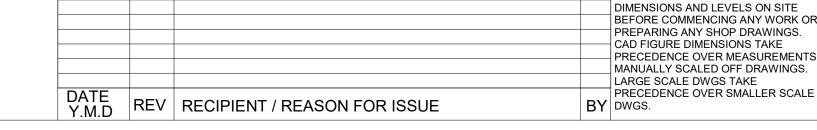
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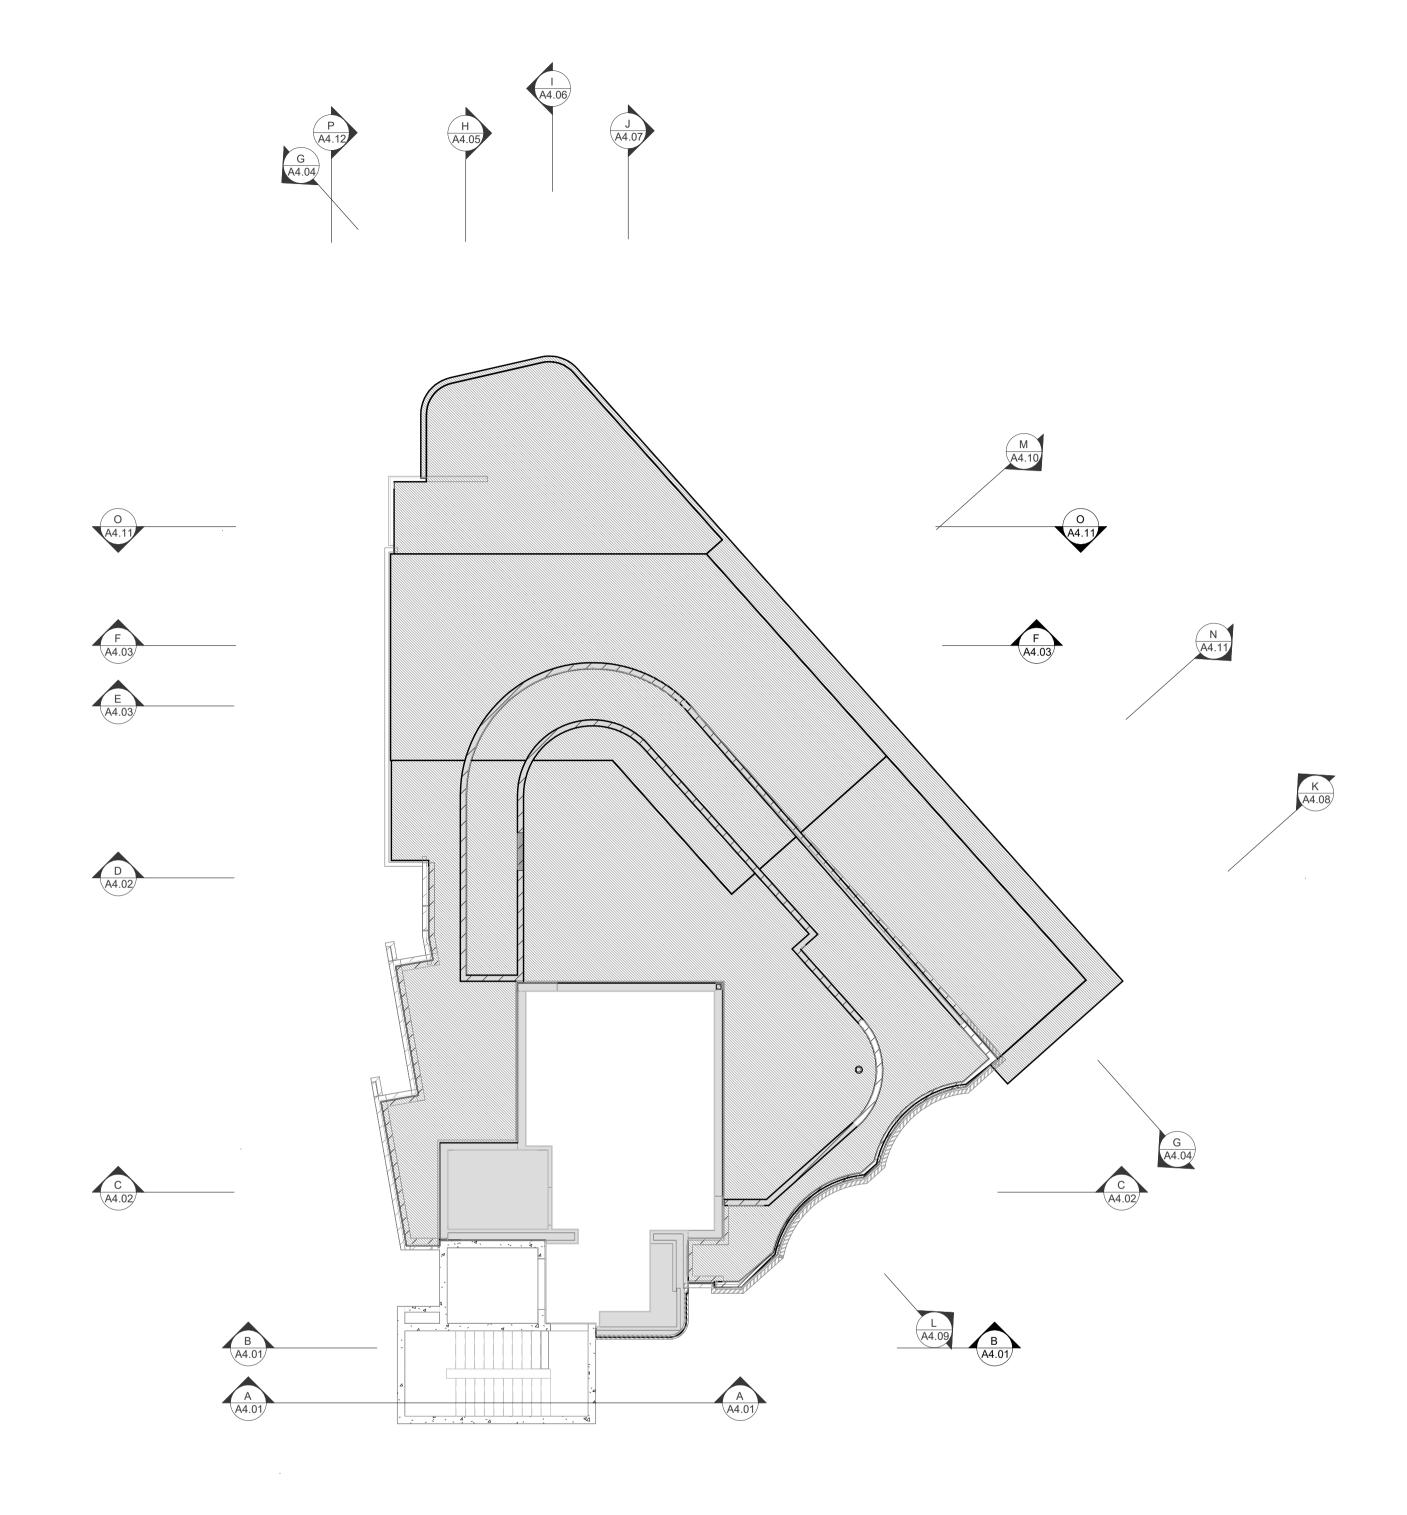
CANNING BEACH ROAD BEFORE COMMENCING ANY WORK OR LOT 1 65a+b CANNING BEACH ROAD APPLECROSS 6153 PRECEDENCE OVER MEASUREMENTS
MANUALLY SCALED OFF DRAWINGS.
LARGE SCALE DWGS TAKE


PRECEDENCE OVER MEASUREMENTS
MANUALLY SCALED OFF DRAWINGS.
LARGE SCALE DWGS TAKE

IFC PROGRESS DOCUMENTATION

CONTRACTOR TO CHECK ALL

PO DESIGNED JC THIS IS A CAD DRAWING DO NOT AMEND MANUALLY CHECKED PRINCIPAL REDUCTION JUSTIN CARRIER CLIENT PROJECT CAPA PROJECT No. GRF19 No. 2 DRAWING No. 2027 A2.08a **SCALE** 1:100



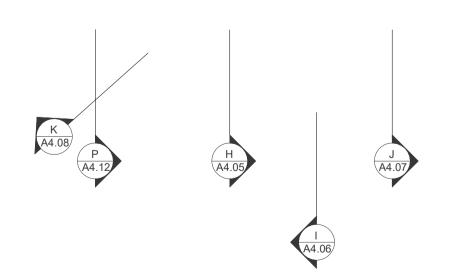

08b ROOF TERRACE SLAB SETOUT PLAN 1 08b ROOF A3.01 SCALE 1:100



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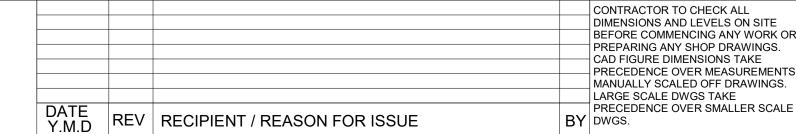
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CANNING BEACH ROAD BEFORE COMMENCING ANY WORK OR LOT 1 65a+b CANNING BEACH ROAD PREPARING ANY SHOP DRAWINGS. APPLECROSS 6153 PRECEDENCE OVER MEASUREMENTS | Roof Deck Slab Setout Plan

IFC PROGRESS DOCUMENTATION

CHECKED

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GENERAL NOTES

DIMENSIONS.

ALL DIMENSIONS ARE IN MILLIMETRES U.N.O.

AUTHORITY REQUIREMENTS.

WORK COMMENCEMENT.

FLOOR WASTES AND TILING.

CONDITIONS & ACCESS REQUIREMENTS.

SAME AS ADJACENT MATERIAL U.N.O.

BUILDING TAG XX-XX

ABBREVIATION LEGEND

AIR-CONDITIONING DOWNPIPE ABOVE FINISHED

ABOVE FLOOR LEVEL (W/O FINISH)

BRICK CONTROL JOINT BALUSTRADE BARRIER KERB

BASE OF WALL (AKA BoW) COMPRESSED FIBRE

ACCESS PANEL

CONTROL JOINT

CONFIRM ON SITE

CONDENSER UNIT

(BOTTOM OF LINING)

DOWNPIPE (AKA RWP)

EXPOSED FIBRE CEMENT SHEET

FIRE EXTINGUISHER

FLOOR LEVEL W/O FINISHES (AKA SL) FINISHED FLOOR LEVEL

HARDWOOD HOT WATER SUPPLY

(FLOAT & SET) INSPECTION POINT

LOAD CENTRE

HARDWALL PLASTER

FIRE HYDRANT

FLUSH KERB

FRIDGE FLOOR WASTE

HOSECOCK

HOT PLATE

CEILING LEVEL

COLUMN

DUCT DISHWASHER

EQUAL **EXISTING**

CONCRETE

APPLIANCE

ACDP

AFFL

AGG AP APP BCJ BALU BK BW CFC

COL

CONC C.O.S.

CU DP DU ENS EQ. EXP FC FE FH FK FL

<u>LEGEND</u>

TYPICAL CONC. SLAB LEVEL

-40mm WET AREA SETDOWN

AND COLUMN SIZES.

MUST ACHIEVE FRL -/90/90.

AND SLAB SETDOWN FACE.

PLANTING EXTENTS

SERVICES TO BEND BELOW GROUND.

-100mm LOWER EXTERNAL SLAB XXX SLAB THICKNESS

1. STRUCTURAL ENGINEER DRAWINGS TAKE PRECEDENCE FOR SLAB THICKNESS

2. IF DISCREPANCIES BETWEEN ARCHITECTURAL AND STRUCTURAL DRAWINGS OCCUR, NOTIFY THE SUPERINTENDENT FOR ADVICE PRIOR TO SETOUT ON SITE.

3. FIRE COLLAR TO SERVICES PENETRATION THROUGH SLAB. TYPICAL.

7. TYPICALLY, EXTERNAL SLAB STEPS ARE TO EXTERNAL FYRCHEK FACE. 8. ALLOW 500mm BETWEEN PAVING AND TOP OF FOOTING FOR HYDRUALIC

MIN. 1200mm PLANTING DEPTH AT TREES AND MIN. 500mm PLANTING DEPTH FOR GENERAL PLANTING. REFER LANDSCAPE DRAWINGS FOR SOFT LANDSCAPING

9. FOOTINGS ADJACENT TO GARDEN BEDS TO BE LOWERED TO ALLOW

4. SERVICES SHAFTS PENETRATING THROUGH S.O.U.

5. CROSS CHECK SLAB SETOUT WITH WALL SETOUT DRAWINGS. 6. TYPICALLY, WET AREA SETDOWN ARE ALIGNED TO STUD FRAME FACE.

PLASTERBOARD / FYRCHEK TO BE FLUSH AGAINST STUD

16.2 FIXTURES & FITTINGS 16.5 16.3 WATERPROOFING SYSTEMS 16.6

WRITTEN DIMENSIONS SHALL TAKE PRECEDENCE OVER SCALED

CONTRACTOR SHALL CARRY OUT WORK IN CONFORMANCE WITH THE B.C.A./N.C.C. RELEVANT STANDARDS AND THE LOCAL

THE MAIN CONTRACTOR IS TO ENSURE THIS DRAWING IS READ IN CONJUNCTION WITH ALL RELEVANT ARCHITECTURAL, STRUCTURAL AND SERVICE CONSULTANT DOCUMENTATION TO ENSURE FULL CO-ORDINATION BETWEEN TRADES PRIOR TO

LARGE SCALE DRAWINGS SHALL TAKE PRECEDENCE OVER SMALLER SCALE DRAWINGS. CONTRACTOR SHALL CARRY OUT WORK IN CONFORMANCE WITH THE B.C.A./N.C.C. RELEVANT STANDARDS AND THE LOCAL AUTHORITY REQUIREMENTS. SEEK CLARIFICATION FROM SUPERINTENDENT FOR ANY DISCREPANCIES. ALL EXTERNAL FLOOR SURFACES TO FALL AWAY FROM

REFER INTERIOR DOCUMENTATION FOR SETOUTS AND EXACT LOCATIONS OF CABINETRY, FITTINGS, FIXTURES, PLUMBING,

REFER TO WALL TYPES PLANS FOR WALL SETOUTS.
REFER SLAB SETOUT PLANS FOR SLAB AND STRUCTURAL

REFER MASTER MATERIALS SCHEDULE FOR THE FOLLOWING AND MORE: 16.1 STRUCTURE SURFACE FINISHES 16.4 FINISHES 16.2 FIXTURES & FITTINGS 16.5 APPLIANCES

ENSURE ALL STRUCTURAL STEEL COLUMNS WITHIN 3m OF SITE BOUNDARY TO BE FIRE PROTECTED TO CODES AND STANDARDS. INSTALL FLASHINGS, EDGE TRIMS AND APPROPRIATE SEASL AS REQUIRED TO ACHIEVE WEATHER TIGHTNESS. FINISH TO BE

LIN'N LDRY M/H MW

O/A OAE

RH RKZ

RPZ

SAG SHWR SK

SMK

W/O WS WM

LAUNDRY

MANHOLE MICROWAVE OVERALL OR APPROVED

EQUIVALENT

PLASTERBOARD

POINT DRAIN (REF. HYD FOR TYPES) PLANTING LEVEL (TOP

RETURN AIR GRILLE

REDUCED PRESSURE

RAINWATER HEAD

SUPPLY AIR GRILLE

LEVEL (AKA SSL)

SEMI-MOUNTABLE

STAINLESS STEEL

TRANSITION KERB

SOIL STACK

STANDARDS SOAKWELL (REF. HYD.) TO BE CONFIRMED

TROUGH TOP OF WALL

TYPICAL

WITHOUT

(AKA TOW)

UNLESS NOTED OTHERWISE

VANITY BASIN VENT PIPE WITH

WHEEL STOP WASHING MACHINE

OVERHEAD OVERFLOW

OF MULCH)

RAKING

SHOWER SINK STRUCTURAL SLAB


RANGEHOOD

RELATIVE LEVEL

OVEN PANTRY

ALL MATERIALS SHALL BE NEW & COMFORM TO WHAT IS SHOWN ON THE DRAWINGS AND IN THE SCHEDULES. THE CONTRACTOR SHALL CHECK & VERIFY ALL DIMENSIONS ON SITE, PRIOR TO THE COMMENCEMENT OF ANY BUILDING WORK. ALL WINDOW DIMENSIONS ARE NOMINAL AND ARE TO BE MEASURED ON SITE.
THE CONTRACTOR SHALL VISIT THE SITE & NOTE ALL SITE

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08 ROOF TERRACE GENERAL ARRANCEMENT PLAN
SCALE 1:100
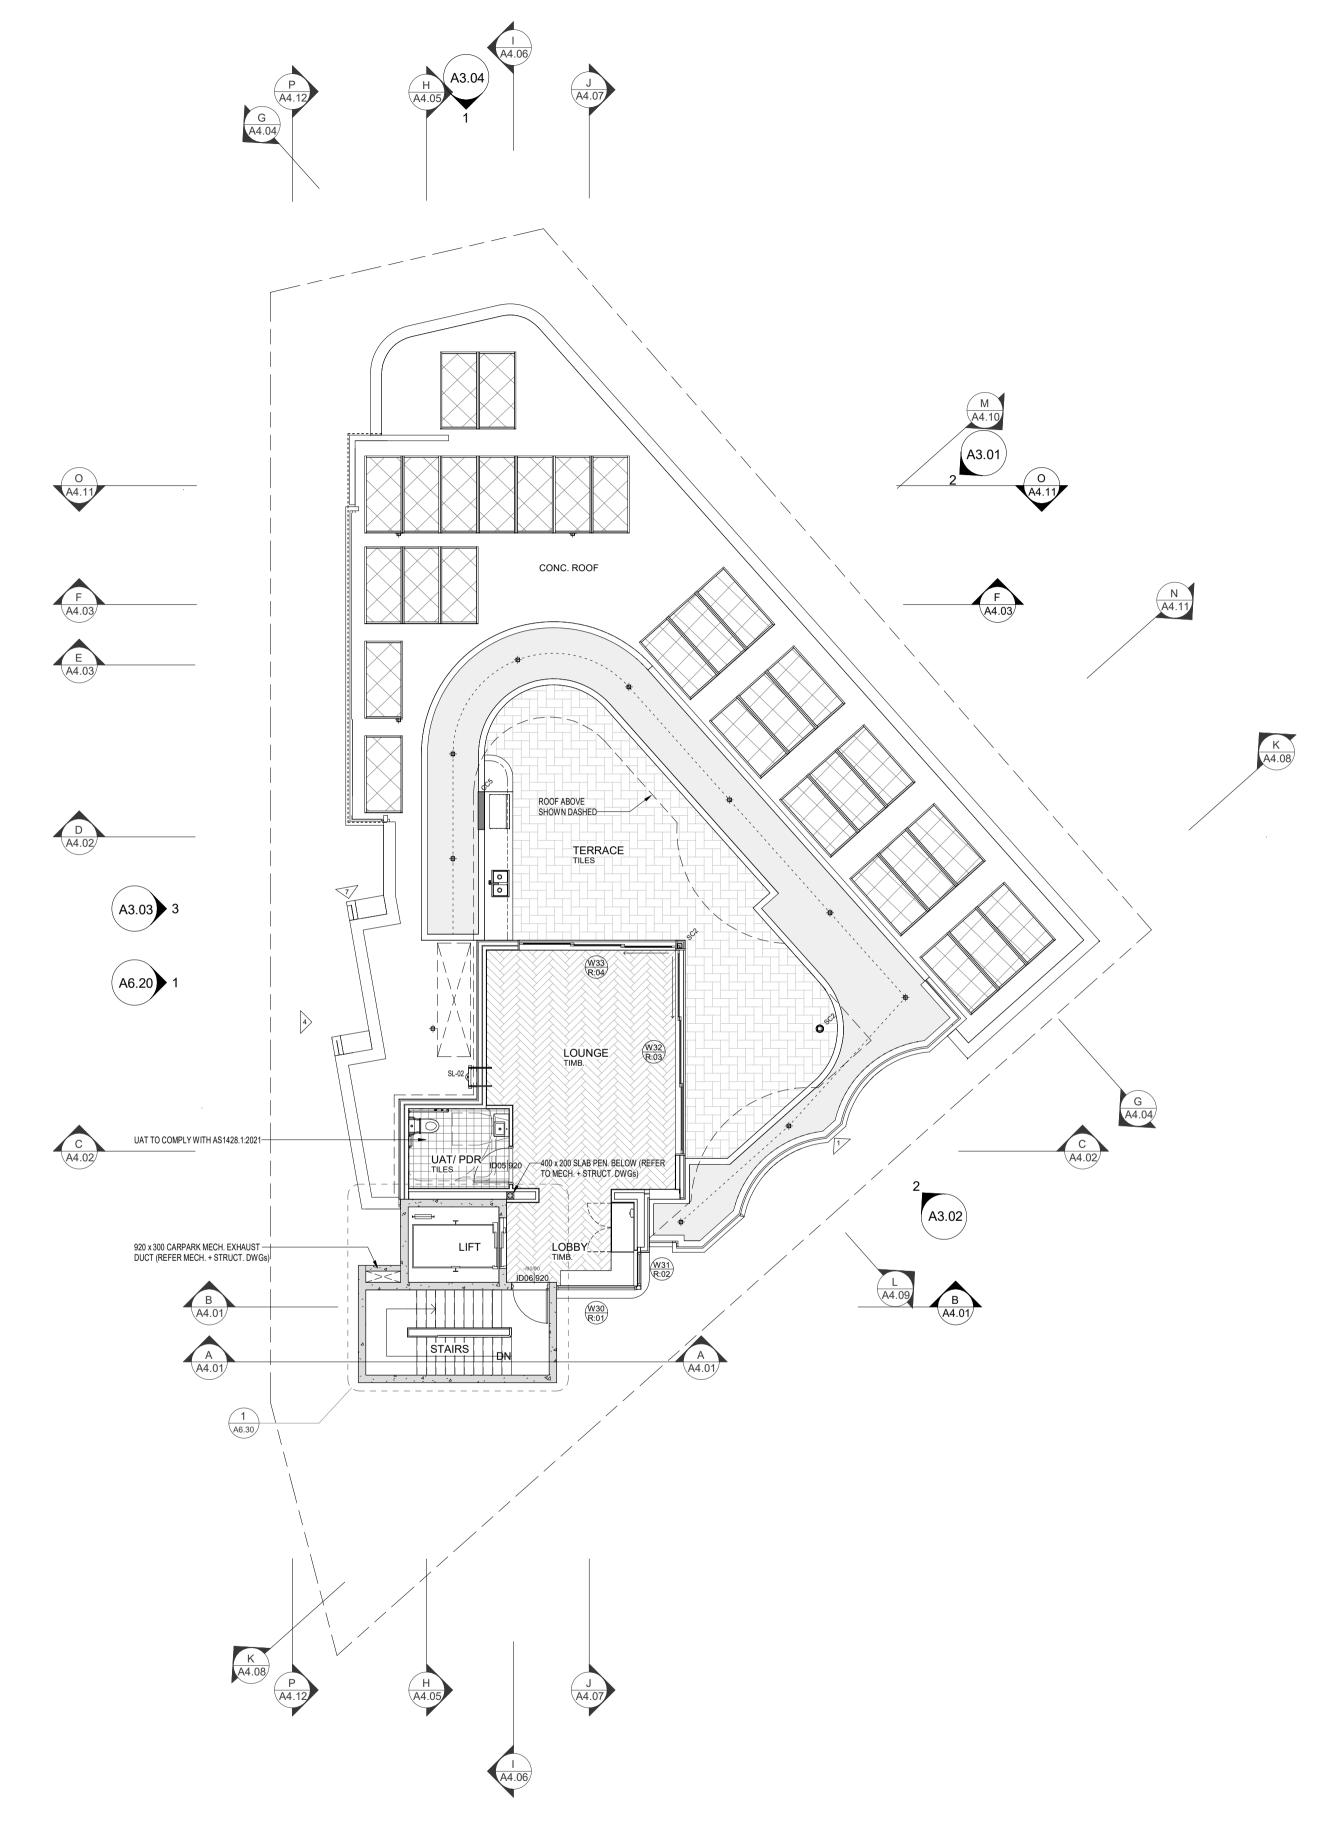
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				CAD FIGURE DIMENSIONS TAKE
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	0			LARGE SCALE DWGS TAKE
DATE Y.M.D	REV	RECIPIENT / REASON FOR ISSUE	BY	PRECEDENCE OVER SMALLER SCALE DWGS.

ALL	CANNING BEACH BOAD
ON SITE	CANNING BEACH ROAD
Y WORK OR	LOT 1 65a+b CANNING BEACH ROAD
AWINGS.	APPLECROSS 6153
TAKE	
UREMENTS	Roof Deck General Arrangement Plan

IFC PROGRESS DOCUMENTATION

DRAWN	СМ	DESIGNED	JC	THIS IS A CAD DRAW DO NOT AMEND MAN	
CHECKED	JC	PRINCIPAL		REDUCTION	
DATE		JUSTIN CARRIER		30mm@A1 15mm@A3	
CLIENT PROJECT	CT GRF19	CAPA PROJECT No.	2027	DRAWING No.	R
SCALE 1:100				A2.08	(

GENERAL NOTES

ALL DIMENSIONS ARE IN MILLIMETRES U.N.O.
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WORK COMMENCEMENT.

LARGE SCALE DRAWINGS SHALL TAKE PRECEDENCE OVER

SMALLER SCALE DRAWINGS. CONTRACTOR SHALL CARRY OUT

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SEEK CLARIFICATION FROM SUPERINTENDENT FOR ANY

DISCREPANCIES

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ALL EXTERNAL FLOOR SURFACES TO FALL AWAY FROM BUILDING.

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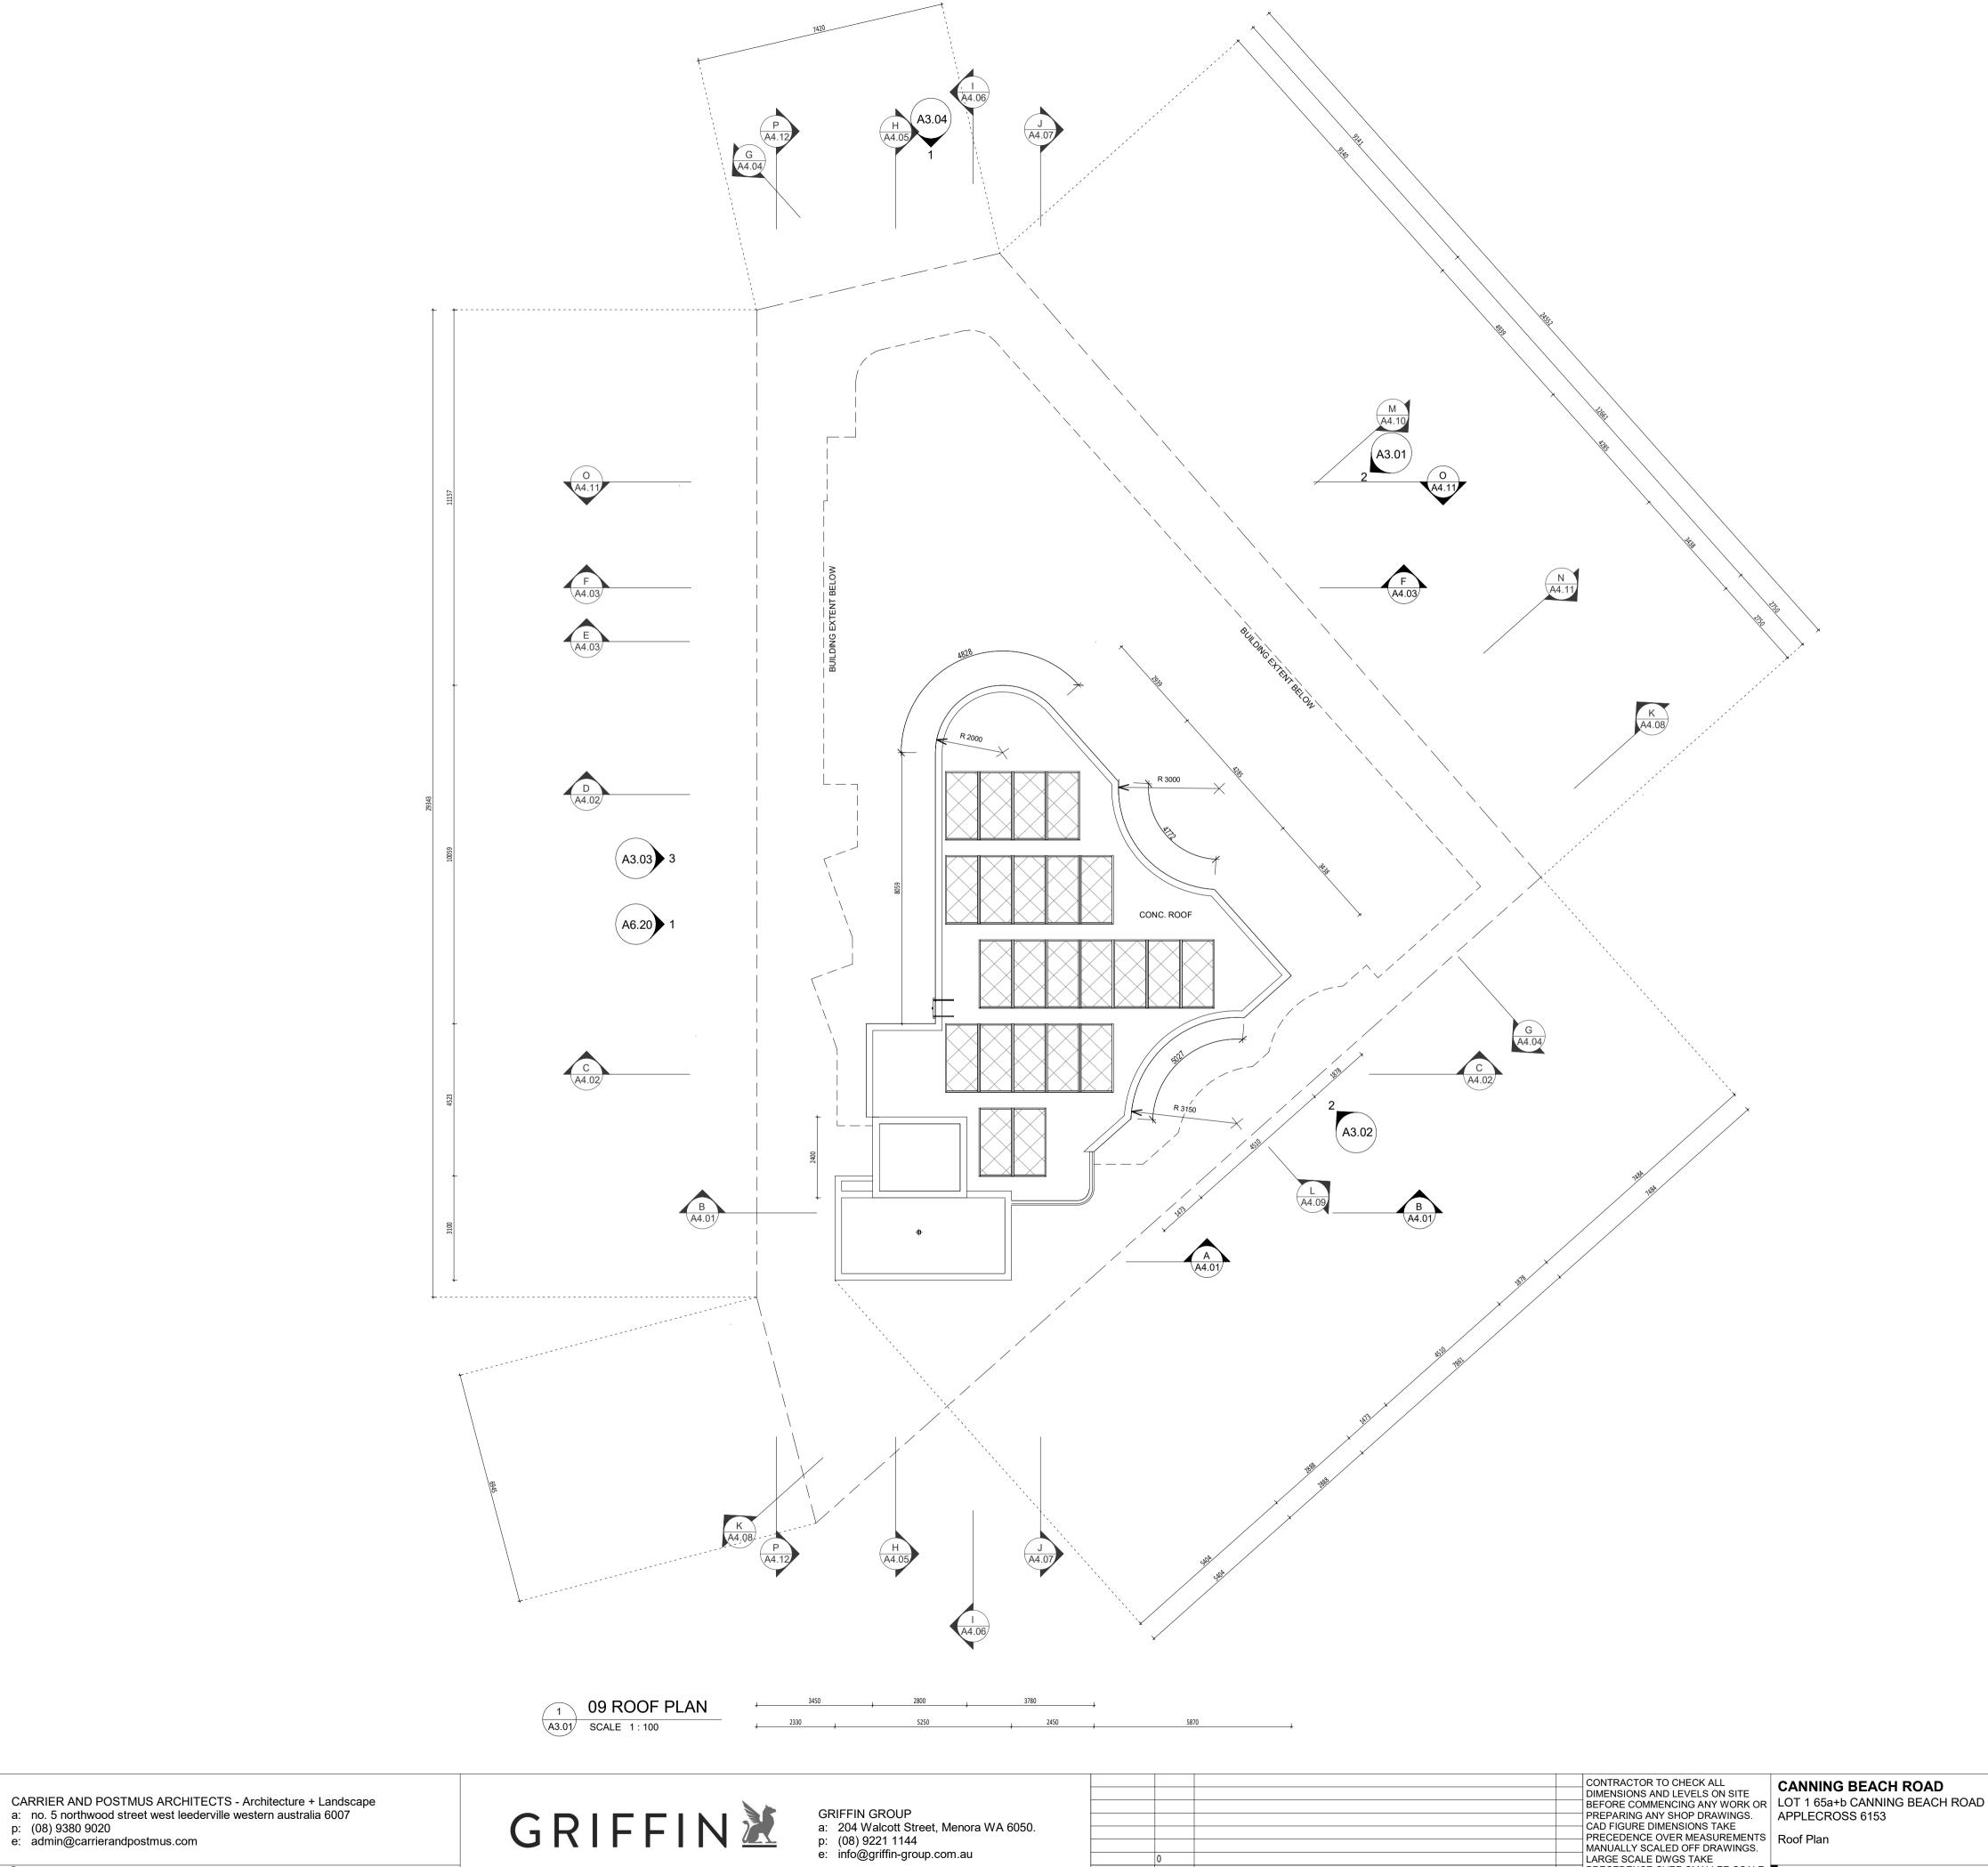
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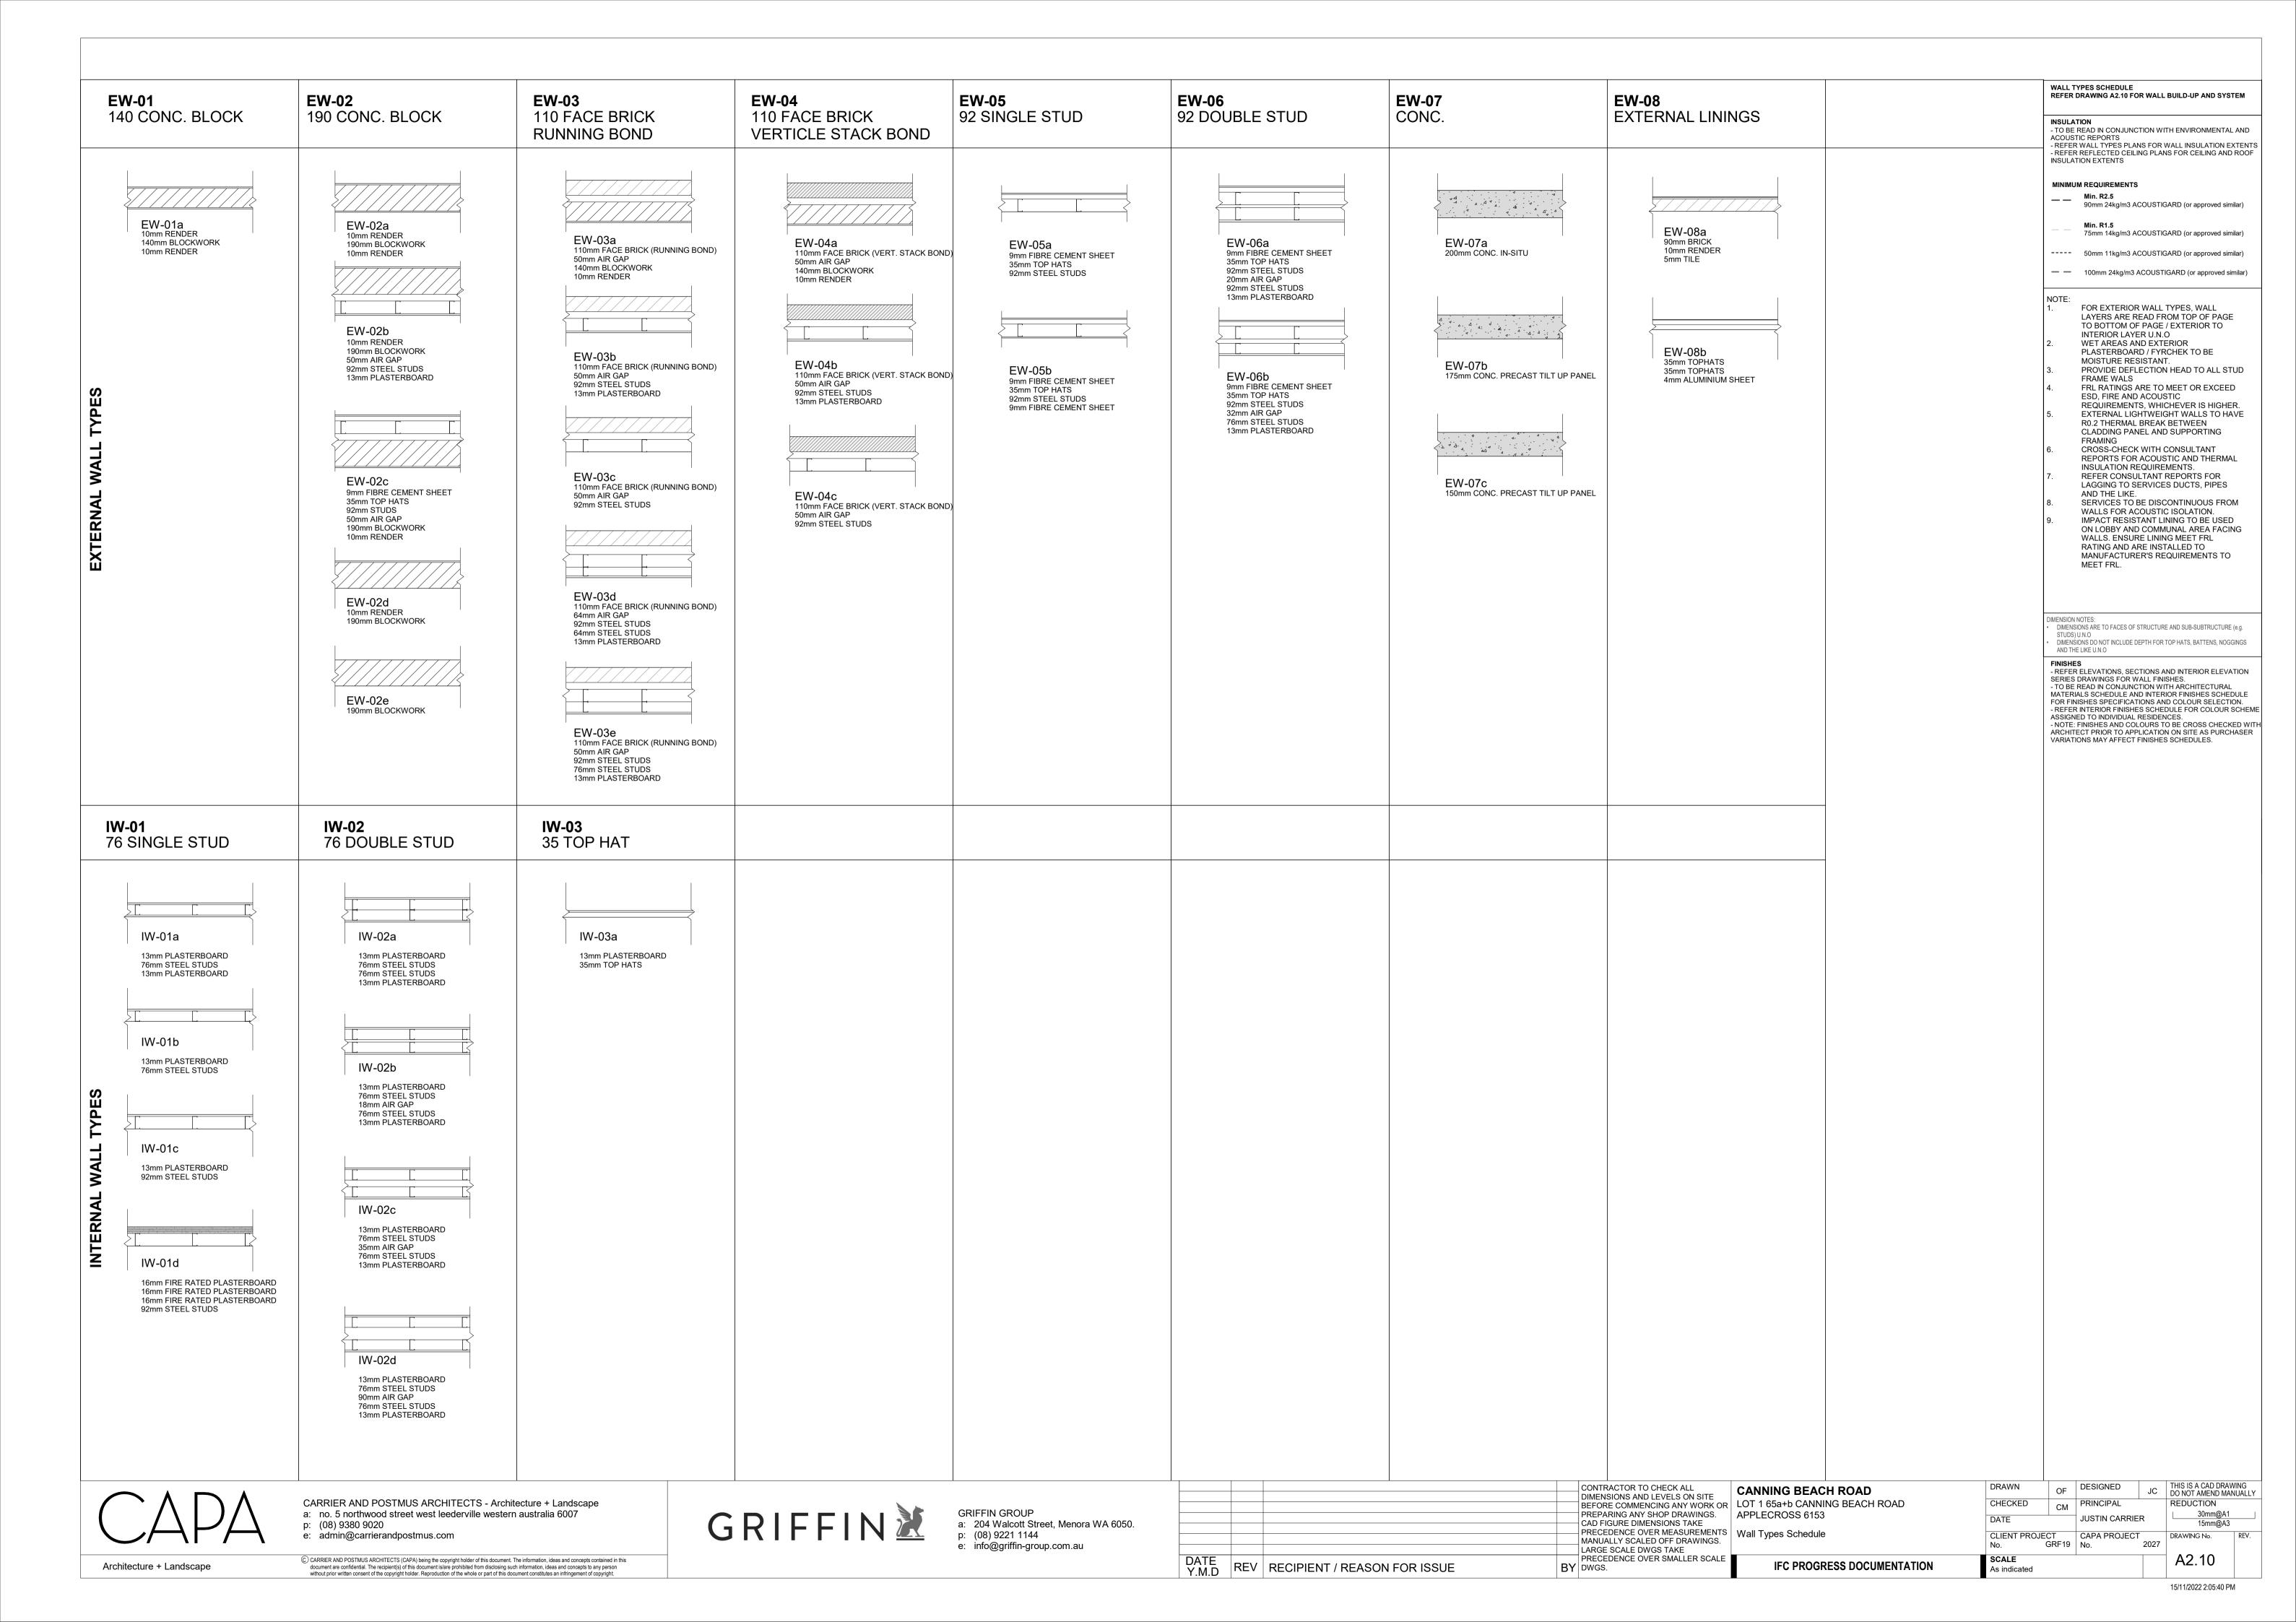
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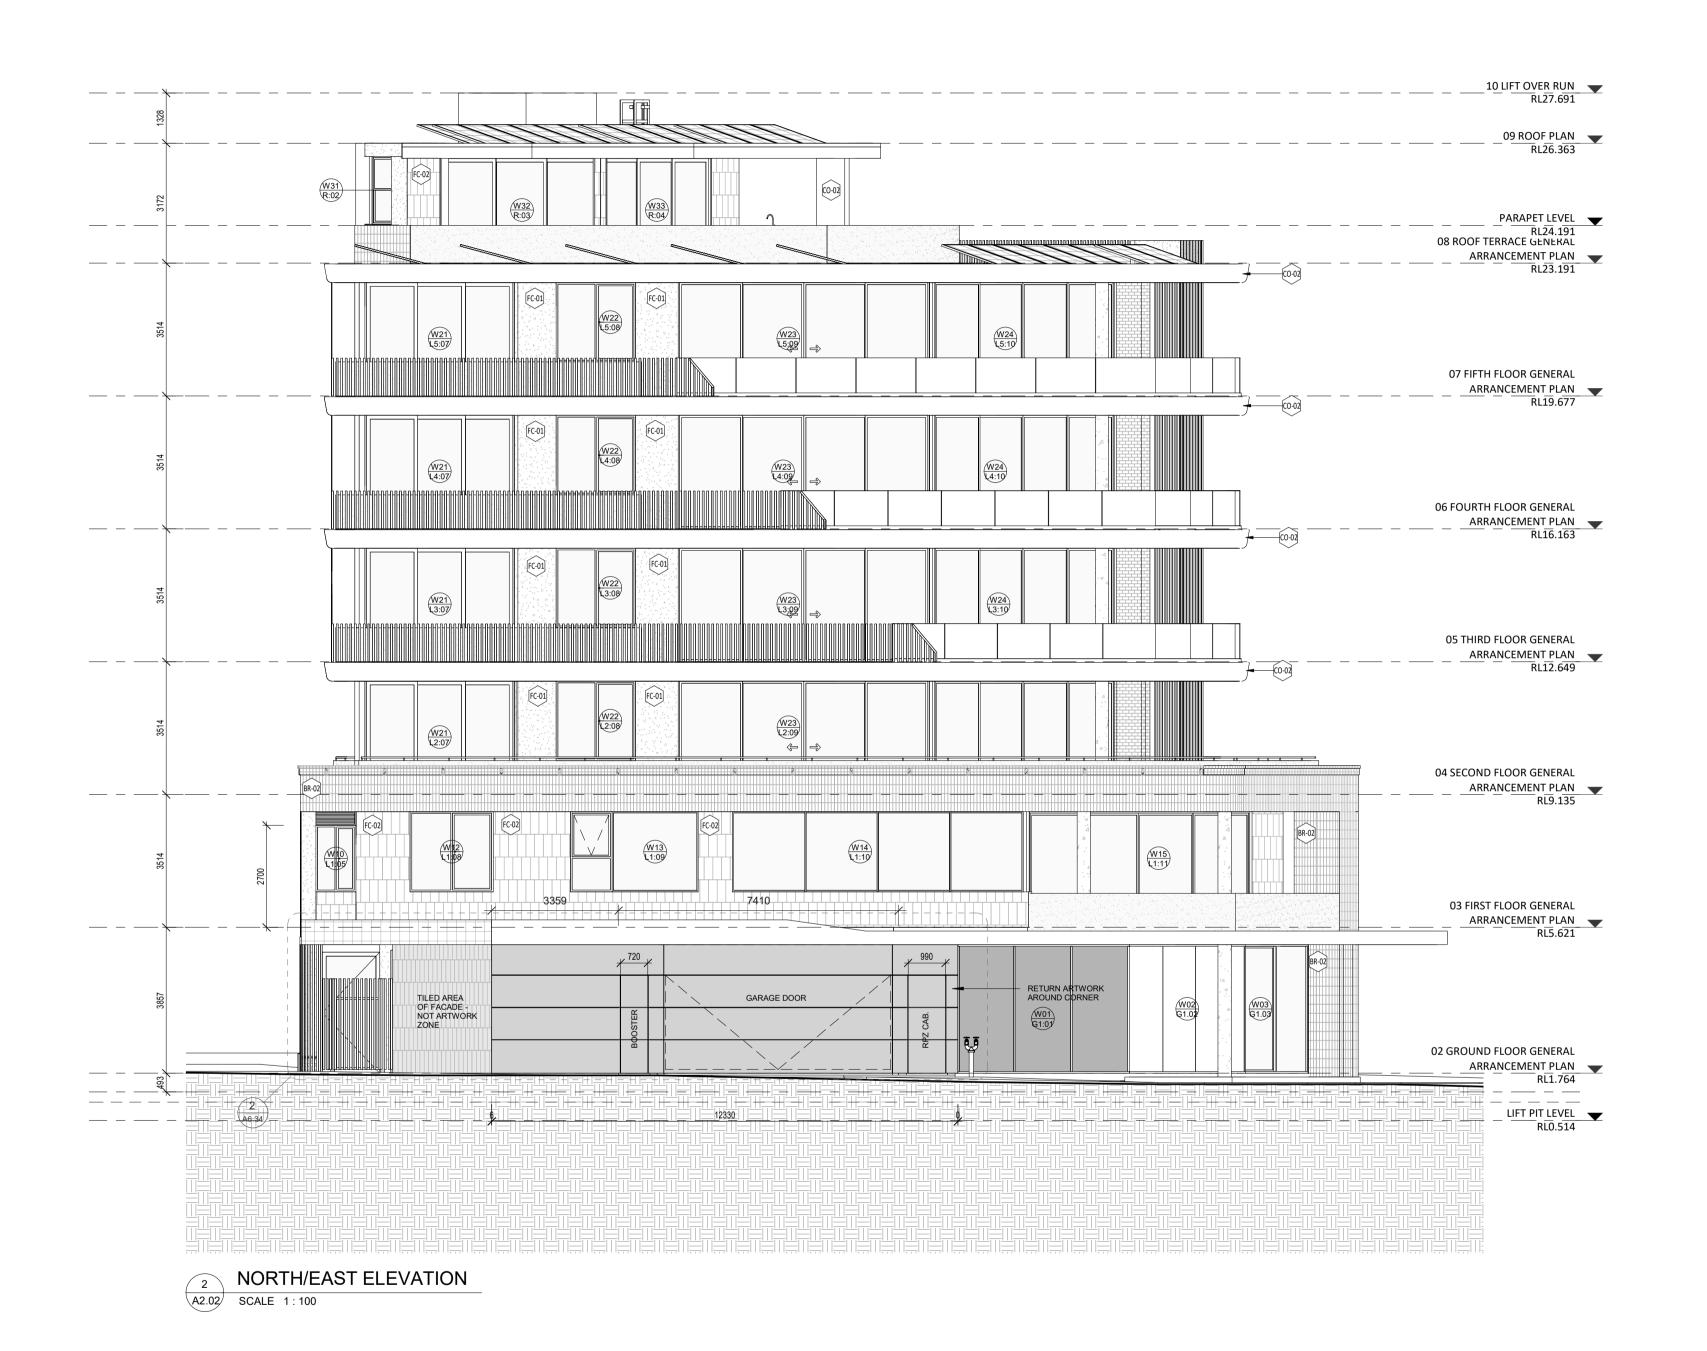
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ALL EXTERNAL FLOOR SURFACES TO FALL AWAY FROM







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	U				
DATE	REV	RECIPIENT / REASON FOR ISSUE	BY	PRECEDENCE OVER SMALLER SCALE DWGS.	
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CANNING BEACH ROAD LOT 1 65a+b CANNING BEACH ROAD APPLECROSS 6153 North/East Elevations

JC THIS IS A CAD DRAWING DO NOT AMEND MANUALLY CM DESIGNED CHECKED PRINCIPAL REDUCTION 30mm@A1 15mm@A3 JUSTIN CARRIER CLIENT PROJECT CAPA PROJECT No. GRF19 No. 2 DRAWING No. 2027 No. **SCALE** 1:100 A3.01 0 IFC PROGRESS DOCUMENTATION

GENERAL NOTES

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EXTERNAL MATERIALS FINISHES

BR-01
BRICKWORK - RUNNING BOND
BRICKWORK - VERTICLE STACK BOND
CO-01
CONCRETE PRE-CAST
CO-02
CB-01
CONCRETE CAST IN-SITU
CONCRETE BLOCKWORK
RN-01
STOLIT K RENDER - WHITE
FC-01
FIBER CEMENT SHEETING

DISCREPANCIES.
ALL EXTERNAL FLOOR SURFACES TO FALL AWAY FROM

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				BEFORE COMMENCING ANY WORK OR	L
				PREPARING ANY SHOP DRAWINGS.	Α
				CAD FIGURE DIMENSIONS TAKE	
				PRECEDENCE OVER MEASUREMENTS	S
				MANUALLY SCALED OFF DRAWINGS.	_
	0			LARGE SCALE DWGS TAKE	
DATE	REV	RECIPIENT / REASON FOR ISSUE	BY	PRECEDENCE OVER SMALLER SCALE DWGS.	
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CANNING BEACH ROAD LOT 1 65a+b CANNING BEACH ROAD APPLECROSS 6153 South/East Elevations

CHECKED PRINCIPAL REDUCTION JUSTIN CARRIER CLIENT PROJECT CAPA PROJECT No. GRF19 No. 2 DRAWING No. 2027 SCALE IFC PROGRESS DOCUMENTATION 1:100

GENERAL NOTES

DIMENSIONS.

DISCREPANCIES.

BUILDING TAG XX-XX

EXTERNAL MATERIALS FINISHES

BR-01 BRICKWORK - RUNNING BOND BR-02 BRICKWORK - VERTICLE STACK BOND

CO-01 CONCRETE PRE-CAST CO-02 CONCRETE CAST IN-SITU CB-01 CONCRETE BLOCKWORK RN-01 STOLIT K RENDER - WHITE FC-01 FIBER CEMENT SHEETING

BUILDING.

ALL DIMENSIONS ARE IN MILLIMETRES U.N.O.

WRITTEN DIMENSIONS SHALL TAKE PRECEDENCE OVER SCALED

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THE MAIN CONTRACTOR IS TO ENSURE THIS DRAWING IS READ IN CONJUNCTION WITH ALL RELEVANT ARCHITECTURAL, STRUCTURAL AND SERVICE CONSULTANT DOCUMENTATION TO

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REFER INTERIOR DOCUMENTATION FOR SETOUTS AND EXACT LOCATIONS OF CABINETRY, FITTINGS, FIXTURES, PLUMBING, FLOOR WASTES AND TILING.

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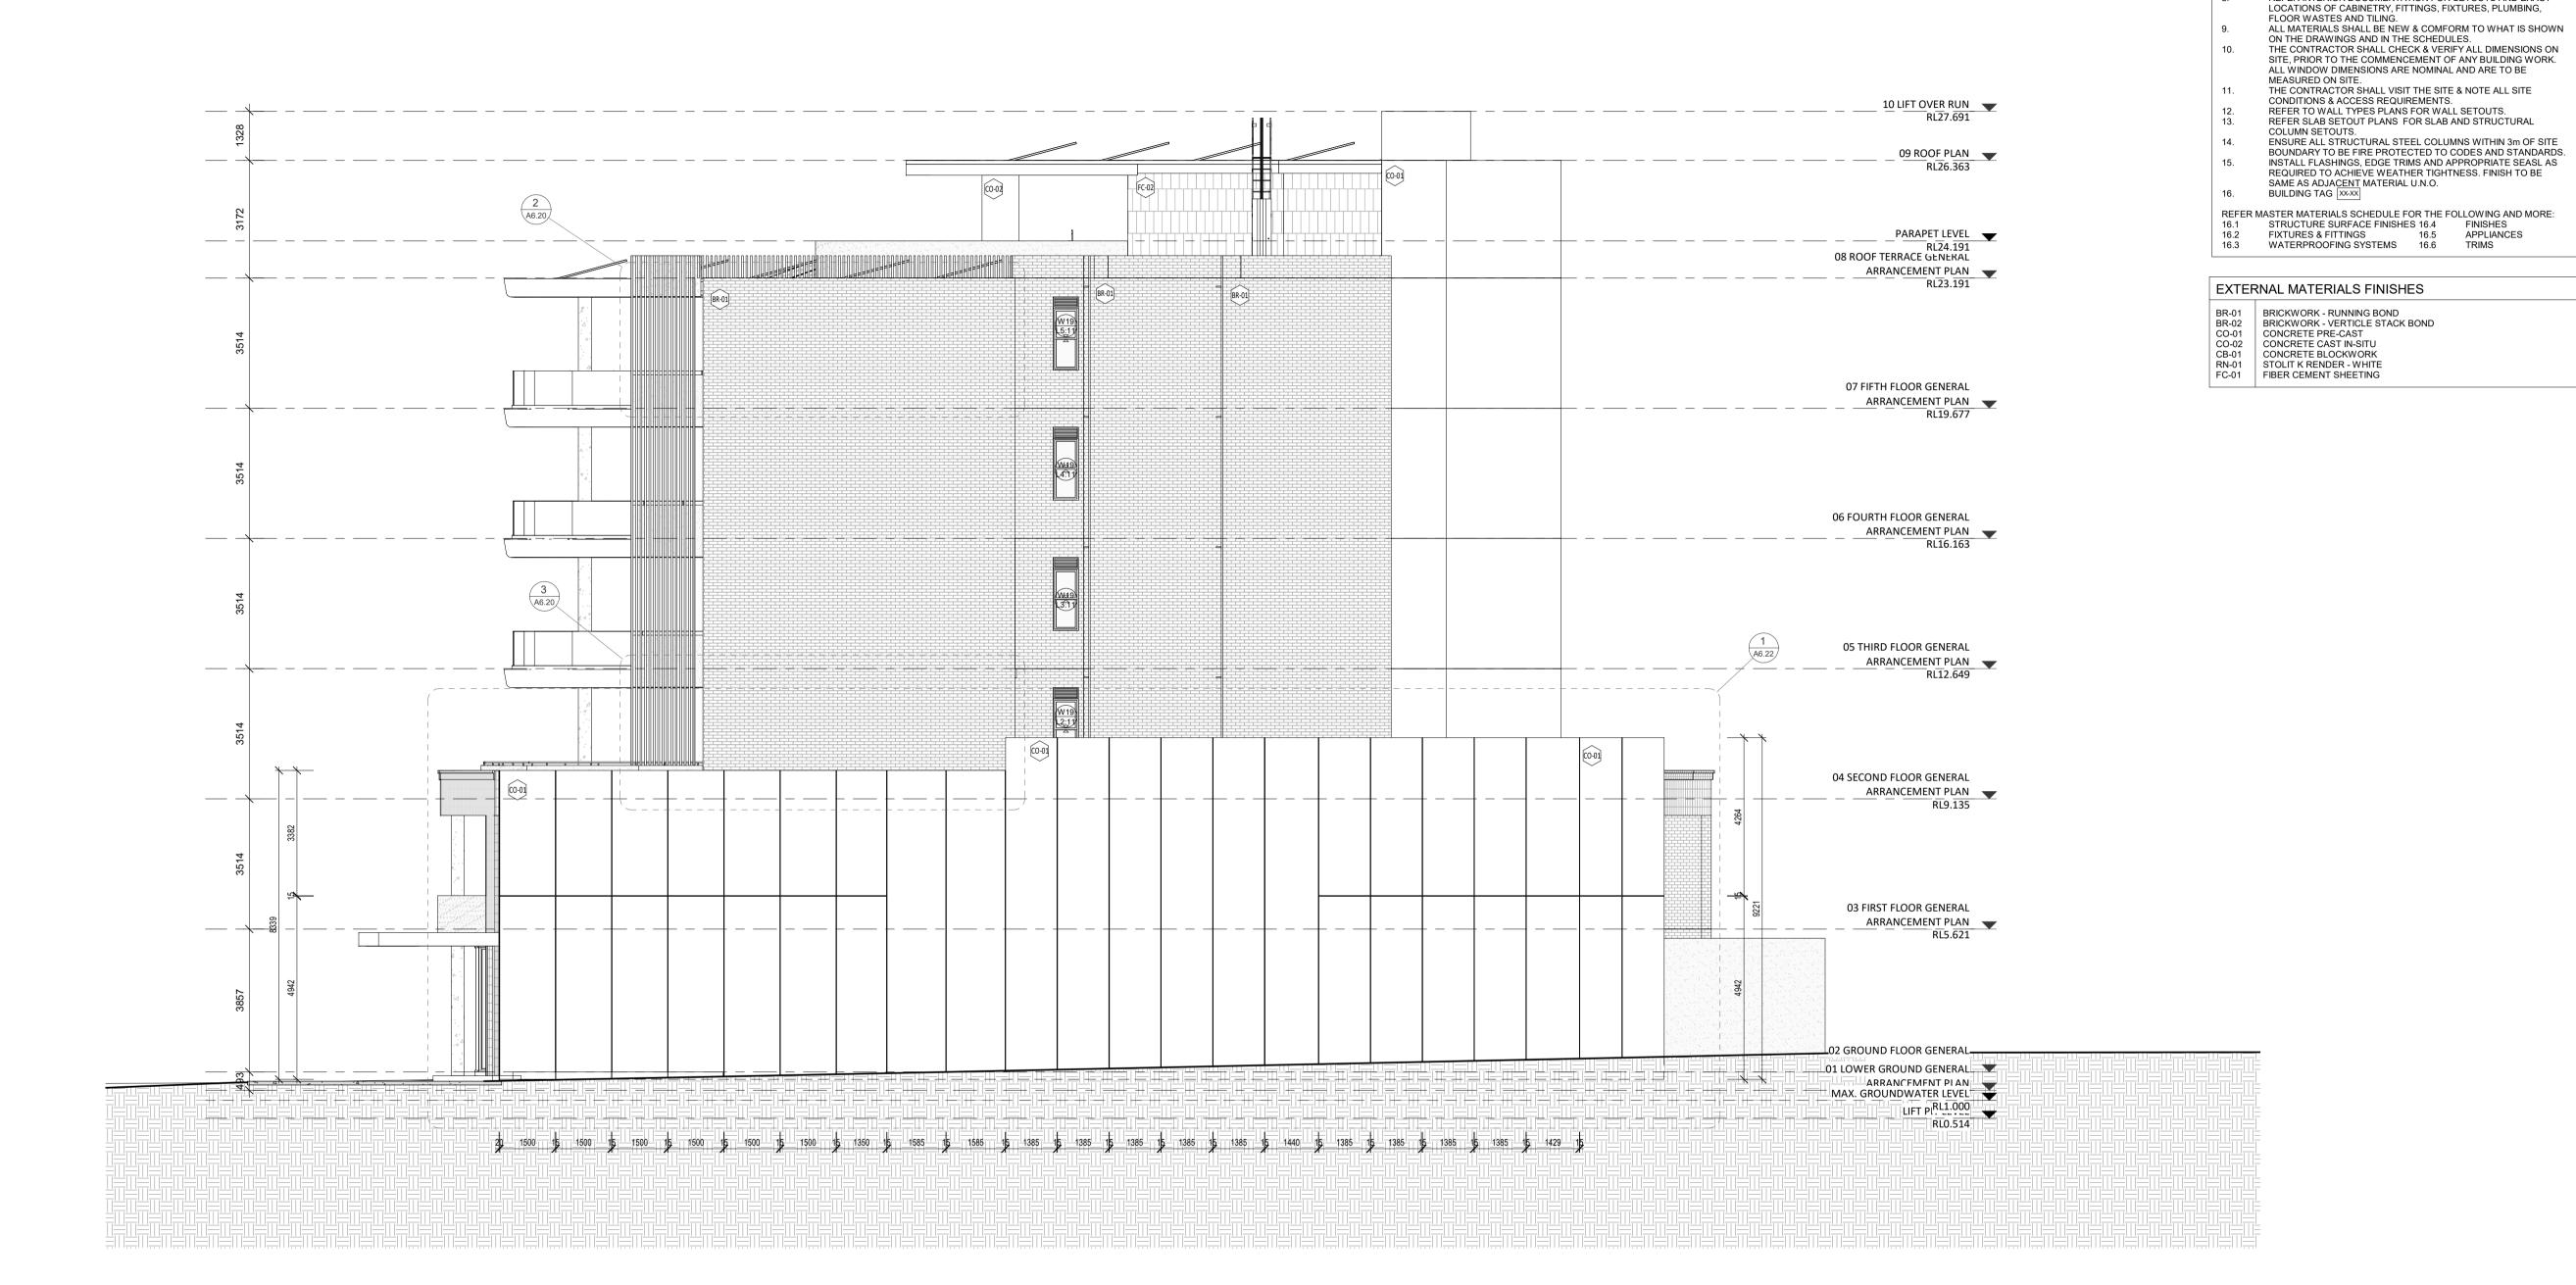
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REFER MASTER MATERIALS SCHEDULE FOR THE FOLLOWING AND MORE: STRUCTURE SURFACE FINISHES 16.4 FINISHES
FIXTURES & FITTINGS 16.5 APPLIANCES
WATERPROOFING SYSTEMS 16.6 TRIMS

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THE CONTRACTOR SHALL VISIT THE SITE & NOTE ALL SITE
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DIMENSIONS AND LEVELS ON SITE PREPARING ANY SHOP DRAWINGS. APPLECROSS 6153 CAD FIGURE DIMENSIONS TAKE PRECEDENCE OVER MEASUREMENTS | West Elevation MANUALLY SCALED OFF DRAWINGS. _ LARGE SCALE DWGS TAKE DATE Y.M.D REV RECIPIENT / REASON FOR ISSUE PRECEDENCE OVER SMALLER SCALE BY DWGS.

CANNING BEACH ROAD BEFORE COMMENCING ANY WORK OR LOT 1 65a+b CANNING BEACH ROAD

IFC PROGRESS DOCUMENTATION

THIS IS A CAD DRAWING Designed NOT AMEND MANUALLY Checker CHECKED REDUCTION JUSTIN CARRIER CLIENT PROJECT CAPA PROJECT No. GRF19 No. 2 DRAWING No. 2027 **SCALE** 1: 100 A3.03

GENERAL NOTES

ALL DIMENSIONS ARE IN MILLIMETRES U.N.O. WRITTEN DIMENSIONS SHALL TAKE PRECEDENCE OVER SCALED

CONTRACTOR SHALL CARRY OUT WORK IN CONFORMANCE WITH THE B.C.A./N.C.C. RELEVANT STANDARDS AND THE LOCAL

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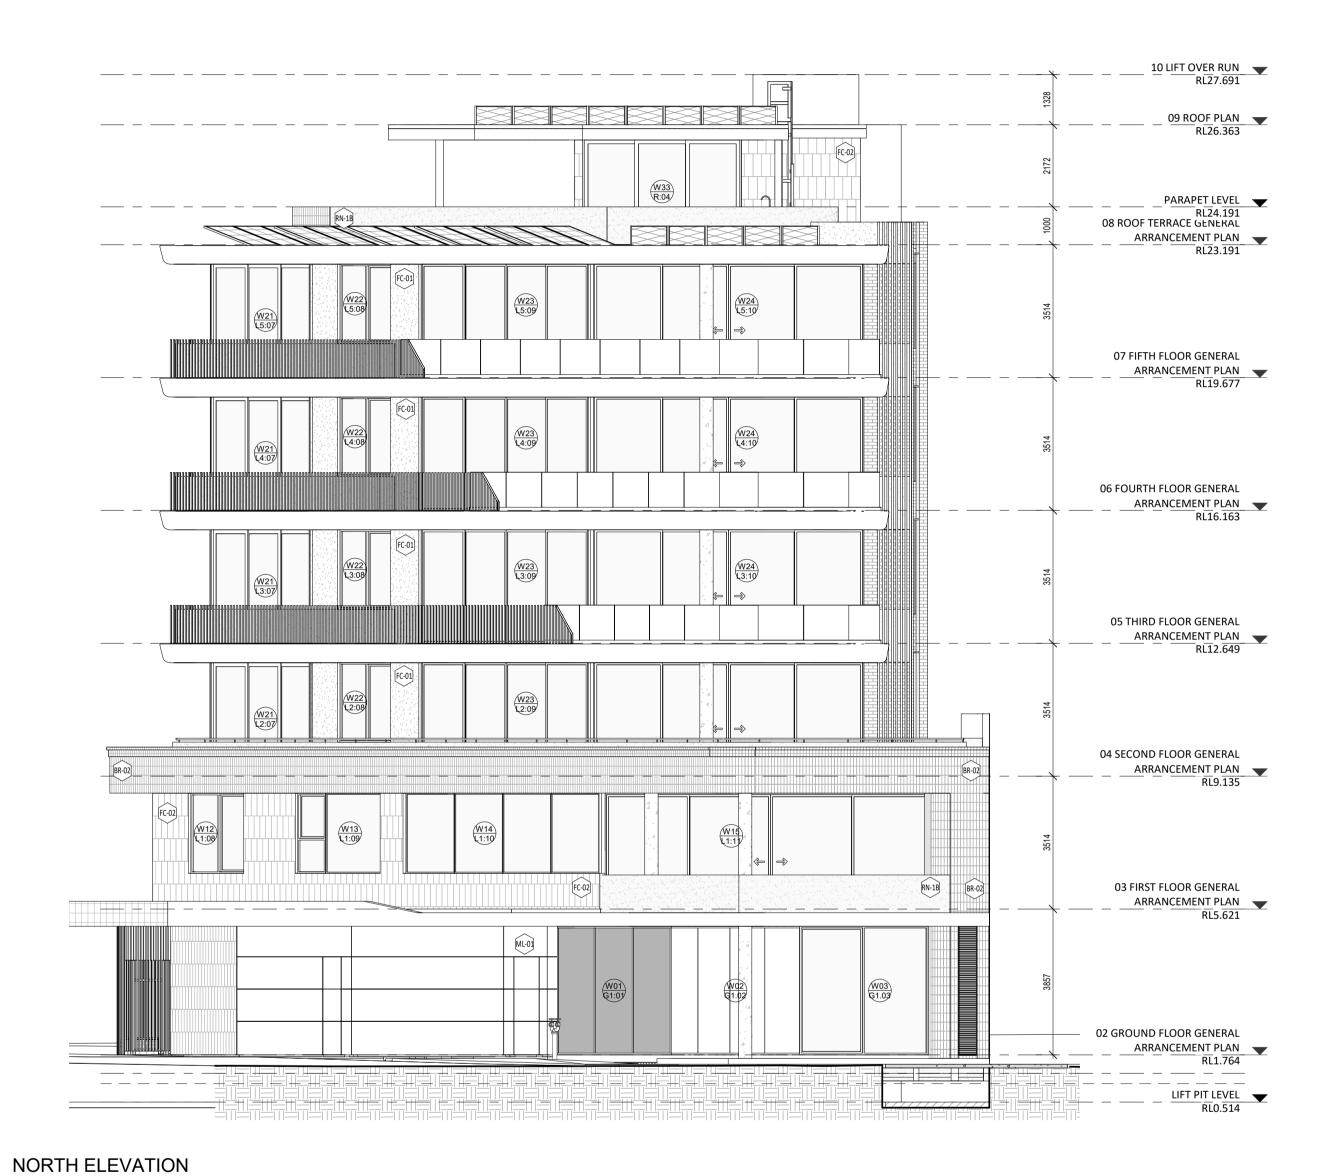
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SEEK CLARIFICATION FROM SUPERINTENDENT FOR ANY DISCREPANCIES. ALL EXTERNAL FLOOR SURFACES TO FALL AWAY FROM

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CANNING BEACH ROAD LOT 1 65a+b CANNING BEACH ROAD APPLECROSS 6153 North Elevation

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GENERAL NOTES

DIMENSIONS.

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FIXTURES & FITTINGS 16.5 APPLIANCES
WATERPROOFING SYSTEMS 16.6 TRIMS

CONDITIONS & ACCESS REQUIREMENTS.

SAME AS ADJACENT MATERIAL U.N.O.

BUILDING TAG XX-XX


EXTERNAL MATERIALS FINISHES

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ALL MATERIALS SHALL BE NEW & COMFORM TO WHAT IS SHOWN ON THE DRAWINGS AND IN THE SCHEDULES.
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MANUALLY SCALED OFF DRAWINGS.

LARGE SCALE DWGS TAKE

PRECEDENCE OVER SMALLER SCALE DATE Y.M.D REV RECIPIENT / REASON FOR ISSUE BY DWGS.

CONTRACTOR TO CHECK ALL
DIMENSIONS AND LEVELS ON SITE
BEFORE COMMENCING ANY WORK OR
PREPARING ANY SHOP DRAWINGS.
CAD FIGURE DIMENSIONS TAKE
PRECEDENCE OVER MEASUREMENTS
MANUALLY SCALED OFF DRAWINGS.

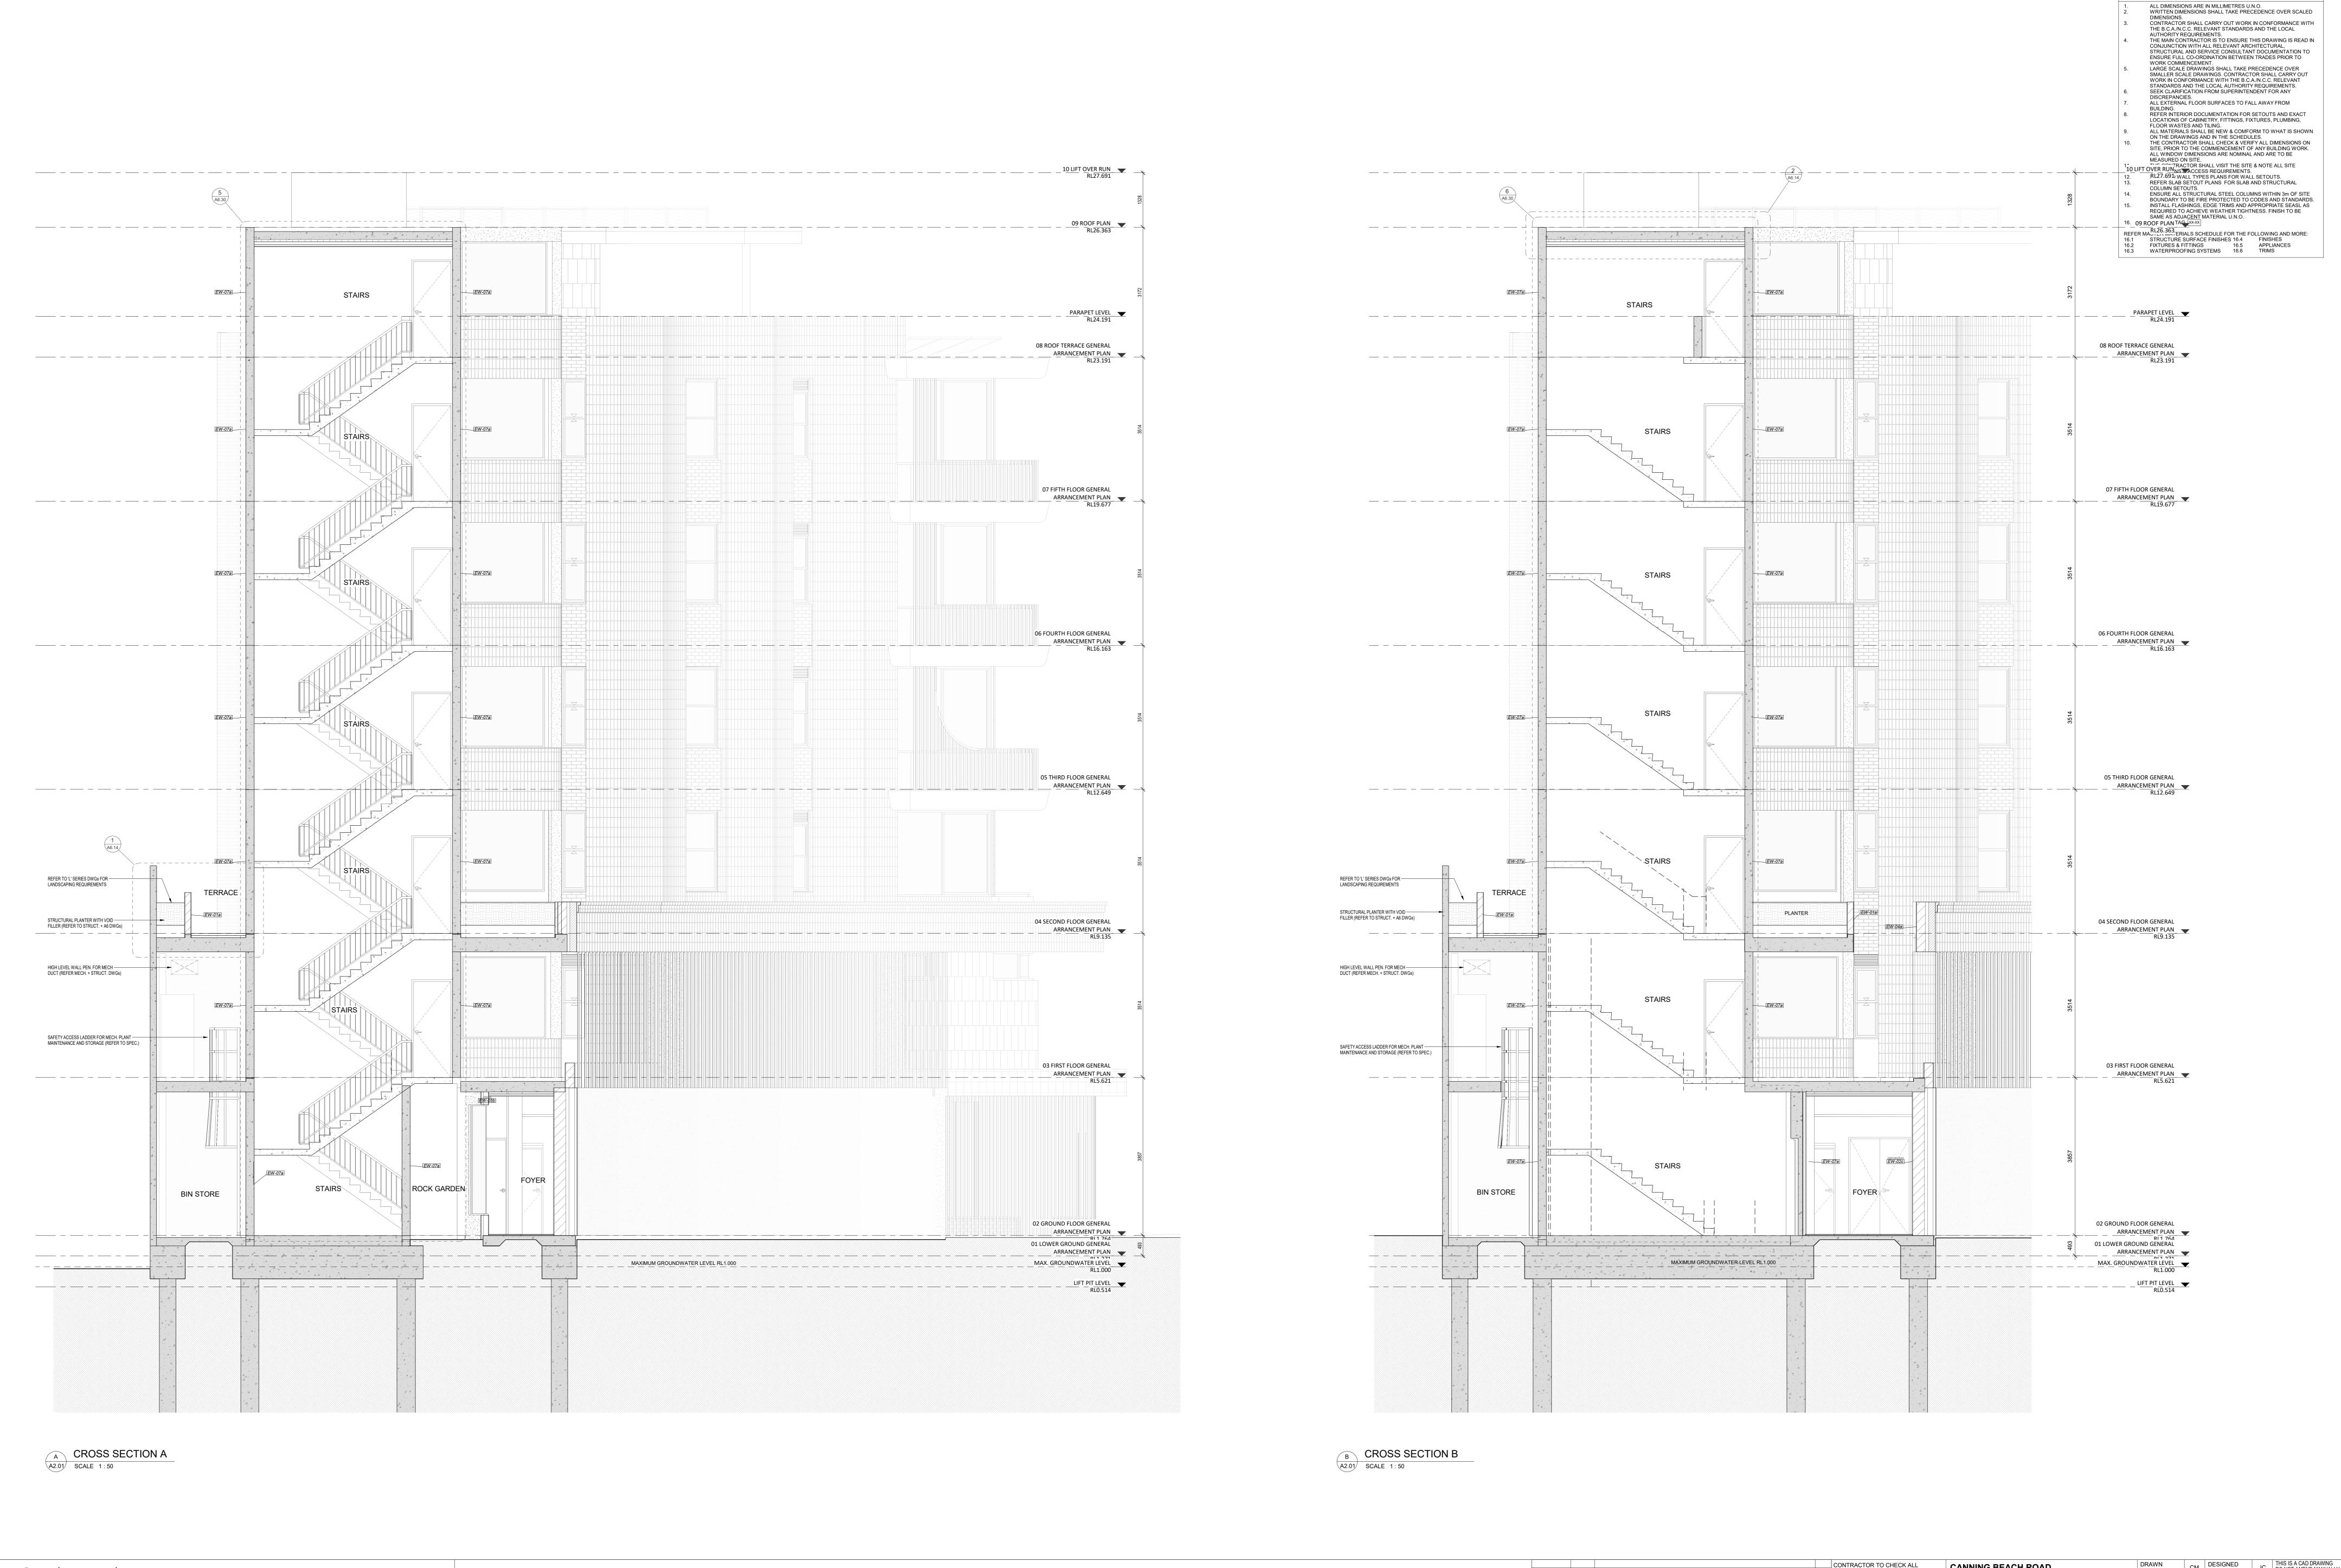IFC PROGRESS DOCUMENTATION

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REDUCTION

1:50@A0
1:100@A2 CLIENT PROJECT CAPA PROJECT DRAWING No. REV. No. GRF19 No. 2027 SCALE As indicated

GENERAL NOTES

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REINFORCED SUSPENDED CONCRETE — SLAB (REFER TO STRUCT. DWGs) REFER TO 'L' SERIES DWGs FOR ----REFER TO 'A7' SERIES LANDSCAPING REQUIREMENTS FOR INTERNAL LAYOUTS -UAT/PDR -PLANTER PLANTER PLANTER EW-01a EW-01a 08 ROOF TERRACE GENERAL 08 ROOF TERRACE GENERAL ARRANCEMENT PLAN RL23.191 IW-01a IW-01a BED 2 STUDY STORE LIVING RETREAT FOR INTERNAL LAYOUTS 07 FIFTH FLOOR GENERAL 07 FIFTH FLOOR GENERAL ARRANCEMENT PLAN RL19.677 ARRANCEMENT PLAN RL19.677 ENTRANCE CORRIDOR FOR INTERNAL LAYOUTS 06 FOURTH FLOOR GENERAL 06 FOURTH FLOOR GENERAL ARRANCEMENT PLAN RL16.163 STORE BED 2 ENTRANCE CORRIDOR FOR INTERNAL LAYOUTS 05 THIRD FLOOR GENERAL 05 THIRD FLOOR GENERAL ARRANCEMENT PLAN RL12.649 ARRANCEMENT PLAN _____ IW-01a IW-01a STORE RETREAT BALCONY ENTRANCE CORRIDOR REFER TO 'L' SERIES DWGs FOR ---REFER TO 'L' SERIES DWGs FOR -REFER TO 'L' SERIES DWGs FOR ----REFER TO 'A7' SERIES FOR INTERNAL LAYOUTS LANDSCAPING REQUIREMENTS LANDSCAPING REQUIREMENTS LANDSCAPING REQUIREMENTS ► PLANTER EW-04a 04 SECOND FLOOR GENERAL 04 SECOND FLOOR GENERAL ARRANCEMENT PLAN ARRANCEMENT PLAN 300w x 300h VENTILATION OPENING FOR TANK (REFER FIRE + STRUCT. DWGs) BED 3 ENTRANCE CORRIDOR SCULLERY 240/240/240 **EW-02c** CLEARANCE ZONES AROUND CARSTACKER – (REFER TO SUPPLIER SPECIFICATION) 03 FIRST FLOOR GENERAL 03 FIRST FLOOR GENERAL ARRANCEMENT PLAN RL5.621 ARRANCEMENT PLAN RL5.621 300w x 300h VENTILATION OPENING FOR - STRUCT. DWGs) |-----240/240/240 EW-02c 240/240/240 **EW-02d** CAR STACKER BIN STORE FOYER 02 GROUND FLOOR GENERAL 02 GROUND FLOOR GENERAL ARRANCEMENT PLAN

#11 76A

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1:50@A0 THIS IS A CAD DRAWING CONTRACTOR TO CHECK ALL CANNING BEACH ROAD DIMENSIONS AND LEVELS ON SITE CARRIER AND POSTMUS ARCHITECTS - Architecture + Landscape BEFORE COMMENCING ANY WORK OR LOT 1 65a+b CANNING BEACH ROAD PREPARING ANY SHOP DRAWINGS. APPLECROSS 6153 JUSTIN CARRIER 1:50@A0 1:100@A2 a: no. 5 northwood street west leederville western australia 6007 CAD FIGURE DIMENSIONS TAKE p: (08) 9380 9020 PRECEDENCE OVER MEASUREMENTS | Cross Section C + D CLIENT PROJECT CAPA PROJECT DRAWING No. REV. e: admin@carrierandpostmus.com MANUALLY SCALED OFF DRAWINGS. GRF19 No. 2027 LARGE SCALE DWGS TAKE

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16.3 WATERPROOFING SY

GENERAL NOTES

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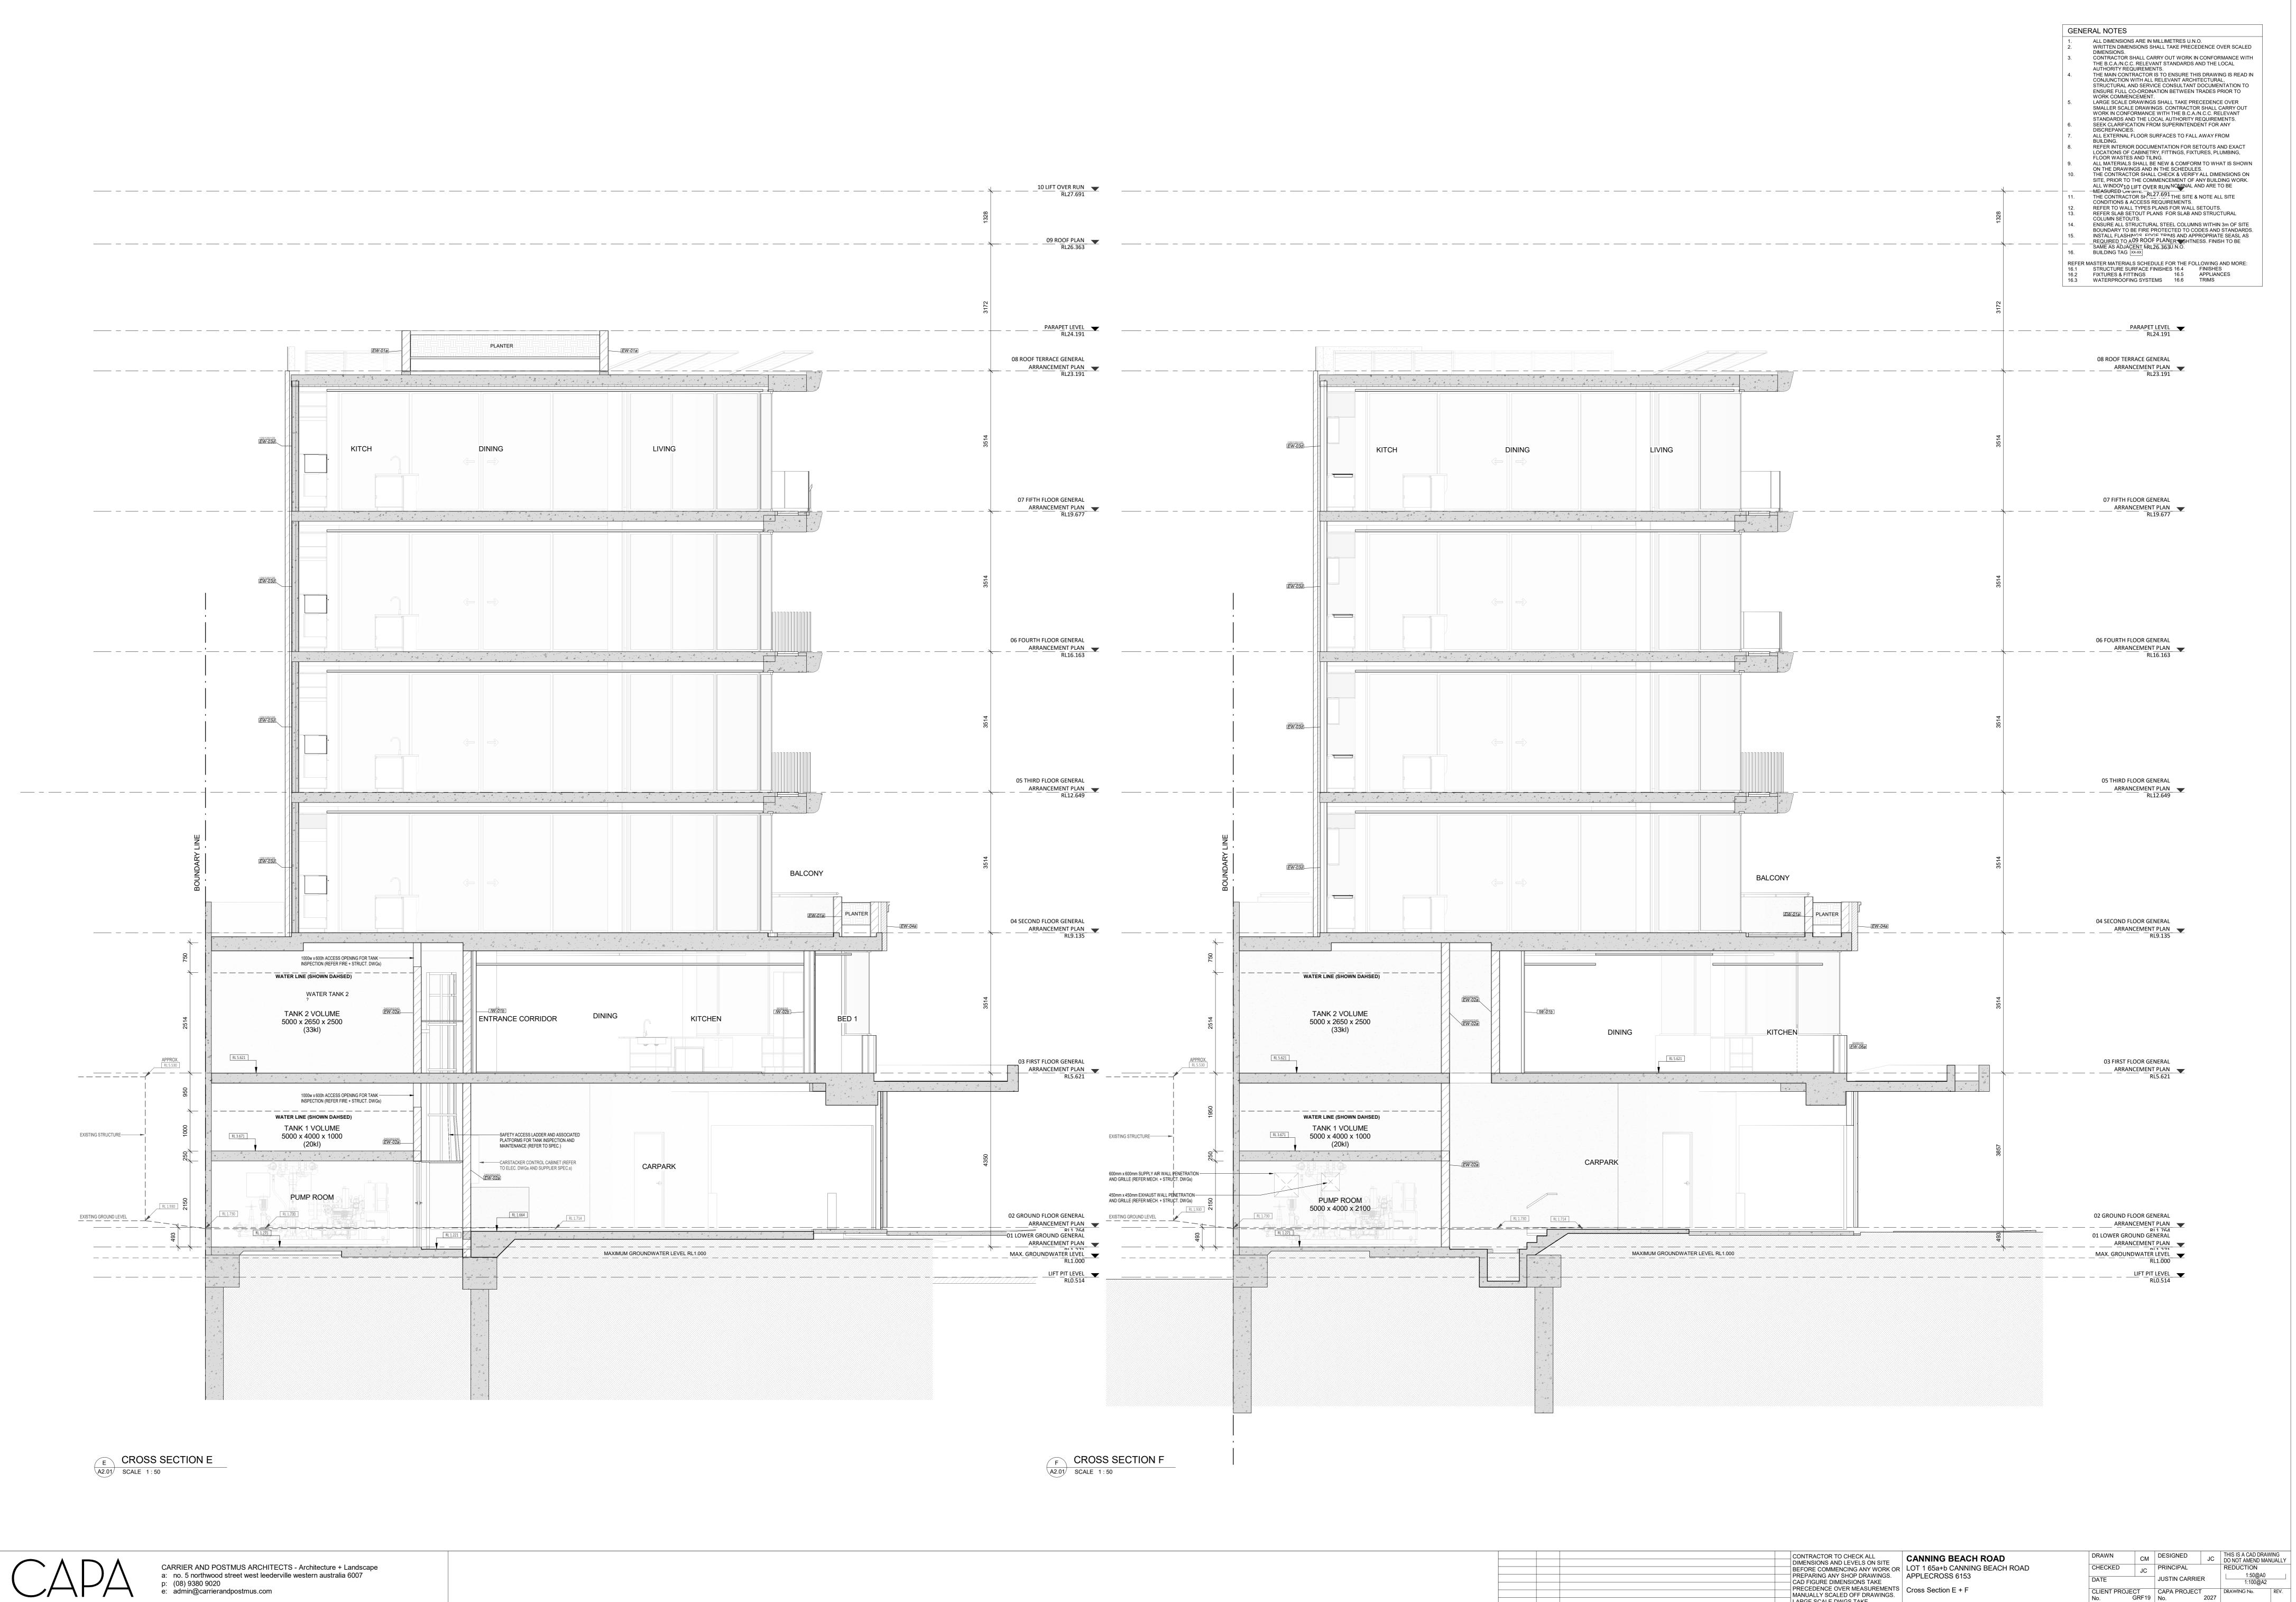
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PRECEDENCE OVER SMALLER SCALE

BY DWGS.

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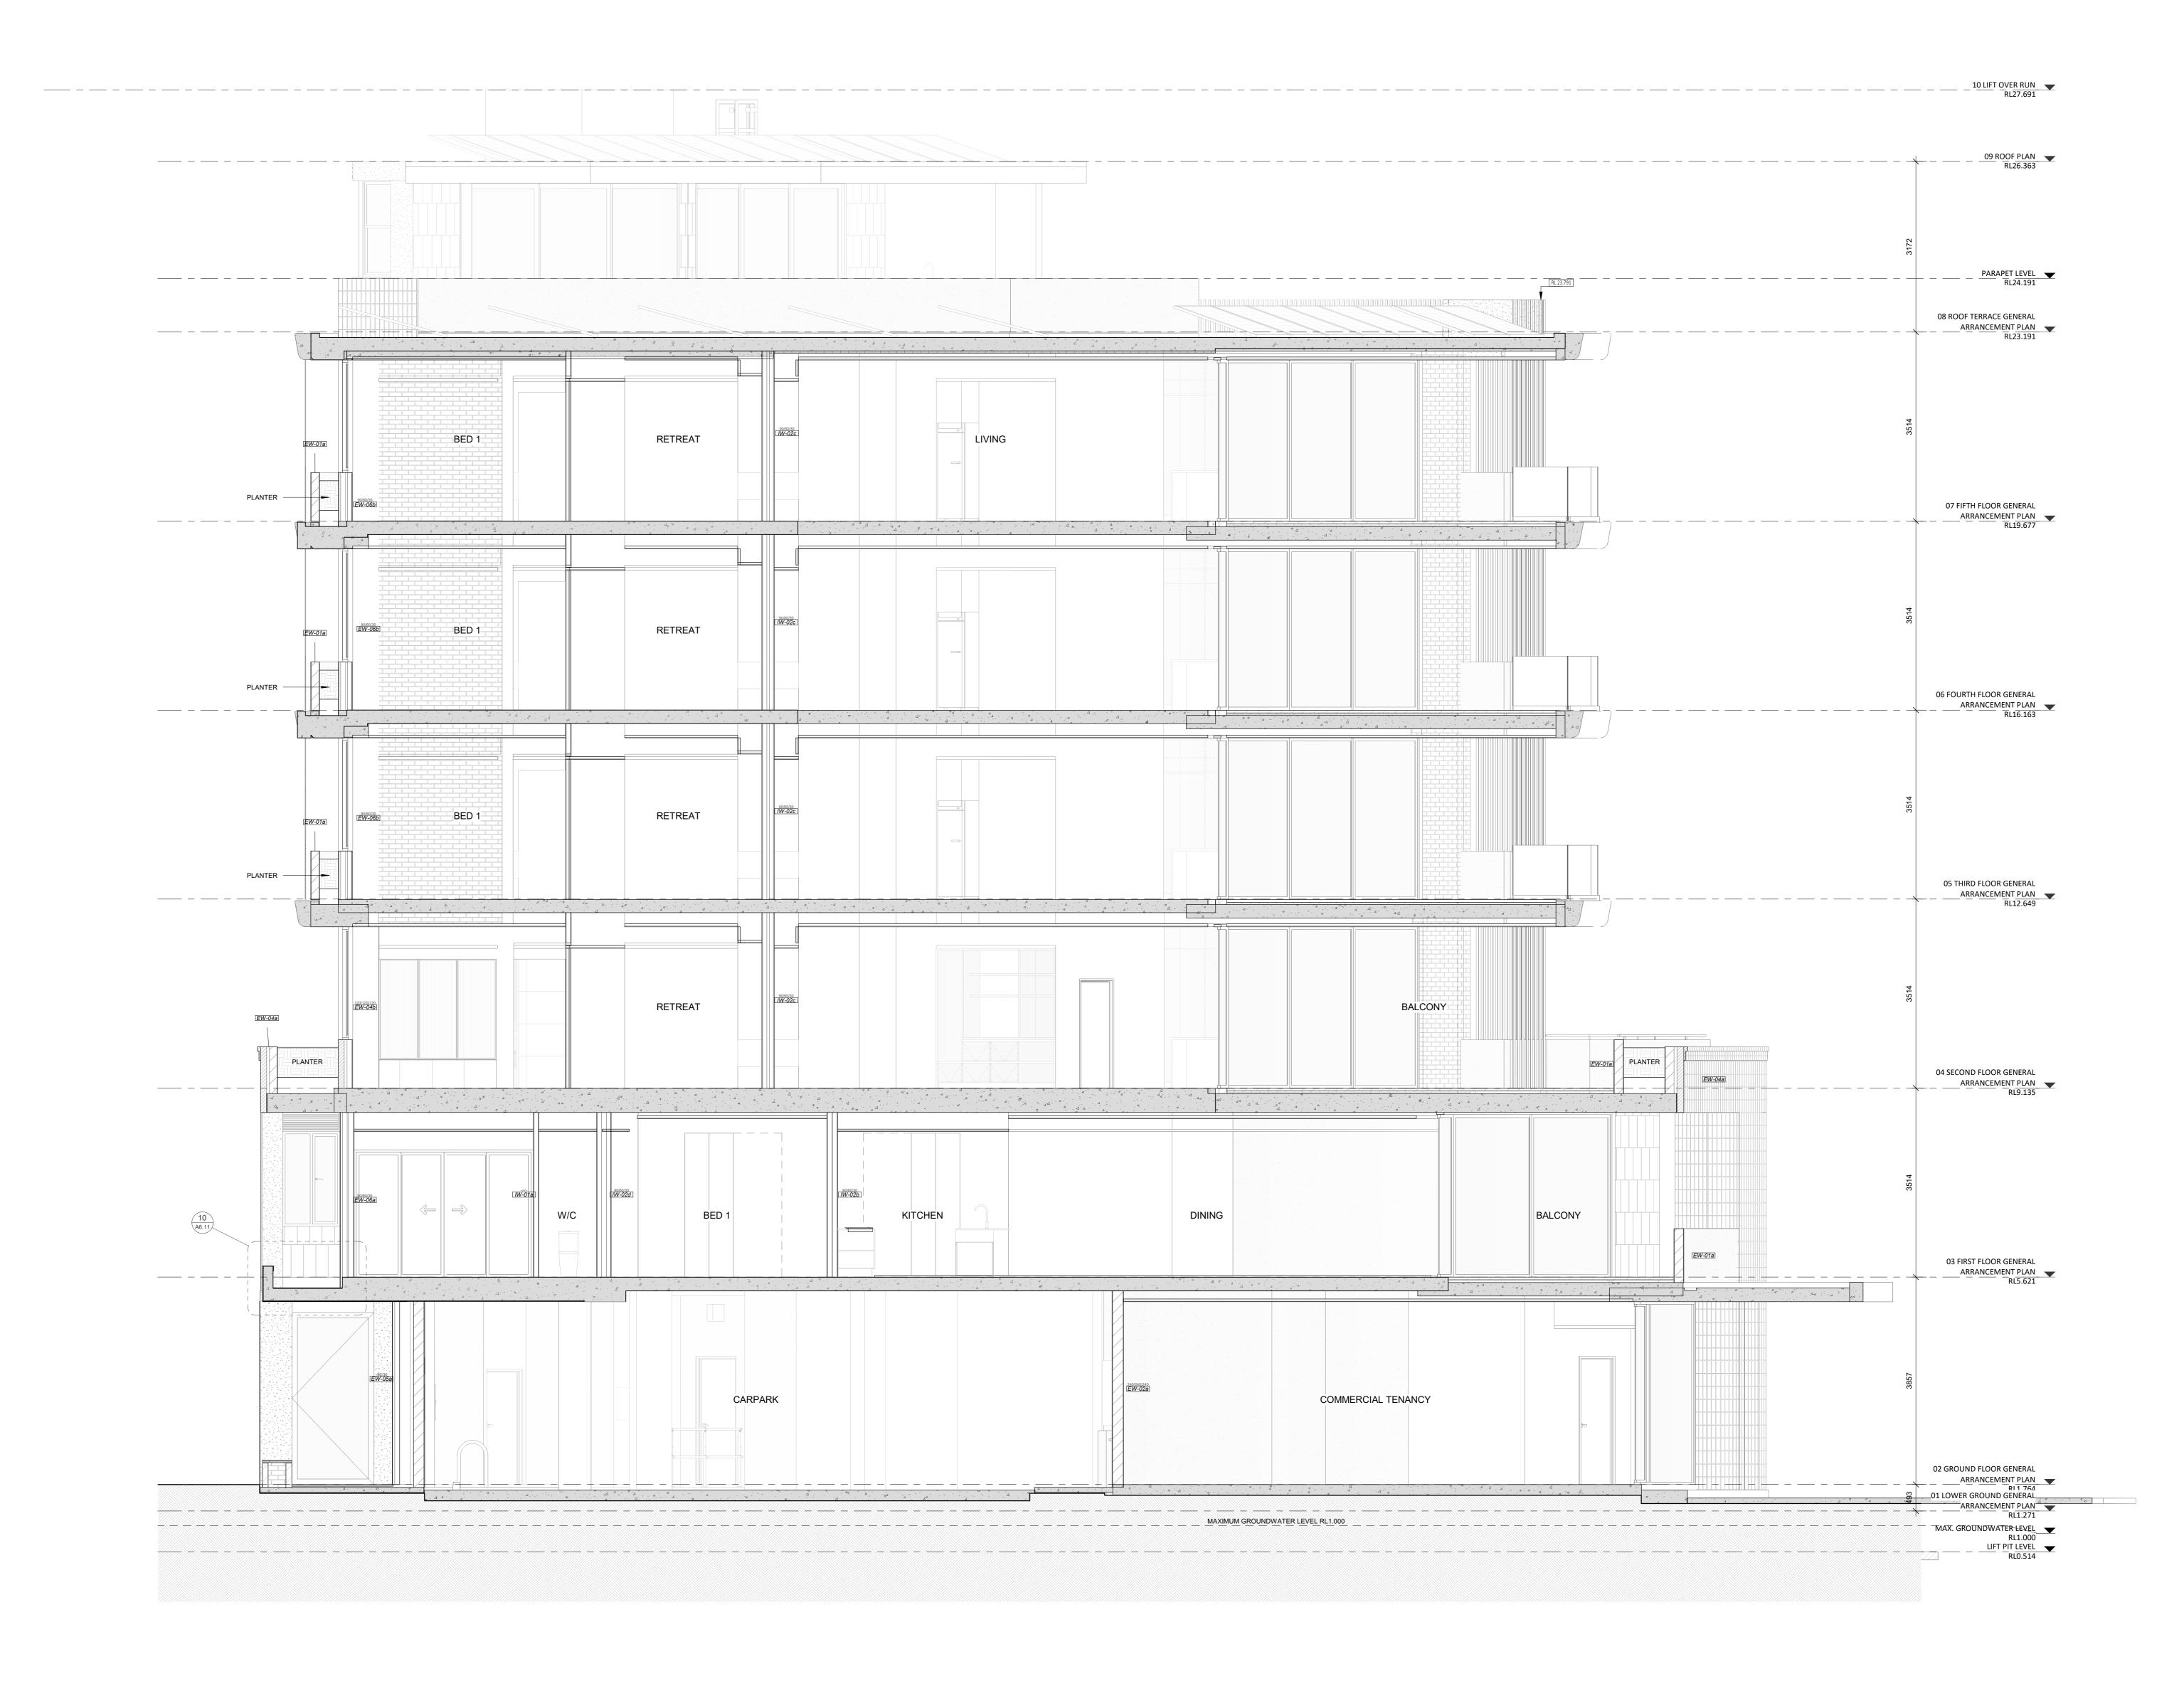
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LARGE SCALE DWGS TAKE
PRECEDENCE OVER SMALLER SCALE DATE Y.M.D REV RECIPIENT / REASON FOR ISSUE BY DWGS.

IFC PROGRESS DOCUMENTATION

No. GRF19 No. 2027 SCALE As indicated

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CONTRACTOR TO CHECK ALL DIMENSIONS AND LEVELS ON SITE CAD FIGURE DIMENSIONS TAKE
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LARGE SCALE DWGS TAKE
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CANNING BEACH ROAD BEFORE COMMENCING ANY WORK OR PREPARING ANY SHOP DRAWINGS.

APPLECROSS 6153 IFC PROGRESS DOCUMENTATION

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GENERAL NOTES

16. BUILDING TAG XX-XX

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BUILDING TAG

REFER MASTER MATERIALS SCHEDULE FOR THE FOLLOWING AND MORE:


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16.2 FIXTURES & FITTINGS 16.5 APPLIANCES

16.3 WATERPROOFING SYSTEMS 16.6 TRIMS

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GENERAL NOTES

Architecture + Landscape


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16. BUILDING TAG | xx-xx |

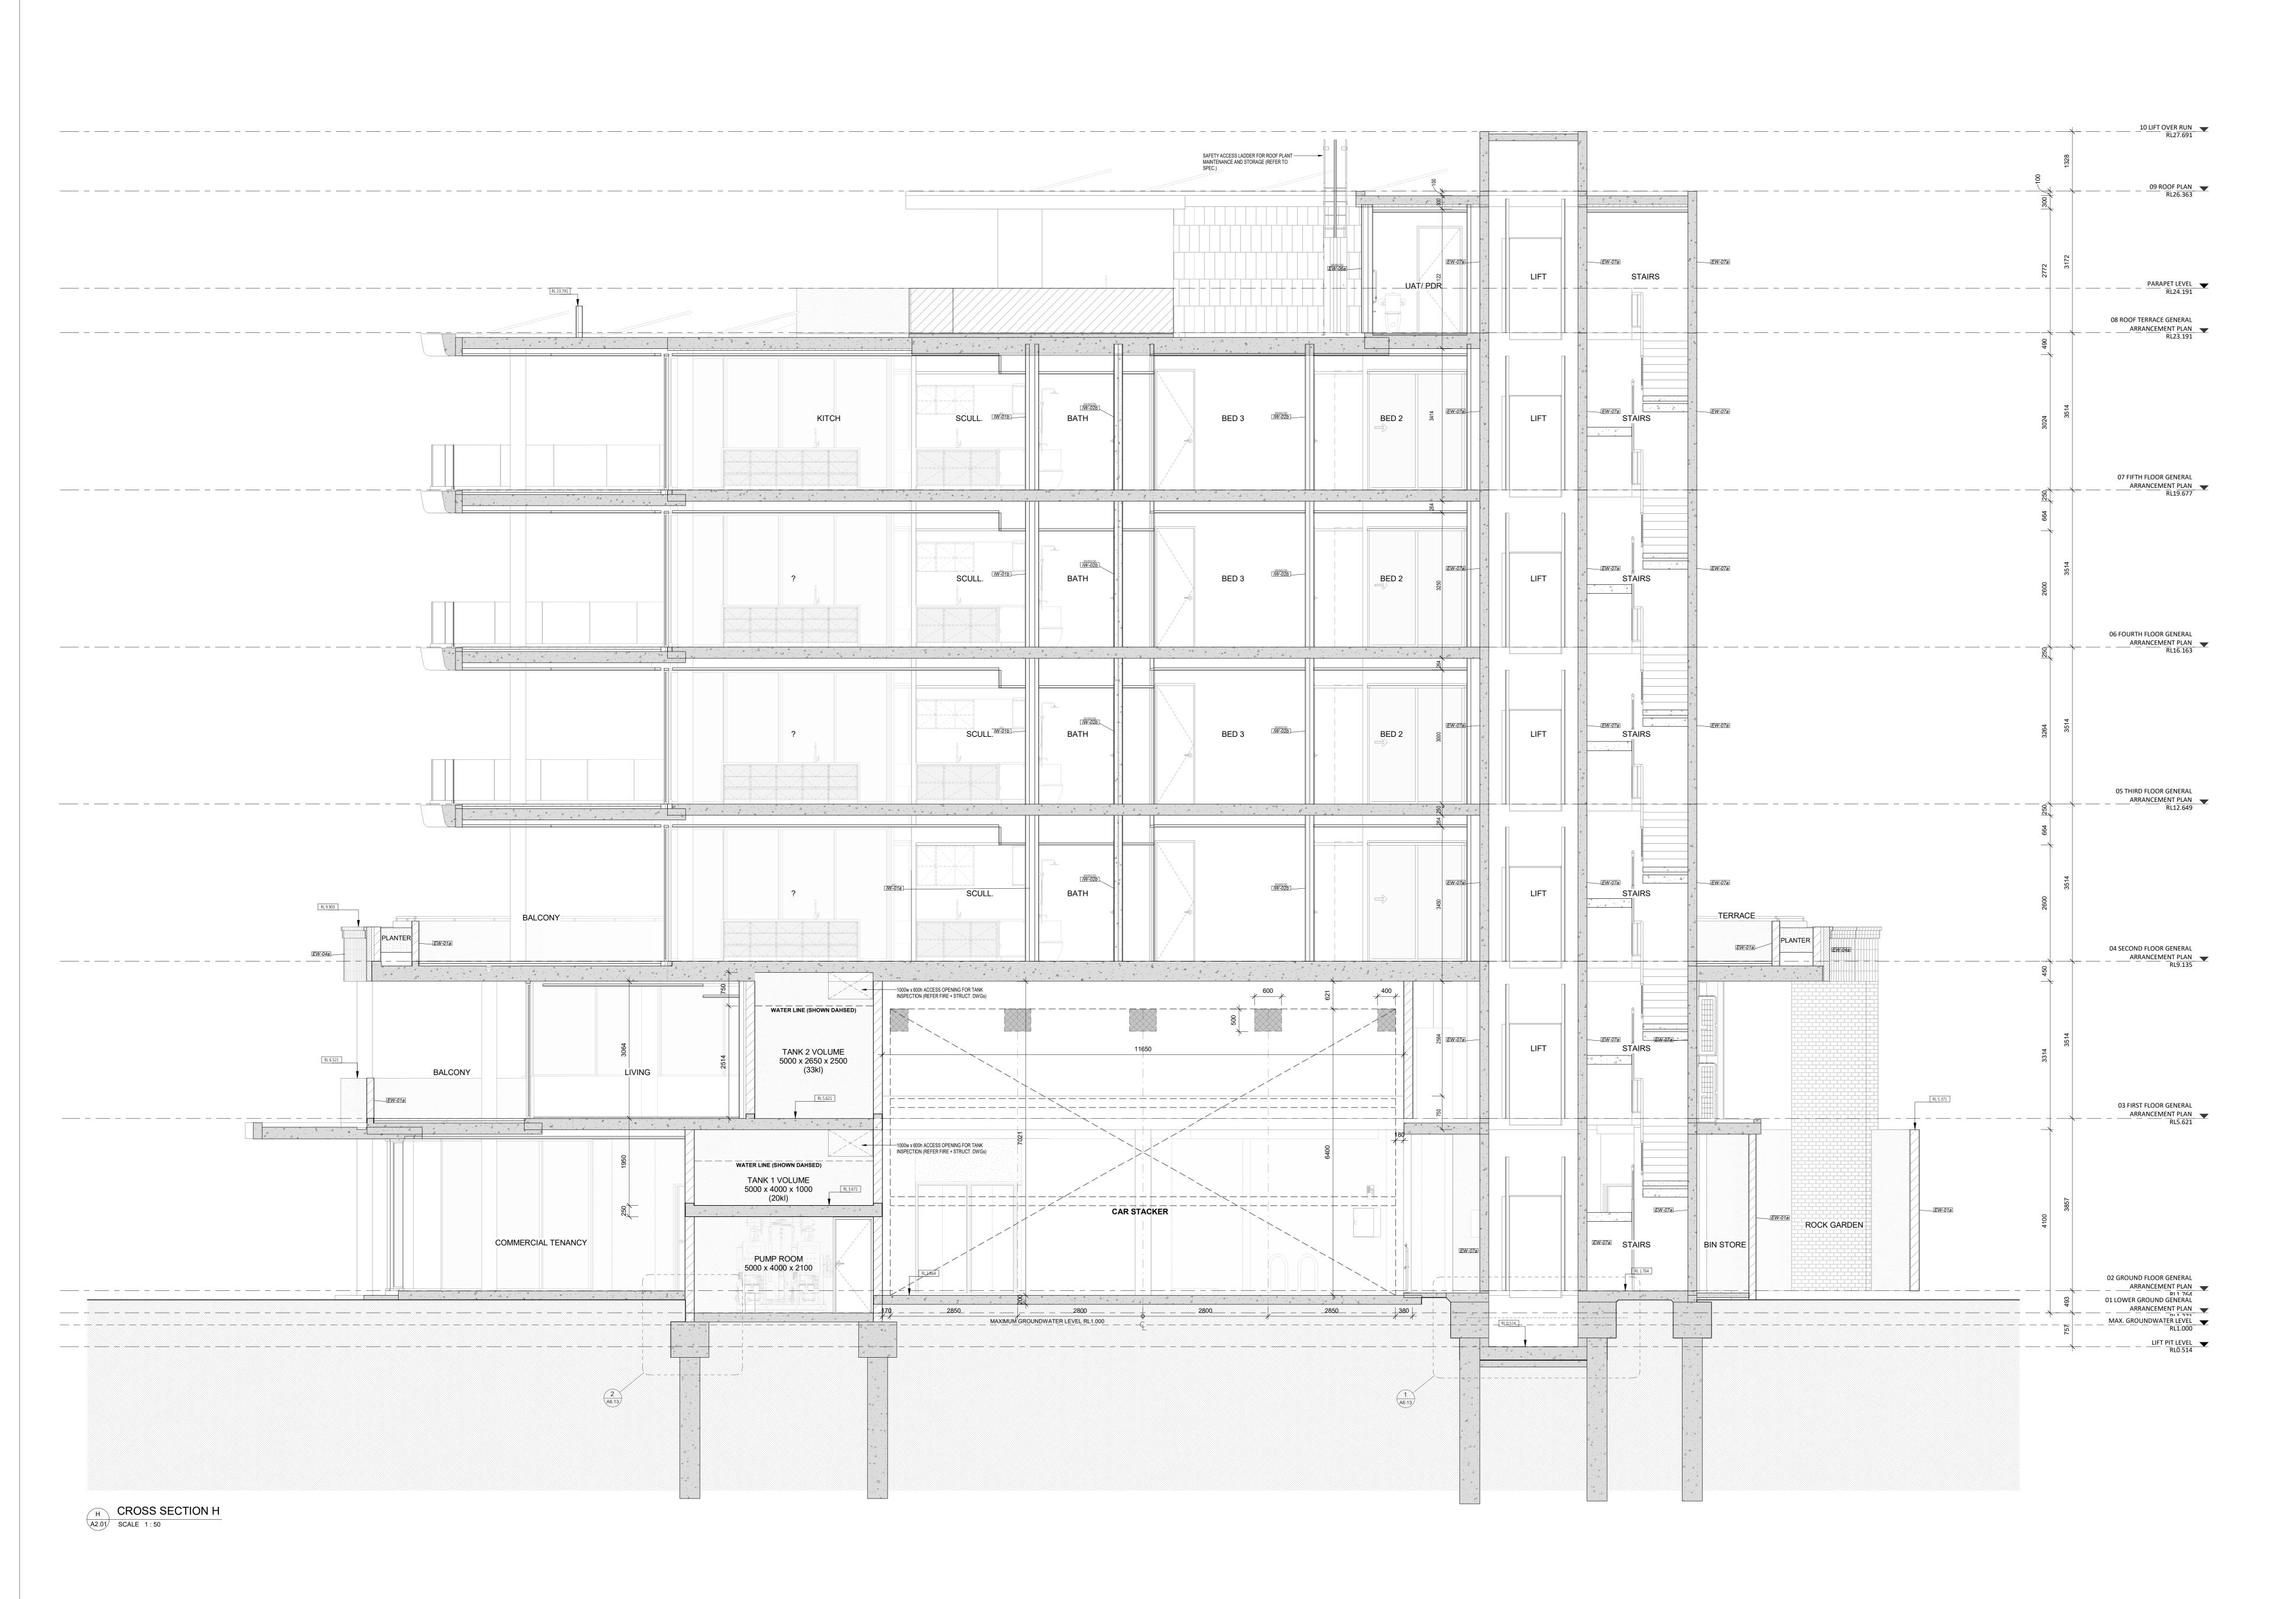REFER MASTER MATERIALS SCHEDULE FOR THE FOLLOWING AND MORE:
16.1 STRUCTURE SURFACE FINISHES 16.4 FINISHES
16.2 FIXTURES & FITTINGS 16.5 APPLIANCES
16.3 WATERPROOFING SYSTEMS 16.6 TRIMS

CONTRACTOR TO CHECK ALL DIMENSIONS AND LEVELS ON SITE CAD FIGURE DIMENSIONS TAKE
PRECEDENCE OVER MEASUREMENTS
Cross Section I

BY DWGS.


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CANNING BEACH ROAD BEFORE COMMENCING ANY WORK OR PREPARING ANY SHOP DRAWINGS.

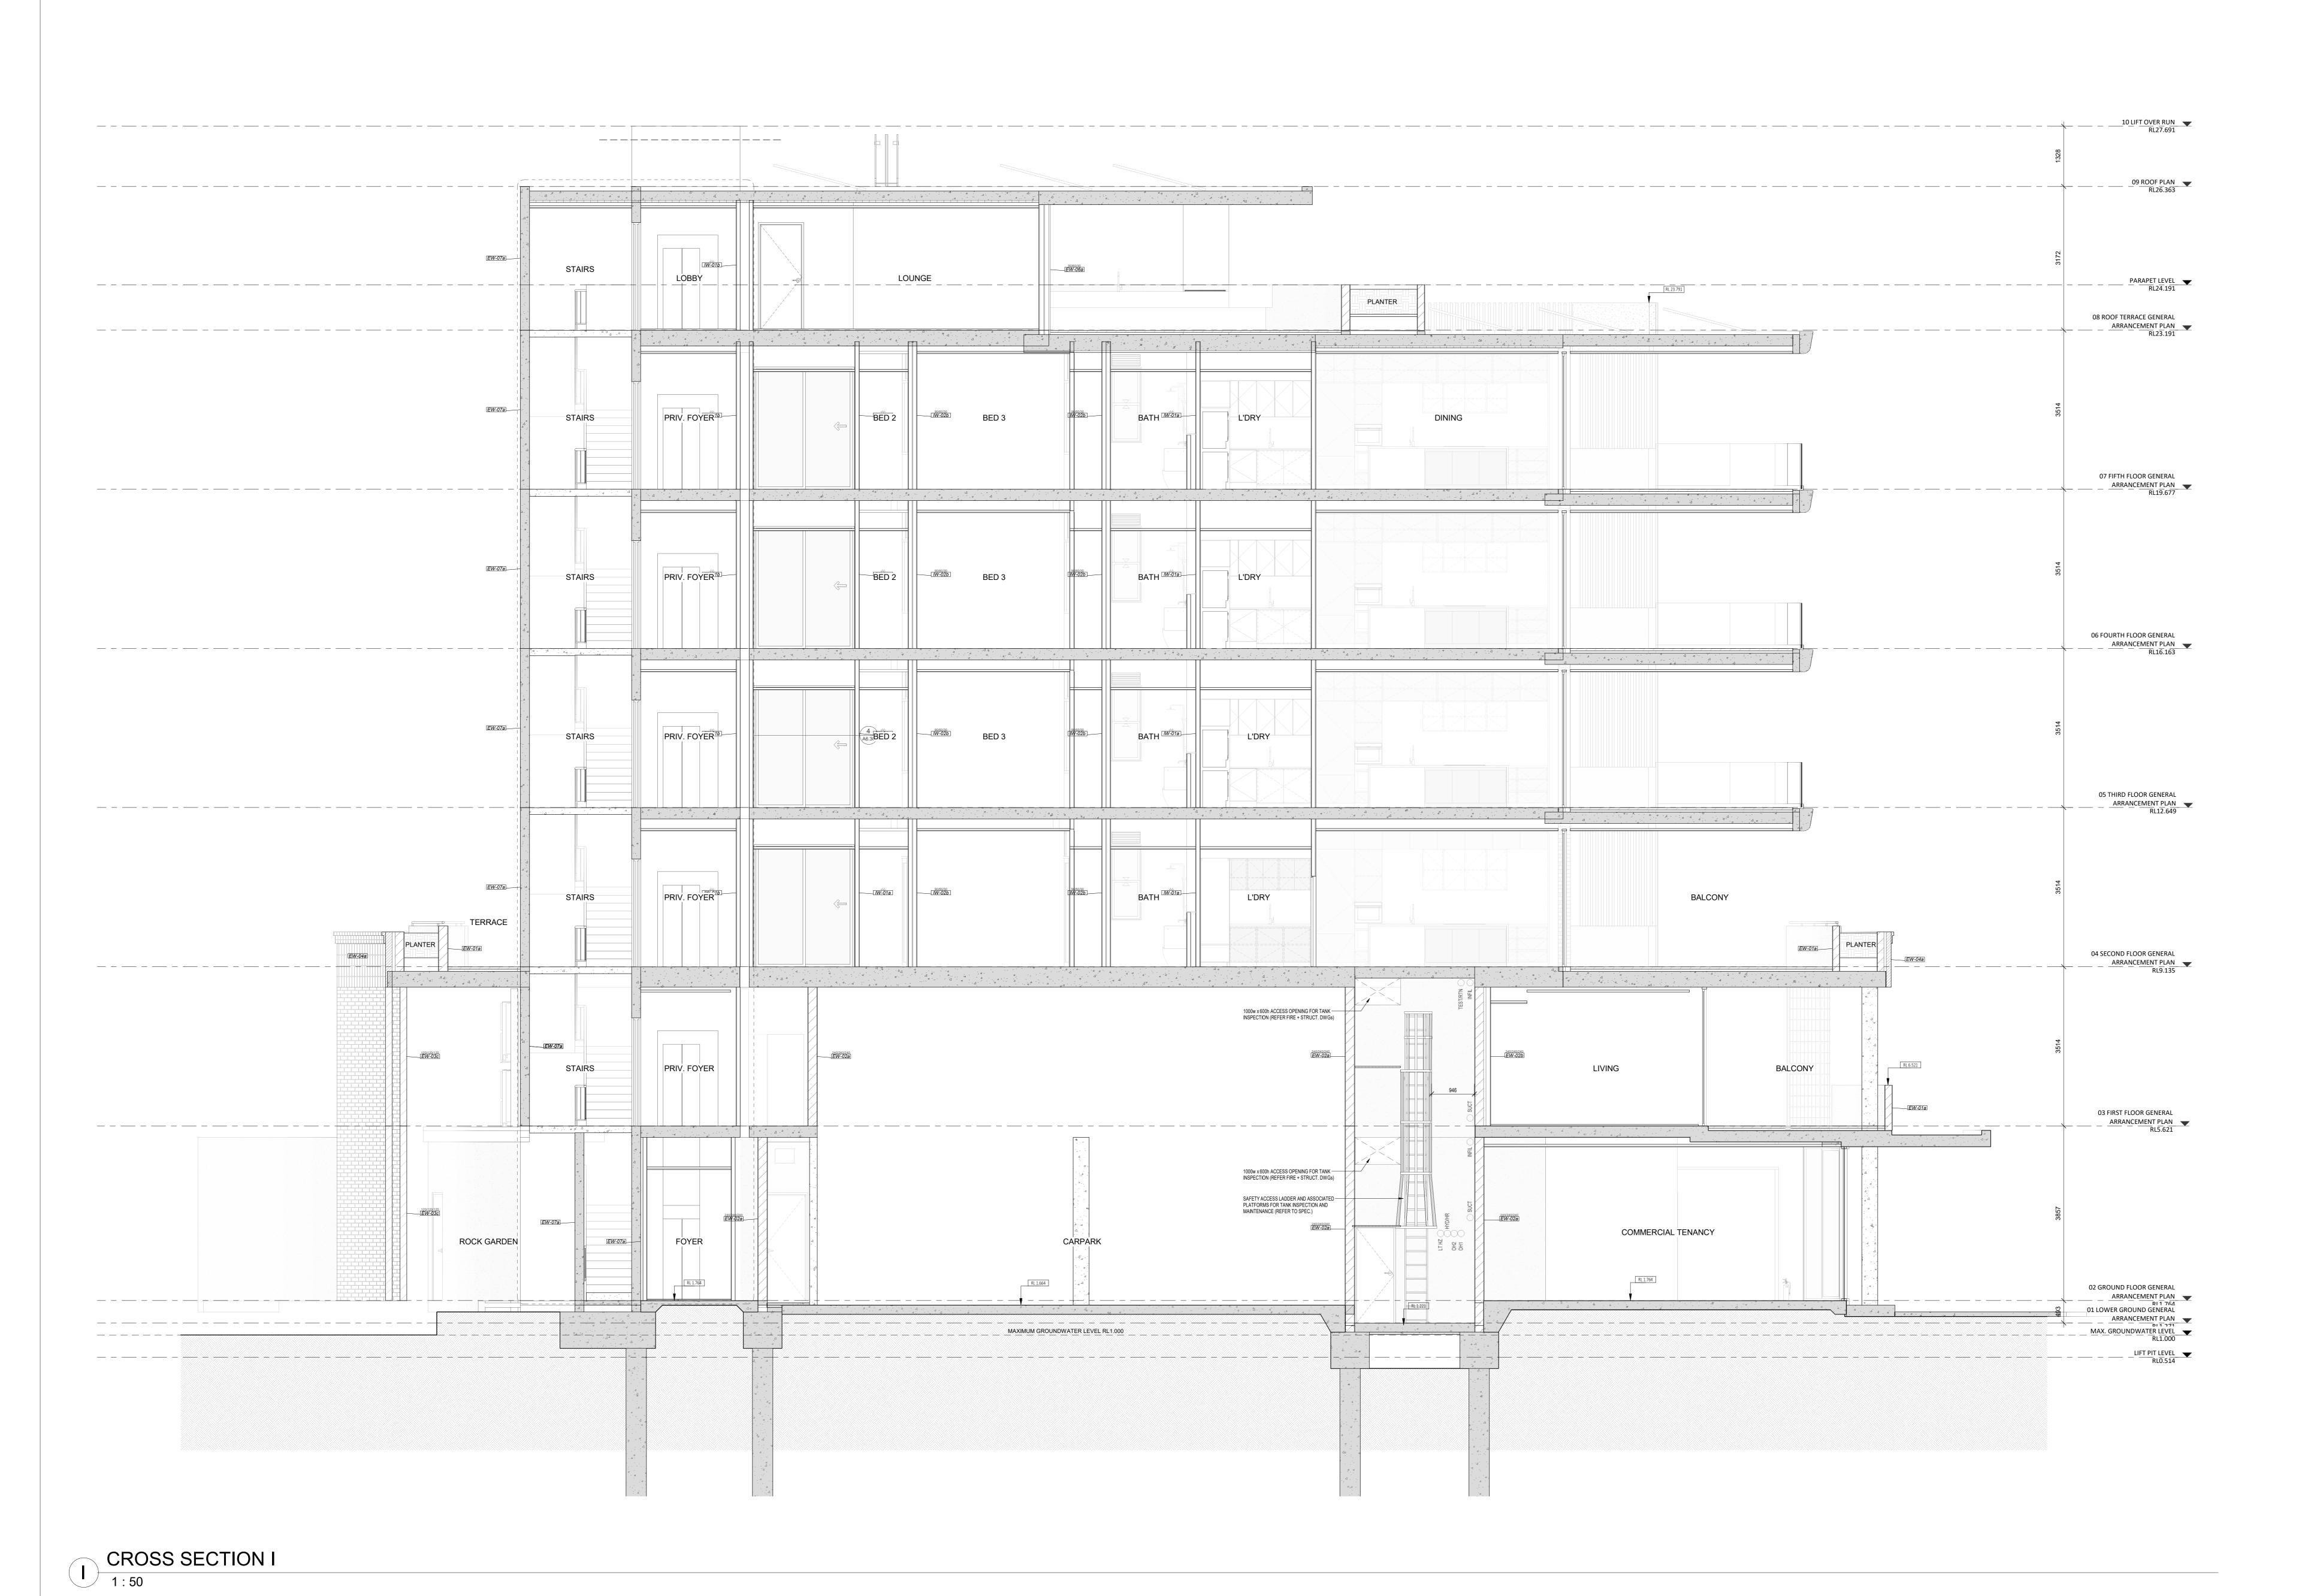APPLECROSS 6153 MANUALLY SCALED OFF DRAWINGS.
LARGE SCALE DWGS TAKE
PRECEDENCE OVER SMALLER SCALE IFC PROGRESS DOCUMENTATION

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GENERAL NOTES ALL DIMENSIONS ARE IN MILLIMETRES U.N.O. WRITTEN DIMENSIONS SHALL TAKE PRECEDENCE OVER SCALED DIMENSIONS.
CONTRACTOR SHALL CARRY OUT WORK IN CONFORMANCE WITH THE B.C.A./N.C.C. RELEVANT STANDARDS AND THE LOCAL AUTHORITY REQUIREMENTS.
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ALL WINDOW DIMENSIONS ARE NOMINAL AND ARE TO BE MEASURED ON SITE. MEASURED ON SITE.

THE CONTRACTOR SHALL VISIT THE SITE & NOTE ALL SITE
CONDITIONS & ACCESS REQUIREMENTS.
REFER TO WALL TYPES PLANS FOR WALL SETOUTS.
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BUILDING TAG XXXX

REFER MASTER MATERIALS SCHEDULE FOR THE FOLLOWING AND MORE:

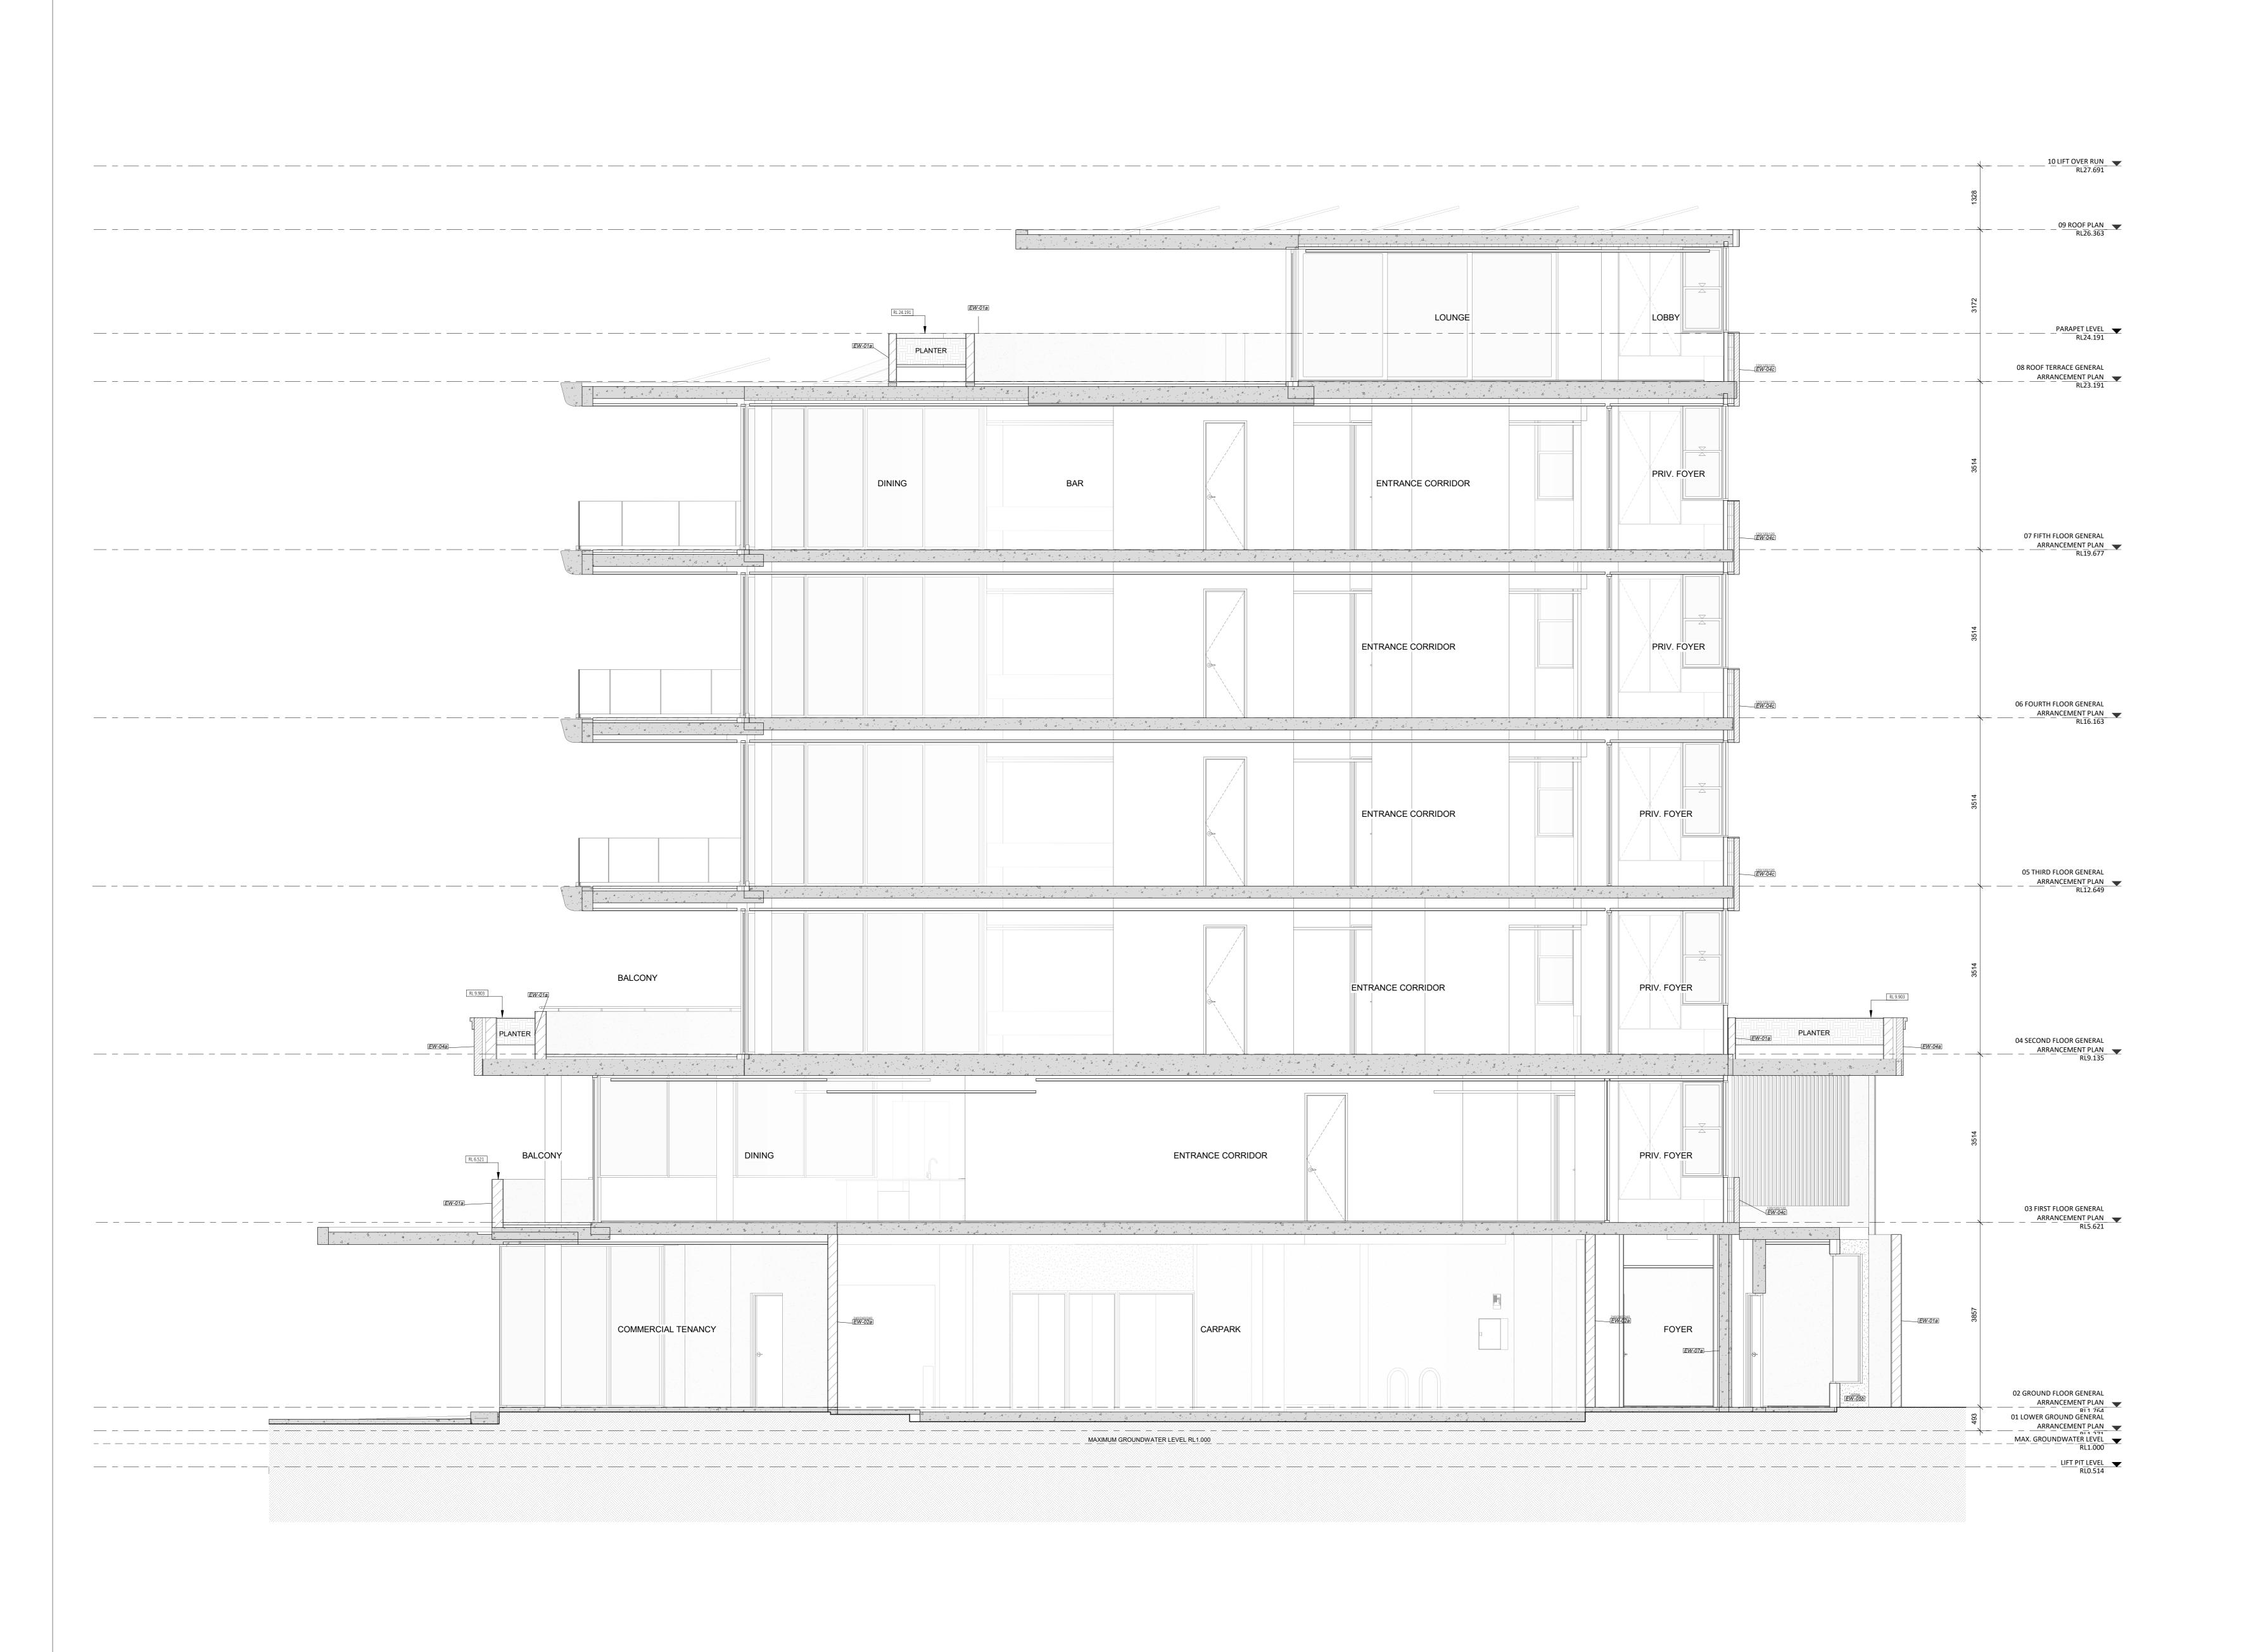16.1 STRUCTURE SURFACE FINISHES 16.4 FINISHES


16.2 FIXTURES & FITTINGS 16.5 APPLIANCES

16.3 WATERPROOFING SYSTEMS 16.6 TRIMS



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0			CONTRACTOR TO CHECK ALL DIMENSIONS AND LEVELS ON SITE BEFORE COMMENCING ANY WORK OR PREPARING ANY SHOP DRAWINGS. CAD FIGURE DIMENSIONS TAKE PRECEDENCE OVER MEASUREMENTS MANUALLY SCALED OFF DRAWINGS. LARGE SCALE DWGS TAKE
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LARGE SCALE DWGS TAKE
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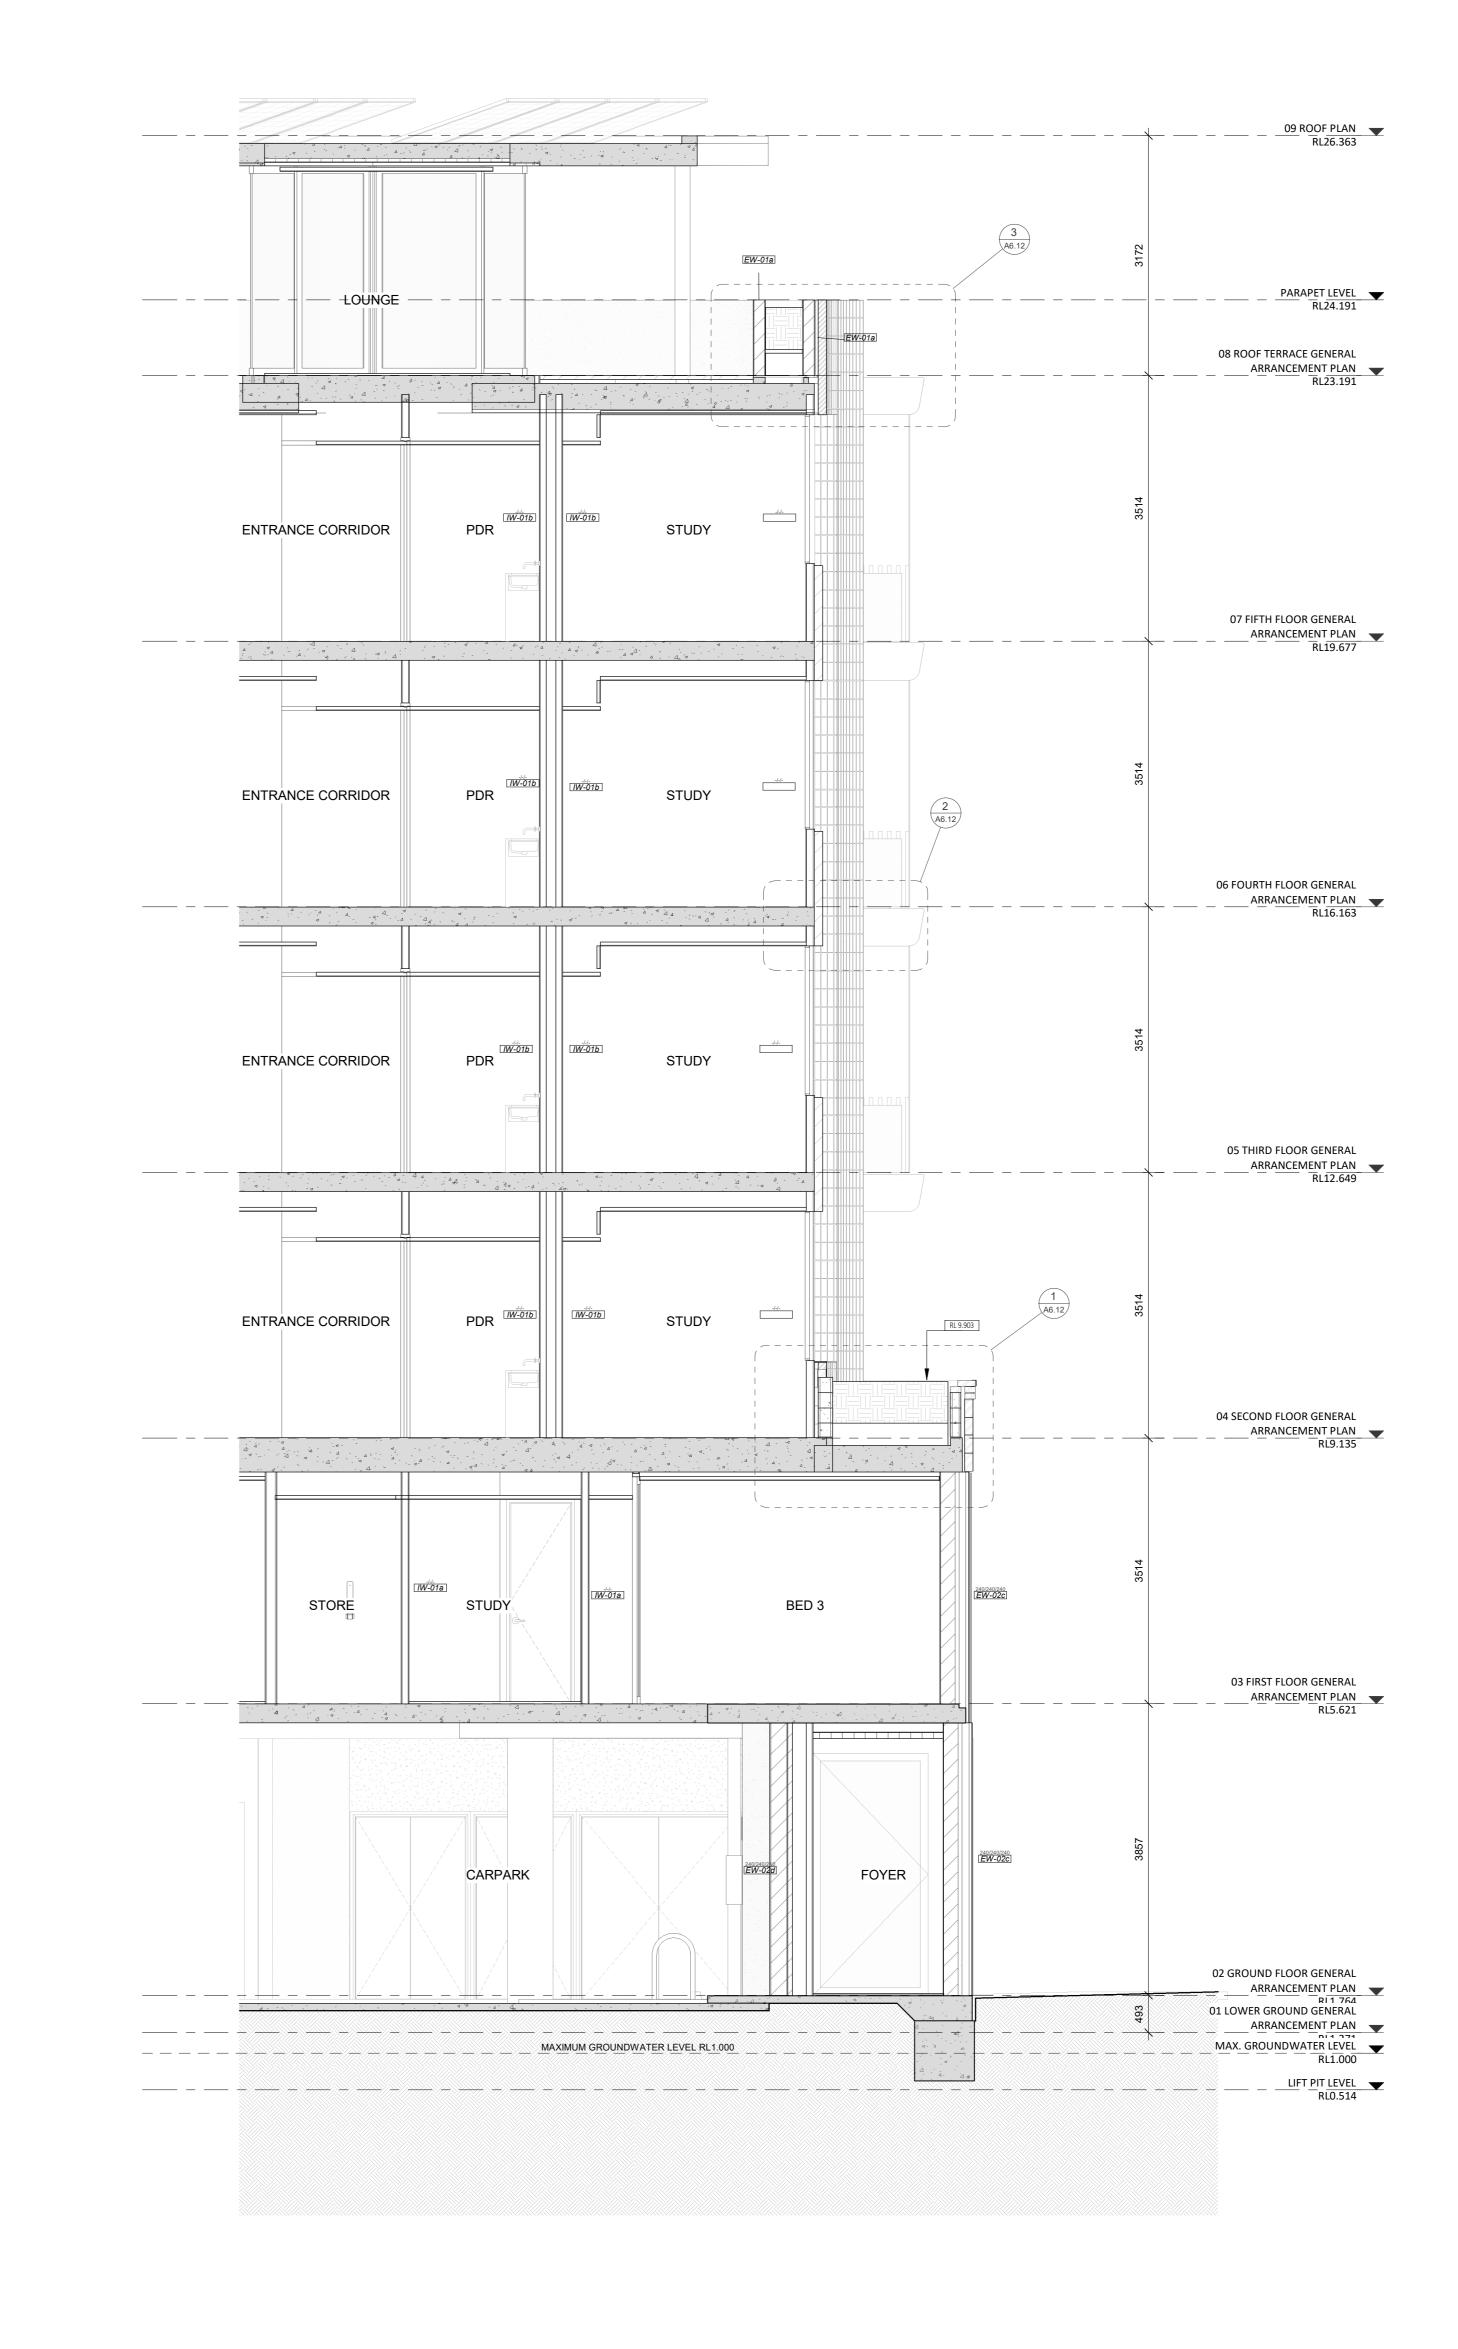
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16.3 WATERPROOFING SYSTEMS 16.6 TRIMS

REDUCTION

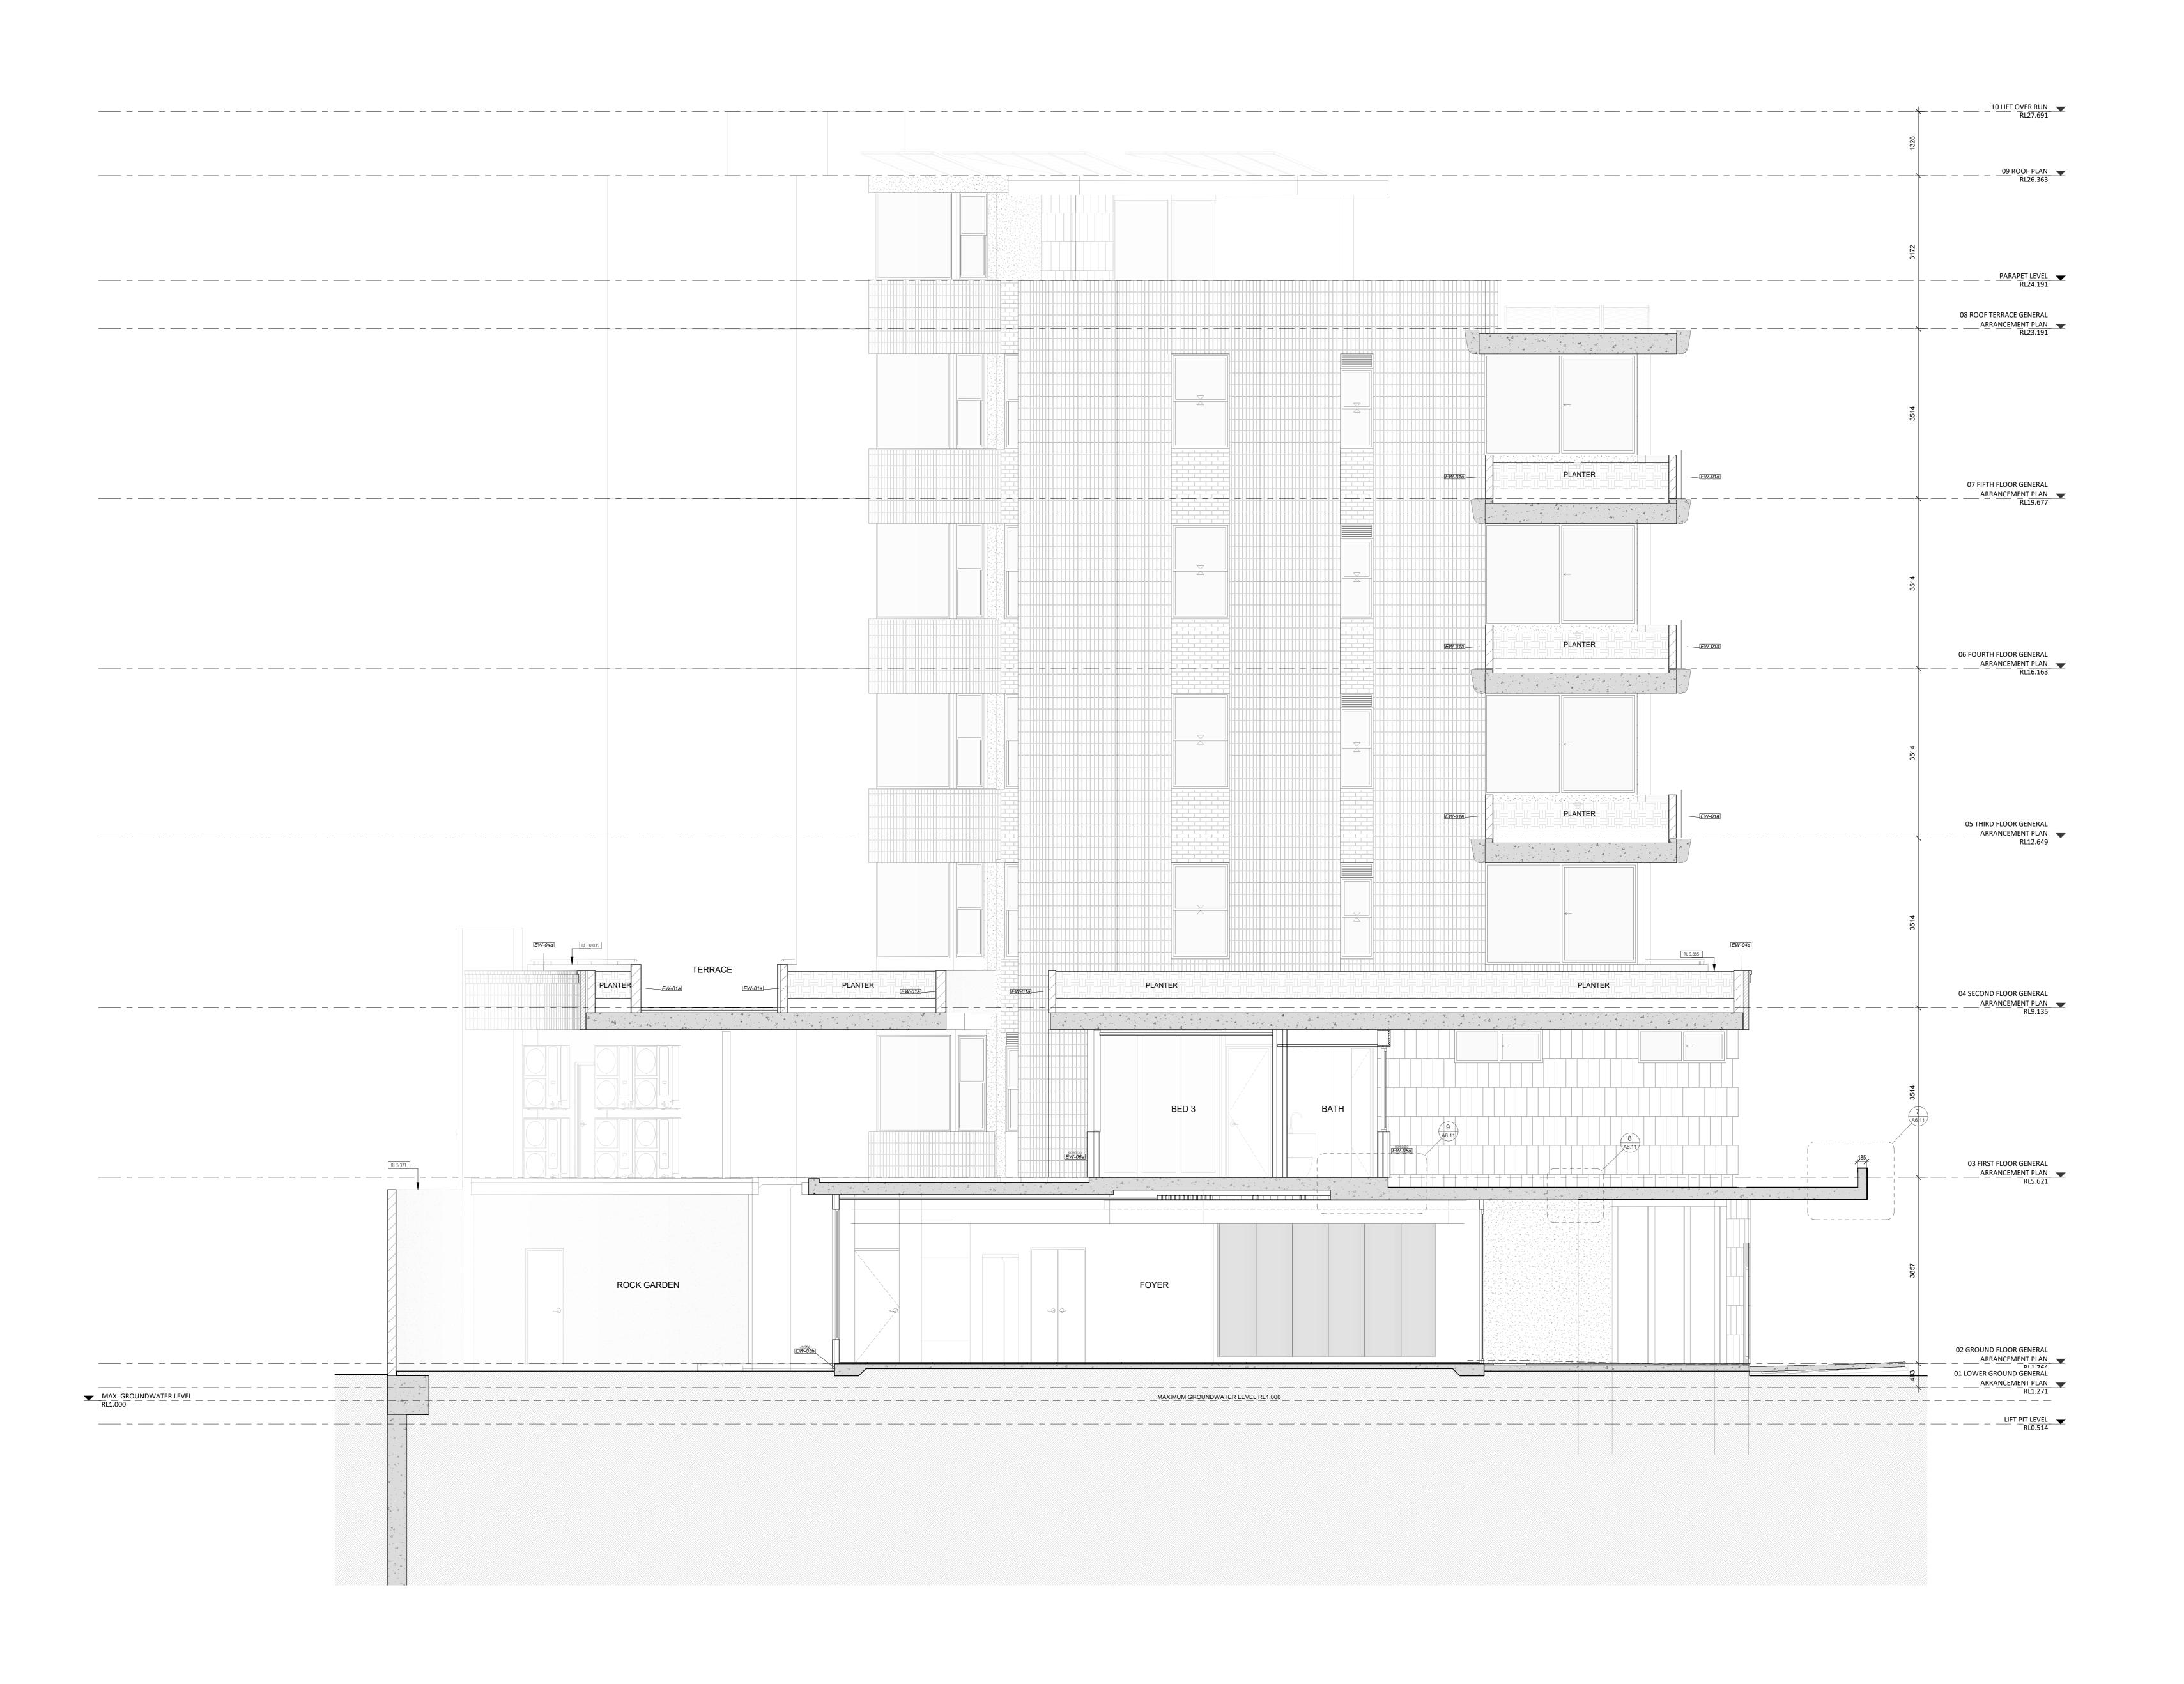

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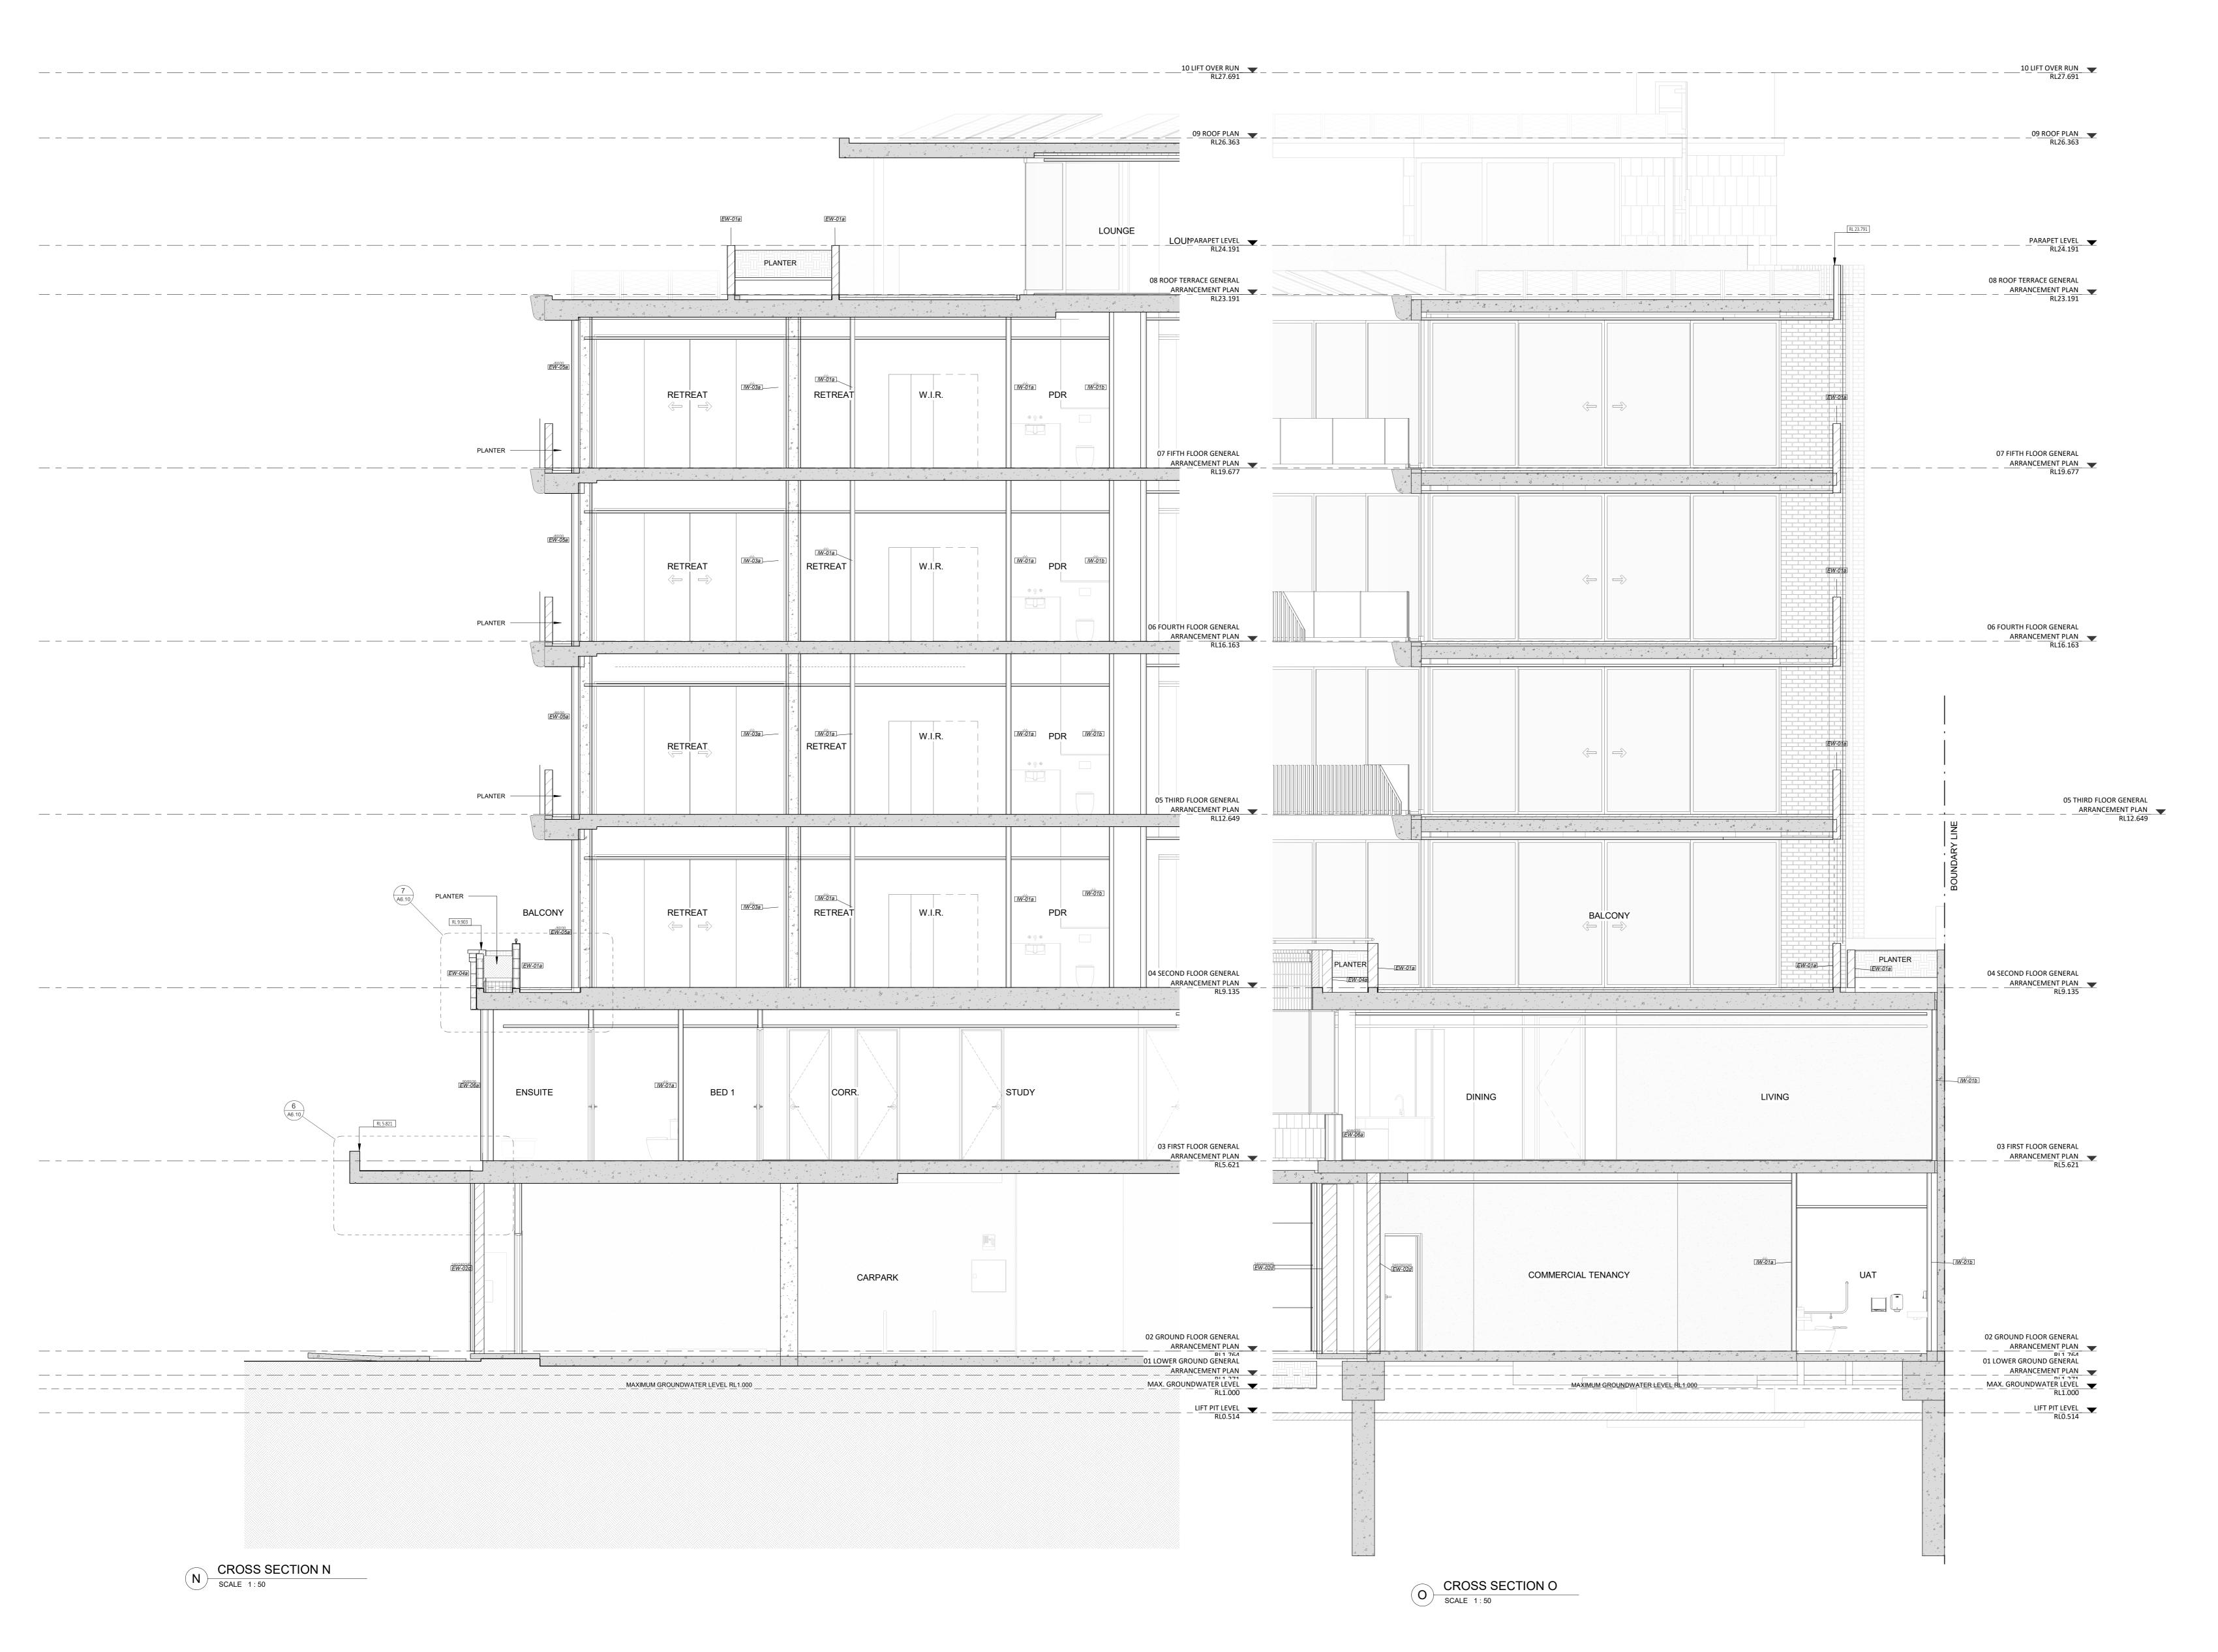
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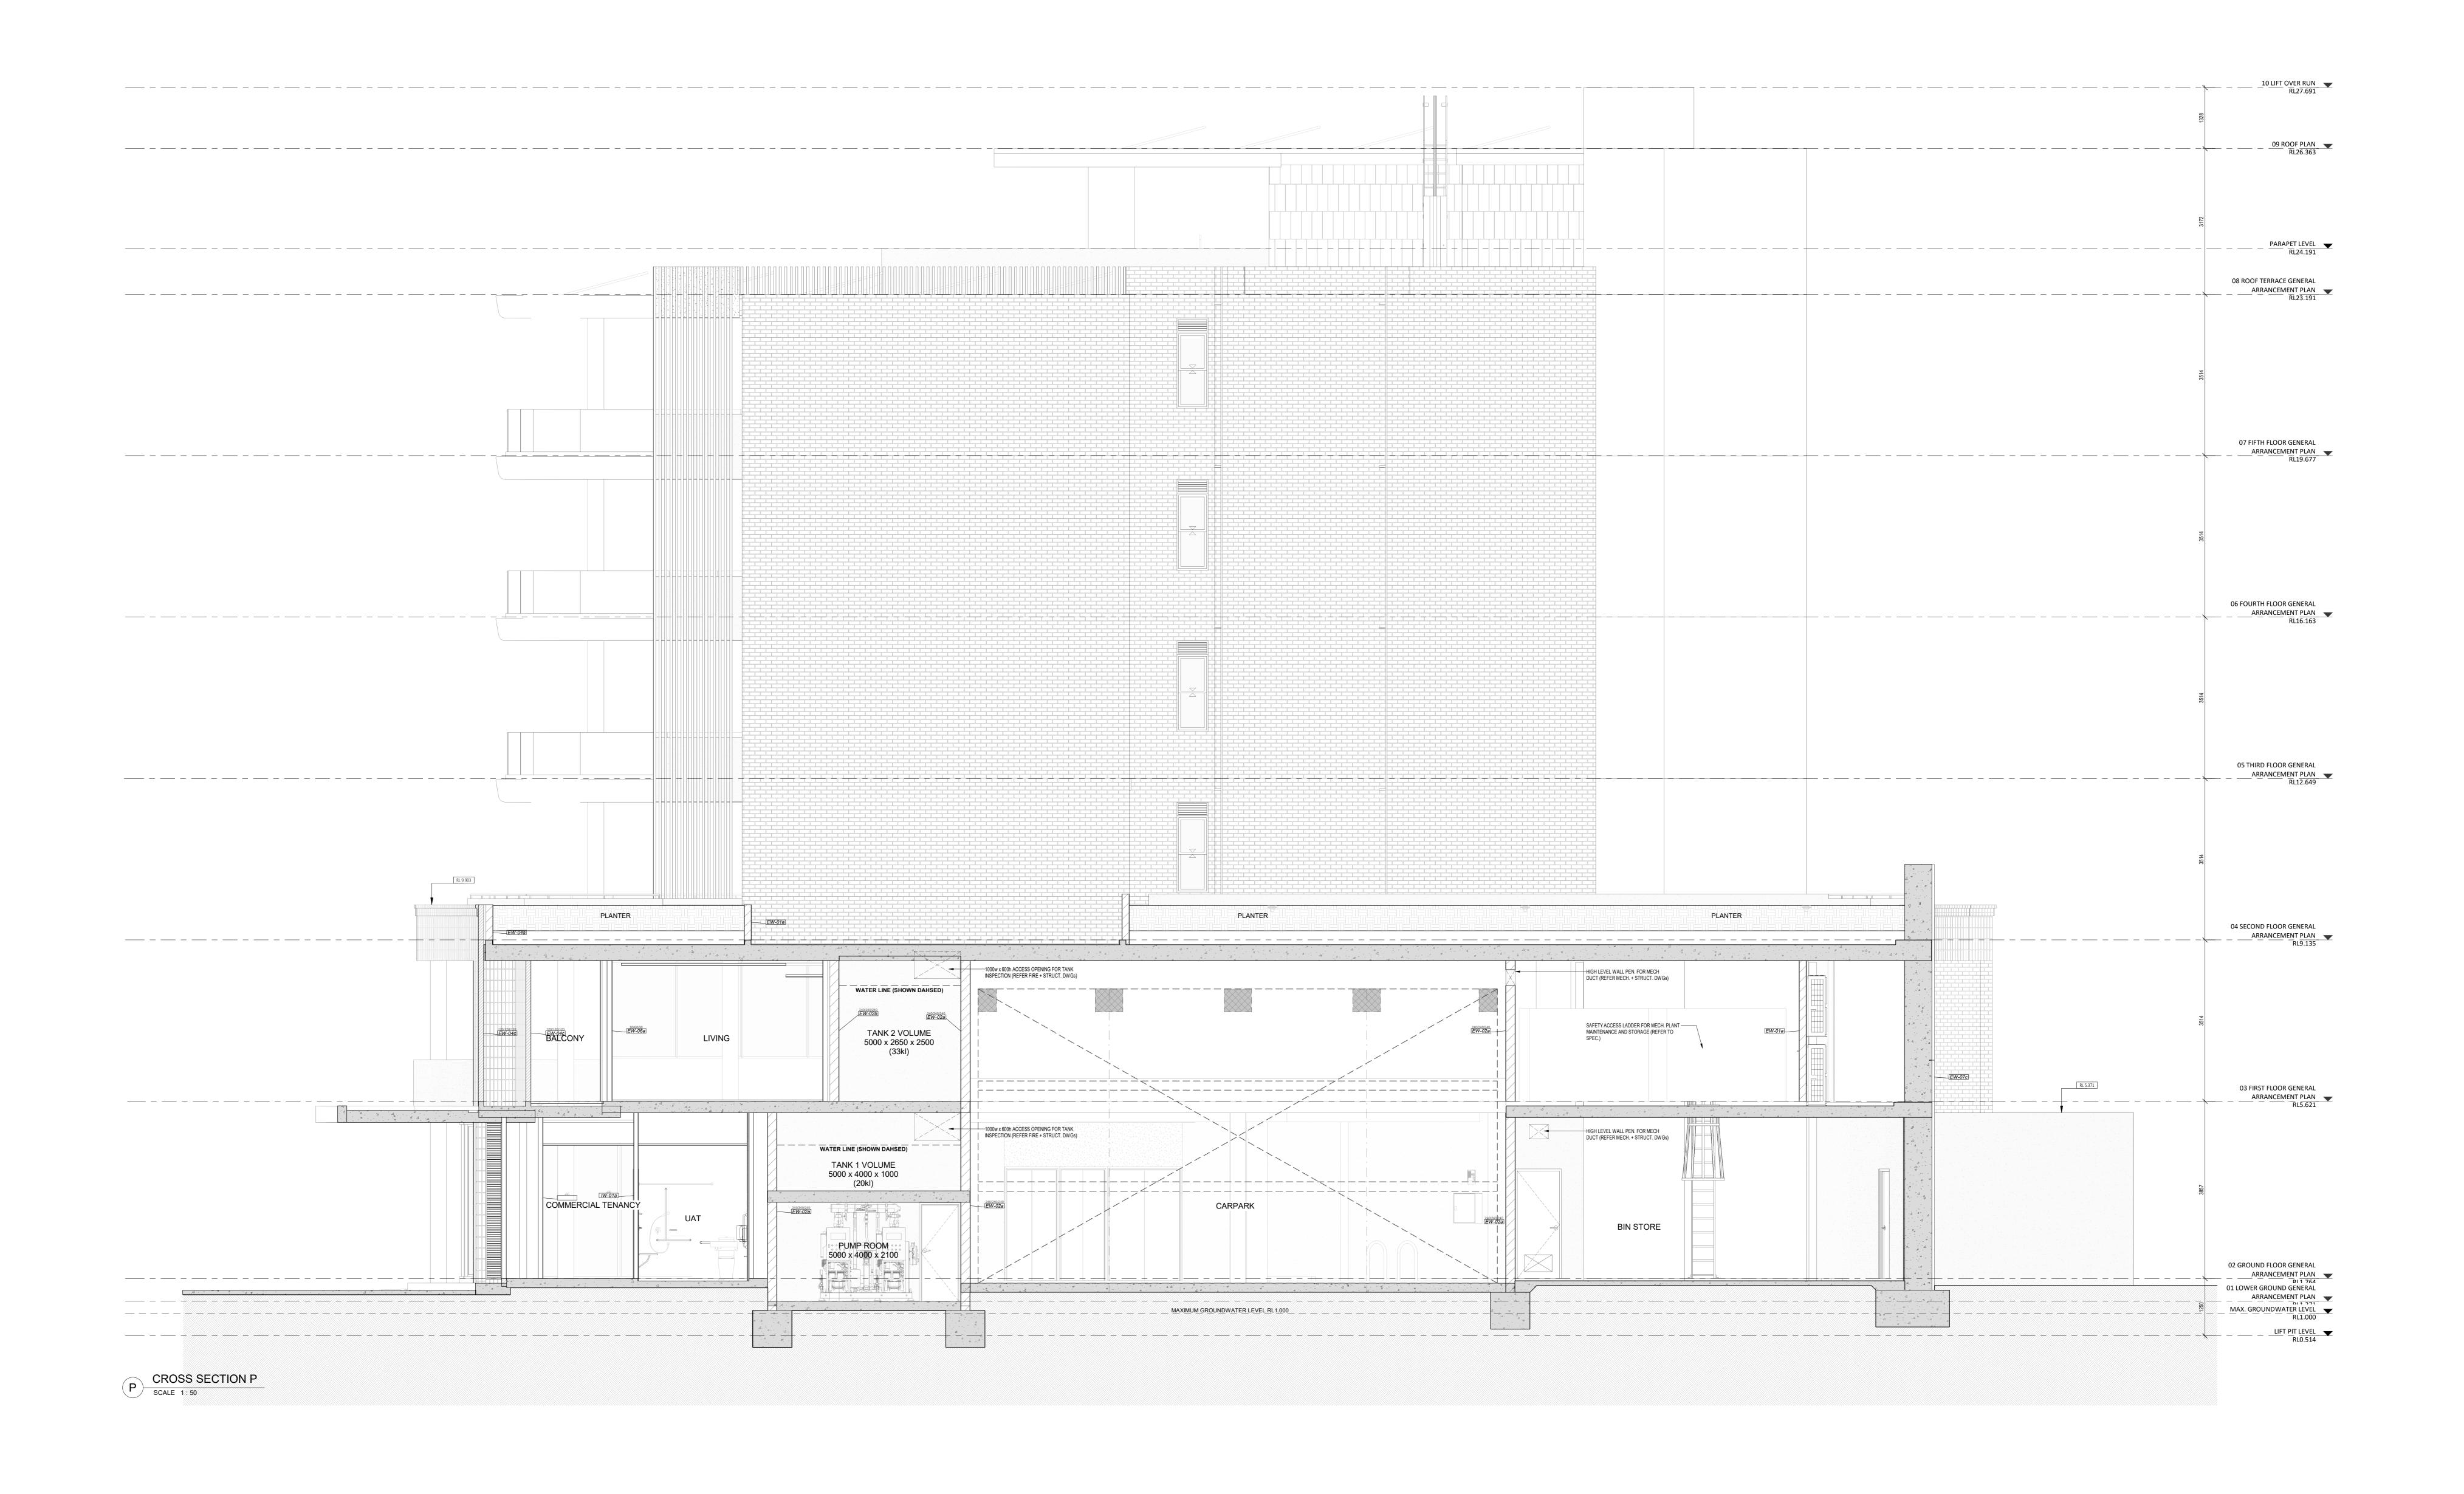
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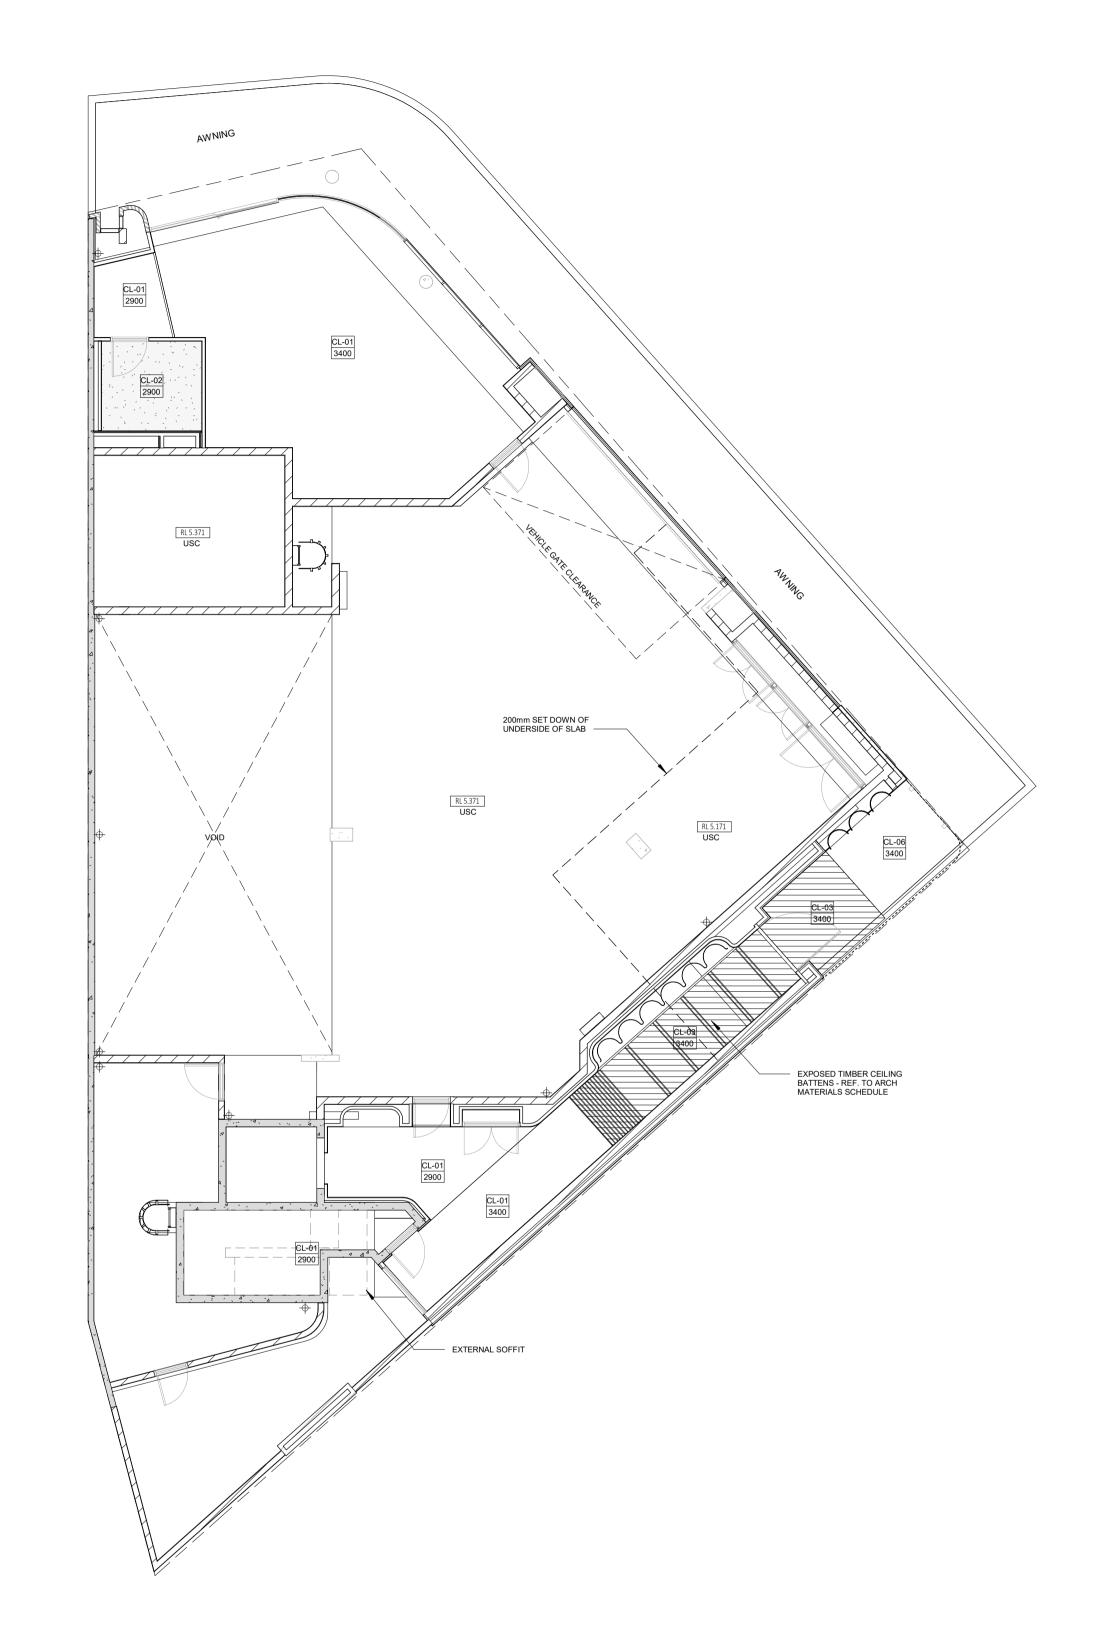
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APPLECROSS 6153 CAD FIGURE DIMENSIONS TAKE PRECEDENCE OVER MEASUREMENTS | Cross Section P MANUALLY SCALED OFF DRAWINGS. LARGE SCALE DWGS TAKE
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16.2 FIXTURES & FITTINGS 16.5 APPLIANCES
16.3 WATERPROOFING SYSTEMS 16.6 TRIMS **CEILING LEGEND** XXX CEILING MATERIAL TYPE / CORNICE TYPE. REFER SCHEDULE FINISHES HEIGHT ABOVE RESPECTIVE INTERNAL STRUCTURAL FLOOR LEVEL FLUSH JOINT PLASTERBOARD CEILING. PAINTED FINISH. CL-01-FLUSH JOINT MOISTURE RESISTANT PLASTERBOARD CEILING. PAINTED FINISH. CL-03 6MM FIBRE CEMENT FLUSH JOINT SOFFIT. REFER MATERIAL TAG FOR FINISH UNDERSIDE OF SUSPENDED CONCRETE FLOOR SLAB. REFER MATERIAL TAG FOR FINISH CONCEALED SOFFIT BOARD INSULATION TO UNDERSIDE OF SLAB ABOVE. CONCEAL IN CEILING VOID. REFER SCHEDULE FOR PRODUCT. EXPOSED SOFFIT BOARD INSULATION TO UNDERSIDE OF SLAB ABOVE. E.A. TRIMS TO PERIMETER. REFER SCHEDULE FOR PRODUCT ROOF INSULATION BLANKET WITH THERMAL SPACER AND REFLECTIVE FOILS. REFER SCHEDULE FOR PRODUCT. NOTE: REFER SCHEDULE FOR DETAILED CEILING / INSULATION INFORMATION. **CEILING NOTES** NOMINATED CEILING HEIGHTS ARE TAKEN FROM RESPECTIVE FLOOR PLAN SFL, U.N.O. ALL INTERNAL PLASTERBOARD CEILINGS AND BULKHEADS FLUSHED AND PAINTED, U.N.O. REFER INTERIOR SCHEDULE FOR COLOUR. ALL EXTERNAL SOFFIT LININGS FLUSHED AND PAINTED, LUMINAIRE SELECTIONS MAY REQUIRE CANISTERS FOR RECESSING INTO CONCRETE SOFFIT, BUILDER TO ALLOW. PLASTERBOARD CEILINGS WITHIN WET AREAS AND EXTERNAL ARE TO BE MOISTURE RESISTANT. WHERE THERE IS A DROP CEILING TO A HIGH CEILING, CORNICE TO THE HIGH CEILING ONLY, SQUARE-SET CORNICE FOR DROP CEILING. (ie KITCHENS, ROBES WITH SLIDING DOORS & LAUNDRY CUPBOARDS CORNICES TO FULL CEILING PERIMETER INCLUDING WHERE CEILING MEETS BULKHEAD/DROPPED CEILINGS, EXCEPTIONS AS BELOW:
 WHERE CABINET TOPS FINISH AT CEILING
 LEVEL, STOP CORNICE AT CABINET TOP
 TRIMS/SCRIBER (DO NOT CONTINUE IN FRONT
 OF TOP TRIMS).

WHERE THERE IS A BLIND RECESS. REFER TO SERVICE CONSULTANT DRAWINGS FOR FULL EXTENT OF ELECTRICAL AND MECHANICAL SERVICES

POWER, DATE AND COMMS DRY FIRE SERVICE EQUIPMENT

MECHANICAL SERVICES
CEILING ACCESS PANELS FOR SERVICES
WITHIN CEILING SPACE

INCLUDING;
• LIGHTING LAYOUT

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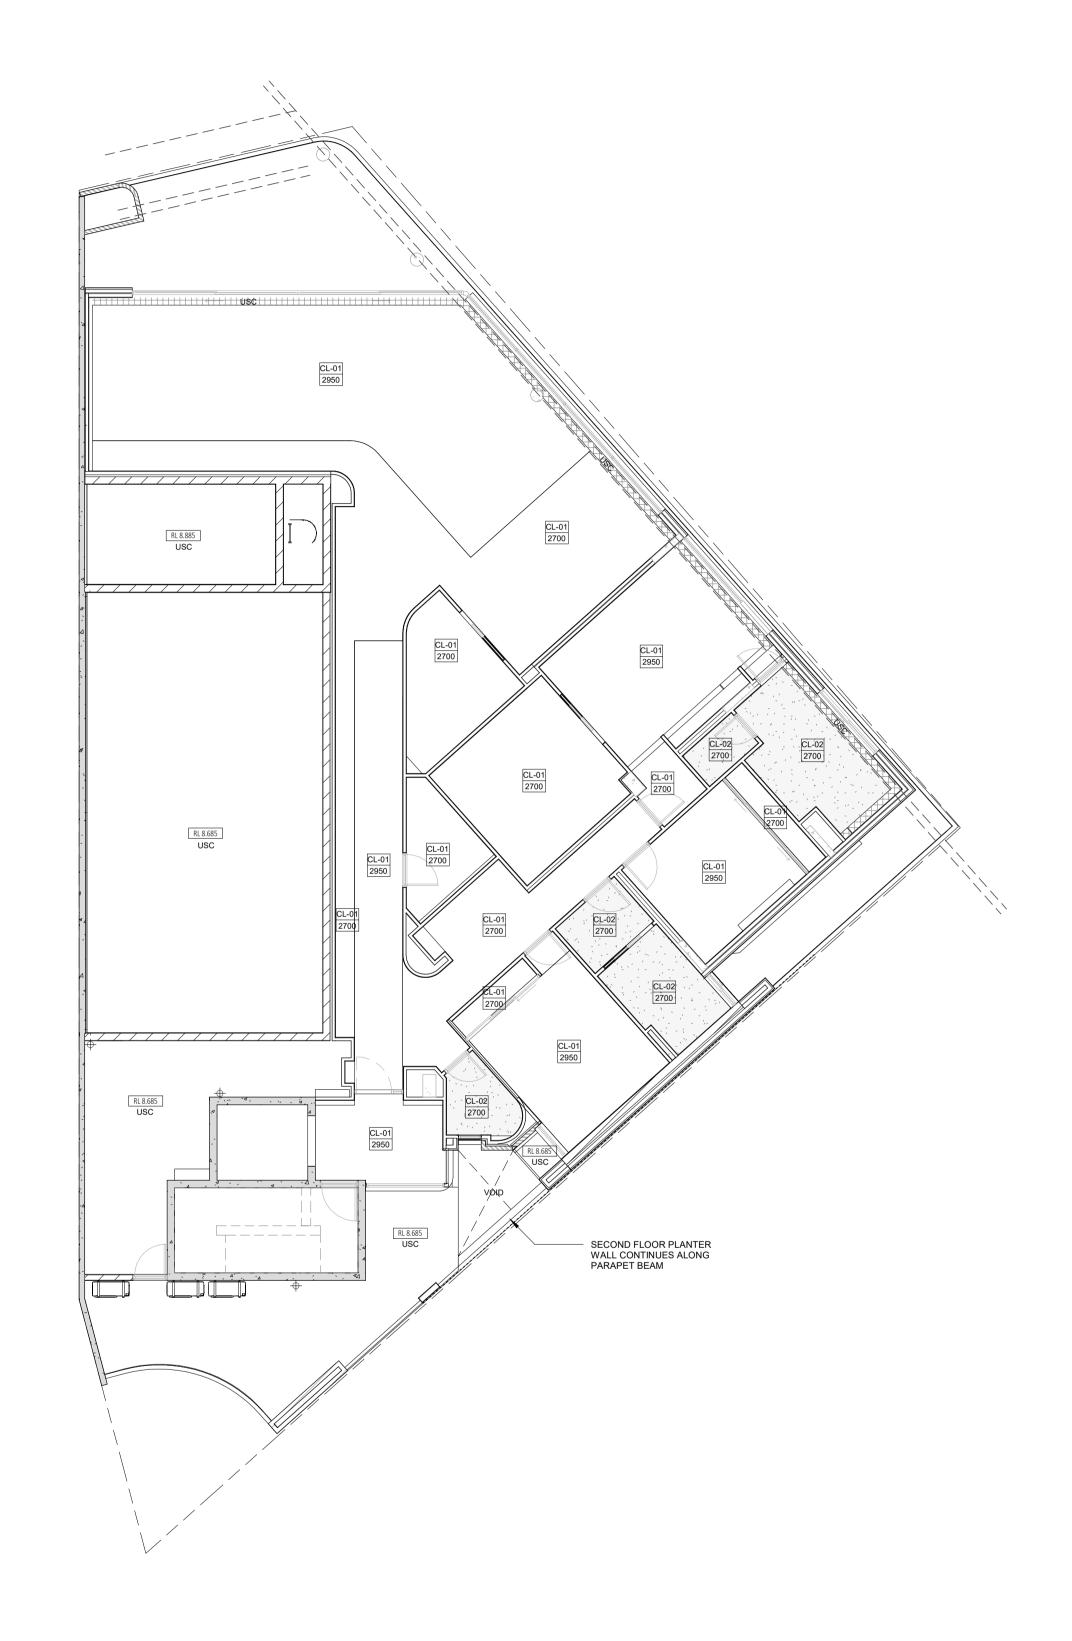
GRIFFIN GROUP a: 204 Walcott Street, Menora WA 6050. p: (08) 9221 1144 e: info@griffin-group.com.au

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CANNING BEACH ROAD BEFORE COMMENCING ANY WORK OR LOT 1 65a+b CANNING BEACH ROAD APPLECROSS 6153 PRECEDENCE OVER MEASUREMENTS | Ground Floor Ceiling Plan

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GENERAL NOTES ALL DIMENSIONS ARE IN MILLIMETRES U.N.O. WRITTEN DIMENSIONS SHALL TAKE PRECEDENCE OVER SCALED DIMENSIONS. CONTRACTOR SHALL CARRY OUT WORK IN CONFORMANCE WITH THE B.C.A./N.C.C. RELEVANT STANDARDS AND THE LOCAL AUTHORITY REQUIREMENTS. THE MAIN CONTRACTOR IS TO ENSURE THIS DRAWING IS READ IN CONJUNCTION WITH ALL RELEVANT ARCHITECTURAL, STRUCTURAL AND SERVICE CONSULTANT DOCUMENTATION TO ENSURE FULL CO-ORDINATION BETWEEN TRADES PRIOR TO WORK COMMENCEMENT. LARGE SCALE DRAWINGS SHALL TAKE PRECEDENCE OVER SMALLER SCALE DRAWINGS. CONTRACTOR SHALL CARRY OUT WORK IN CONFORMANCE WITH THE B.C.A./N.C.C. RELEVANT STANDARDS AND THE LOCAL AUTHORITY REQUIREMENTS. SEEK CLARIFICATION FROM SUPERINTENDENT FOR ANY DISCREPANCIES.
ALL EXTERNAL FLOOR SURFACES TO FALL AWAY FROM REFER INTERIOR DOCUMENTATION FOR SETOUTS AND EXACT LOCATIONS OF CABINETRY, FITTINGS, FIXTURES, PLUMBING, FLOOR WASTES AND TILING. ALL MATERIALS SHALL BE NEW & COMFORM TO WHAT IS SHOWN ON THE DRAWINGS AND IN THE SCHEDULES. THE CONTRACTOR SHALL CHECK & VERIFY ALL DIMENSIONS ON SITE, PRIOR TO THE COMMENCEMENT OF ANY BUILDING WORK. ALL WINDOW DIMENSIONS ARE NOMINAL AND ARE TO BE MEASURED ON SITE.
THE CONTRACTOR SHALL VISIT THE SITE & NOTE ALL SITE CONDITIONS & ACCESS REQUIREMENTS. REFER TO WALL TYPES PLANS FOR WALL SETOUTS.
REFER SLAB SETOUT PLANS FOR SLAB AND STRUCTURAL COLUMN SETOUTS.
ENSURE ALL STRUCTURAL STEEL COLUMNS WITHIN 3m OF SITE BOUNDARY TO BE FIRE PROTECTED TO CODES AND STANDARDS.
INSTALL FLASHINGS, EDGE TRIMS AND APPROPRIATE SEASL AS
REQUIRED TO ACHIEVE WEATHER TIGHTNESS. FINISH TO BE

CL-01	13mm PLASTERBOARD, WITH P50 SHADOW LINE CORNICE
CL-02	13mm MR PLASTERBOARD, WITH P50 SHADOW LINE CORNICE - MOISTURE RESISTANT
CL-03	EXPOSED TIMBER CEILING BATTENS
CL-04	40mm SLAB INSULATION
CL-05	6mm FIBRE CEMENT SHEET SOFFIT W/ FLUSH JOIN
CL-06	6mm FIBRE CEMENT SHEET SOFFIT W/ FLUSH JOIN

REFER MASTER MATERIALS SCHEDULE FOR THE FOLLOWING AND MORE:
16.1 STRUCTURE SURFACE FINISHES 16.4 FINISHES
16.2 FIXTURES & FITTINGS 16.5 APPLIANCES
16.3 WATERPROOFING SYSTEMS 16.6 TRIMS

SAME AS ADJACENT MATERIAL U.N.O.

BUILDING TAG XX-XX

CEILING LEGEND XXX CEILING MATERIAL TYPE / CORNICE TYPE. REFER SCHEDULE XXX — FINISHES HEIGHT ABOVE RESPECTIVE INTERNAL STRUCTURAL FLOOR LEVEL FLUSH JOINT PLASTERBOARD CEILING. PAINTED FINISH. FLUSH JOINT MOISTURE RESISTANT PLASTERBOARD CEILING. PAINTED FINISH. CL-03 6MM FIBRE CEMENT FLUSH JOINT SOFFIT. REFER MATERIAL TAG FOR FINISH UNDERSIDE OF SUSPENDED CONCRETE FLOOR SLAB. REFER MATERIAL TAG FOR FINISH CONCEALED SOFFIT BOARD INSULATION TO UNDERSIDE OF SLAB ABOVE. CONCEAL IN CEILING VOID. REFER SCHEDULE FOR PRODUCT. EXPOSED SOFFIT BOARD INSULATION TO UNDERSIDE OF SLAB ABOVE. E.A. TRIMS TO PERIMETER. REFER SCHEDULE FOR PRODUCT ROOF INSULATION BLANKET WITH THERMAL SPACER AND REFLECTIVE FOILS. REFER SCHEDULE FOR PRODUCT. NOTE: REFER SCHEDULE FOR DETAILED CEILING / INSULATION INFORMATION. **CEILING NOTES** NOMINATED CEILING HEIGHTS ARE TAKEN FROM RESPECTIVE FLOOR PLAN SFL, U.N.O. ALL INTERNAL PLASTERBOARD CEILINGS AND BULKHEADS FLUSHED AND PAINTED, U.N.O. REFER INTERIOR SCHEDULE FOR COLOUR. ALL EXTERNAL SOFFIT LININGS FLUSHED AND PAINTED, LUMINAIRE SELECTIONS MAY REQUIRE CANISTERS FOR RECESSING INTO CONCRETE SOFFIT, BUILDER TO PLASTERBOARD CEILINGS WITHIN WET AREAS AND EXTERNAL ARE TO BE MOISTURE RESISTANT.

WHERE CABINET TOPS FINISH AT CEILING LEVEL, STOP CORNICE AT CABINET TOP TRIMS/SCRIBER (DO NOT CONTINUE IN FRONT OF TOP TRIMS).
WHERE THERE IS A BLIND RECESS.

SLIDING DOORS & LAUNDRY CUPBOARDS)

WHERE THERE IS A DROP CEILING TO A HIGH CEILING, CORNICE TO THE HIGH CEILING ONLY, SQUARE-SET CORNICE FOR DROP CEILING. (ie KITCHENS, ROBES WITH

CORNICES TO FULL CEILING PERIMETER INCLUDING WHERE CEILING MEETS BULKHEAD/DROPPED CEILINGS, EXCEPTIONS AS BELOW:

REFER TO SERVICE CONSULTANT DRAWINGS FOR FULL EXTENT OF ELECTRICAL AND MECHANICAL SERVICES

LIGHTING LAYOUT
POWER, DATE AND COMMS
DRY FIRE SERVICE EQUIPMENT
MECHANICAL SERVICES
CEILING ACCESS PANELS FOR SERVICES

WITHIN CEILING SPACE WET AREA EXHAUST

Architecture + Landscape

CARRIER AND POSTMUS ARCHITECTS - Architecture + Landscape a: no. 5 northwood street west leederville western australia 6007 p: (08) 9380 9020

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GRIFFIN

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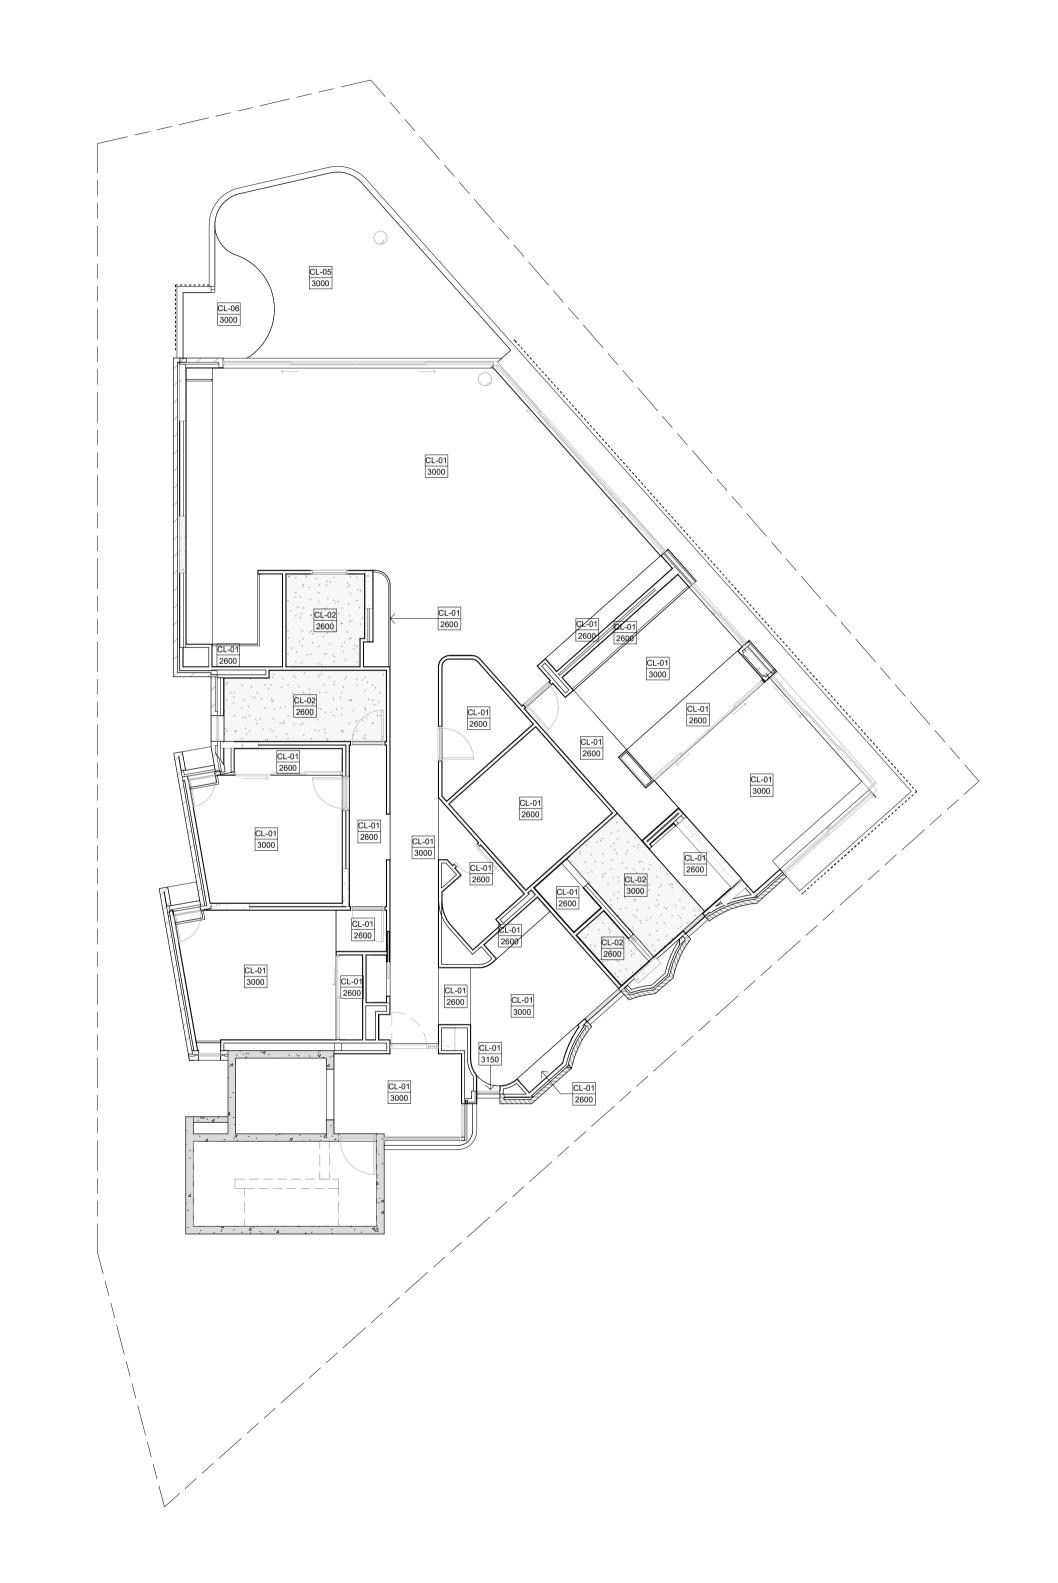
p: (08) 9221 1144

e: info@griffin-group.com.au

•					CONTRACTOR TO CHECK ALL DIMENSIONS AND LEVELS ON SITE
					BEFORE COMMENCING ANY WORK OR
					PREPARING ANY SHOP DRAWINGS.
					CAD FIGURE DIMENSIONS TAKE PRECEDENCE OVER MEASUREMENTS
					MANUALLY SCALED OFF DRAWINGS.
					LARGE SCALE DWGS TAKE
	DATE Y.M.D	REV	RECIPIENT / REASON FOR ISSUE	BY	PRECEDENCE OVER SMALLER SCALE DWGS.

CANNING BEACH ROAD FORE COMMENCING ANY WORK OR LOT 1 65a+b CANNING BEACH ROAD REPARING ANY SHOP DRAWINGS. APPLECROSS 6153 RECEDENCE OVER MEASUREMENTS | First Floor Ceiling Plan

JC THIS IS A CAD DRAWING DO NOT AMEND MANUALLY CM DESIGNED CHECKED PRINCIPAL REDUCTION DATE JUSTIN CARRIER CLIENT PROJECT CAPA PROJECT No. GRF19 No. DRAWING No. 2027 No. A5.02 SCALE IFC PROGRESS DOCUMENTATION



GENERAL NOTES ALL DIMENSIONS ARE IN MILLIMETRES U.N.O. WRITTEN DIMENSIONS SHALL TAKE PRECEDENCE OVER SCALED DIMENSIONS. CONTRACTOR SHALL CARRY OUT WORK IN CONFORMANCE WITH THE B.C.A./N.C.C. RELEVANT STANDARDS AND THE LOCAL AUTHORITY REQUIREMENTS. THE MAIN CONTRACTOR IS TO ENSURE THIS DRAWING IS READ IN CONJUNCTION WITH ALL RELEVANT ARCHITECTURAL, STRUCTURAL AND SERVICE CONSULTANT DOCUMENTATION TO ENSURE FULL CO-ORDINATION BETWEEN TRADES PRIOR TO WORK COMMENCEMENT. LARGE SCALE DRAWINGS SHALL TAKE PRECEDENCE OVER SMALLER SCALE DRAWINGS. CONTRACTOR SHALL CARRY OUT WORK IN CONFORMANCE WITH THE B.C.A./N.C.C. RELEVANT STANDARDS AND THE LOCAL AUTHORITY REQUIREMENTS. SEEK CLARIFICATION FROM SUPERINTENDENT FOR ANY DISCREPANCIES.
ALL EXTERNAL FLOOR SURFACES TO FALL AWAY FROM BUILDING. REFER INTERIOR DOCUMENTATION FOR SETOUTS AND EXACT LOCATIONS OF CABINETRY, FITTINGS, FIXTURES, PLUMBING, FLOOR WASTES AND TILING. ALL MATERIALS SHALL BE NEW & COMFORM TO WHAT IS SHOWN ON THE DRAWINGS AND IN THE SCHEDULES. THE CONTRACTOR SHALL CHECK & VERIFY ALL DIMENSIONS ON SITE, PRIOR TO THE COMMENCEMENT OF ANY BUILDING WORK. ALL WINDOW DIMENSIONS ARE NOMINAL AND ARE TO BE MEASURED ON SITE.
THE CONTRACTOR SHALL VISIT THE SITE & NOTE ALL SITE

CONDITIONS & ACCESS REQUIREMENTS.

SAME AS ADJACENT MATERIAL U.N.O.
BUILDING TAG XX-XX

REFER TO WALL TYPES PLANS FOR WALL SETOUTS.
REFER SLAB SETOUT PLANS FOR SLAB AND STRUCTURAL

REFER SLAB SETOUT PLANS FUR SLAD AND STRUCTURE.
COLUMN SETOUTS.
ENSURE ALL STRUCTURAL STEEL COLUMNS WITHIN 3m OF SITE
BOUNDARY TO BE FIRE PROTECTED TO CODES AND STANDARDS.
INSTALL FLASHINGS, EDGE TRIMS AND APPROPRIATE SEASL AS
REQUIRED TO ACHIEVE WEATHER TIGHTNESS. FINISH TO BE

CL-01	13mm PLASTERBOARD, WITH P50 SHADOW LINE CORNICE
CL-02	13mm MR PLASTERBOARD, WITH P50 SHADOW LINE CORNICE - MOISTURE RESISTANT
CL-03	EXPOSED TIMBER CEILING BATTENS
CL-04	40mm SLAB INSULATION
CL-05	6mm FIBRE CEMENT SHEET SOFFIT W/ FLUSH JOINT
CL-06	6mm FIBRE CEMENT SHEET SOFFIT W/ FLUSH JOINT

REFER MASTER MATERIALS SCHEDULE FOR THE FOLLOWING AND MORE:
16.1 STRUCTURE SURFACE FINISHES 16.4 FINISHES
16.2 FIXTURES & FITTINGS 16.5 APPLIANCES
16.3 WATERPROOFING SYSTEMS 16.6 TRIMS

CEILING LEGEND XXX CEILING MATERIAL TYPE / CORNICE TYPE. REFER SCHEDULE XXX FINISHES HEIGHT ABOVE RESPECTIVE INTERNAL STRUCTURAL FLOOR LEVEL FLUSH JOINT PLASTERBOARD CEILING. PAINTED FINISH. FLUSH JOINT MOISTURE RESISTANT PLASTERBOARD CEILING. PAINTED FINISH. CL-03 6MM FIBRE CEMENT FLUSH JOINT SOFFIT. REFER MATERIAL TAG FOR FINISH UNDERSIDE OF SUSPENDED CONCRETE FLOOR SLAB. REFER MATERIAL TAG FOR FINISH CONCEALED SOFFIT BOARD INSULATION TO UNDERSIDE OF SLAB ABOVE. CONCEAL IN CEILING VOID. REFER SCHEDULE FOR PRODUCT. EXPOSED SOFFIT BOARD INSULATION TO UNDERSIDE OF SLAB ABOVE. E.A. TRIMS TO PERIMETER. REFER SCHEDULE FOR PRODUCT ROOF INSULATION BLANKET WITH THERMAL SPACER AND REFLECTIVE FOILS. REFER SCHEDULE FOR PRODUCT.

CEILING NOTES NOMINATED CEILING HEIGHTS ARE TAKEN FROM RESPECTIVE FLOOR PLAN SFL, U.N.O.

NOTE: REFER SCHEDULE FOR DETAILED CEILING / INSULATION INFORMATION.

ALL INTERNAL PLASTERBOARD CEILINGS AND BULKHEADS FLUSHED AND PAINTED, U.N.O. REFER ALL EXTERNAL SOFFIT LININGS FLUSHED AND PAINTED,

LUMINAIRE SELECTIONS MAY REQUIRE CANISTERS FOR RECESSING INTO CONCRETE SOFFIT, BUILDER TO

PLASTERBOARD CEILINGS WITHIN WET AREAS AND EXTERNAL ARE TO BE MOISTURE RESISTANT. WHERE THERE IS A DROP CEILING TO A HIGH CEILING,

CORNICE TO THE HIGH CEILING ONLY, SQUARE-SET CORNICE FOR DROP CEILING. (IE KITCHENS, ROBES WITH SLIDING DOORS & LAUNDRY CUPBOARDS)

CORNICES TO FULL CEILING PERIMETER INCLUDING WHERE CEILING MEETS BULKHEAD/DROPPED CEILINGS, EXCEPTIONS AS BELOW:

WHERE CABINET TOPS FINISH AT CEILING LEVEL, STOP CORNICE AT CABINET TOP TRIMS/SCRIBER (DO NOT CONTINUE IN FRONT OF TOP TRIMS). WHERE THERE IS A BLIND RECESS.

REFER TO SERVICE CONSULTANT DRAWINGS FOR FULL EXTENT OF ELECTRICAL AND MECHANICAL SERVICES INCLUDING;

LIGHTING LAYOUT POWER, DATE AND COMMS
DRY FIRE SERVICE EQUIPMENT MECHANICAL SERVICES
CEILING ACCESS PANELS FOR SERVICES
WITHIN CEILING SPACE
WET AREA EXHAUST

Architecture + Landscape

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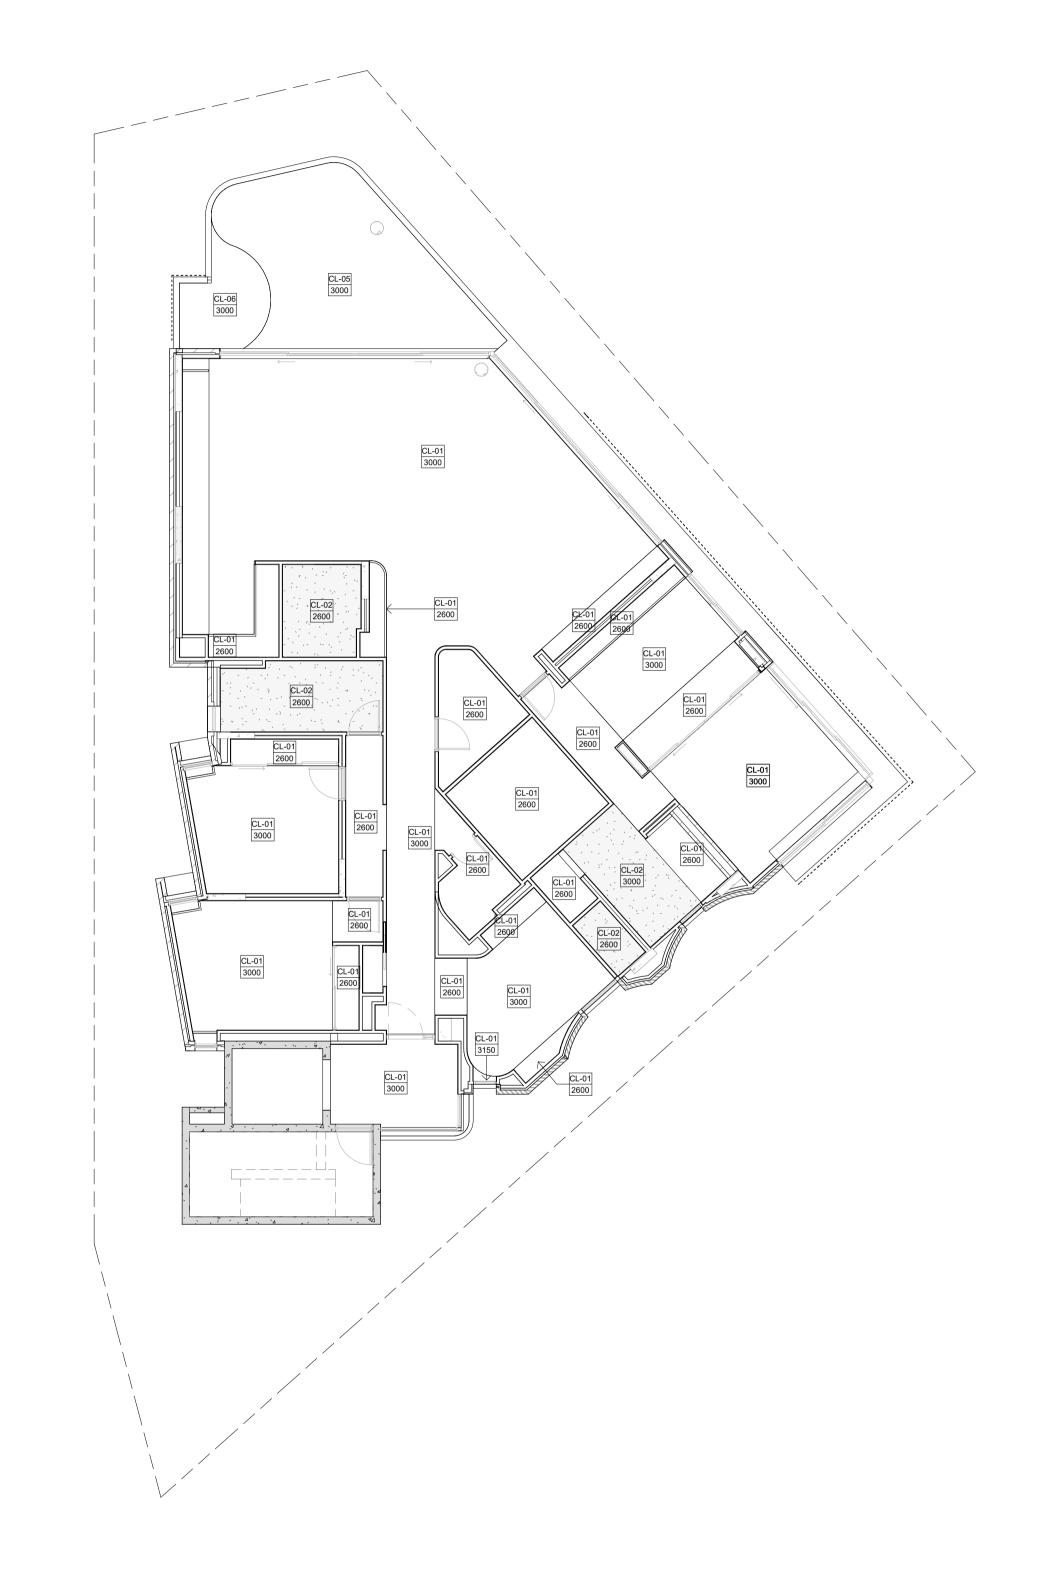


GF	RIFFIN GROUP
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p:	(08) 9221 1144
e:	info@griffin-group.com.au

DIMENSIONS AND LEVELS ON BEFORE COMMENCING ANY W PREPARING ANY SHOP DRAW	
	SITE
PREPARING ANY SHOP DRAW	/ORK O
THE THURST STOLE BLOW	INGS.
CAD FIGURE DIMENSIONS TAR	Œ
PRECEDENCE OVER MEASUR	EMENTS
MANUALLY SCALED OFF DRAV	VINGS.
LARGE SCALE DWGS TAKE	
DATE REV RECIPIENT / REASON FOR ISSUE BY DWGS.	R SCALE
Y.M.D REV RECIPIENT / REASON FOR 1850E	

CANNING BEACH ROAD
LOT 1 65a+b CANNING BEACH ROAD APPLECROSS 6153
Second Floor Ceiling Plan

JC THIS IS A CAD DRAWING DO NOT AMEND MANUALLY CM DESIGNED CHECKED PRINCIPAL REDUCTION JUSTIN CARRIER CLIENT PROJECT CAPA PROJECT No. GRF19 No. 2 DRAWING No. 2027 A5.03 SCALE IFC PROGRESS DOCUMENTATION



GENERAL NOTES ALL DIMENSIONS ARE IN MILLIMETRES U.N.O. WRITTEN DIMENSIONS SHALL TAKE PRECEDENCE OVER SCALED DIMENSIONS.
CONTRACTOR SHALL CARRY OUT WORK IN CONFORMANCE WITH
THE B.C.A./N.C.C. RELEVANT STANDARDS AND THE LOCAL
AUTHORITY REQUIREMENTS.
THE MAIN CONTRACTOR IS TO ENSURE THIS DRAWING IS READ IN
CONJUNCTION WITH ALL RELEVANT ARCHITECTURAL,
STRUCTURAL AND SERVICE CONSULTANT DOCUMENTATION TO
ENSURE FULL CO-ORDINATION BETWEEN TRADES PRIOR TO
WORK COMMENCEMENT.
LARGE SCALE DRAWINGS SHALL TAKE PRECEDENCE OVER WORK COMMENCEMENT.

LARGE SCALE DRAWINGS SHALL TAKE PRECEDENCE OVER

SMALLER SCALE DRAWINGS. CONTRACTOR SHALL CARRY OUT

WORK IN CONFORMANCE WITH THE B.C.A./N.C.C. RELEVANT

STANDARDS AND THE LOCAL AUTHORITY REQUIREMENTS.

SEEK CLARIFICATION FROM SUPERINTENDENT FOR ANY SEEK CLARIFICATION FROM SUPERINTENDENT FOR ANY DISCREPANCIES.
ALL EXTERNAL FLOOR SURFACES TO FALL AWAY FROM BUILDING.
REFER INTERIOR DOCUMENTATION FOR SETOUTS AND EXACT LOCATIONS OF CABINETRY, FITTINGS, FIXTURES, PLUMBING, FLOOR WASTES AND TILING.
ALL MATERIALS SHALL BE NEW & COMFORM TO WHAT IS SHOWN ON THE DRAWINGS AND IN THE SCHEDULES.
THE CONTRACTOR SHALL CHECK & VERIFY ALL DIMENSIONS ON SITE, PRIOR TO THE COMMENCEMENT OF ANY BUILDING WORK. ALL WINDOW DIMENSIONS ARE NOMINAL AND ARE TO BE MEASURED ON SITE. MEASURED ON SITE.
THE CONTRACTOR SHALL VISIT THE SITE & NOTE ALL SITE CONDITIONS & ACCESS REQUIREMENTS.
REFER TO WALL TYPES PLANS FOR WALL SETOUTS.
REFER SLAB SETOUT PLANS FOR SLAB AND STRUCTURAL REFER SLAB SETOUT PLANS FUR SLAB AND STRUCTURAL COLUMN SETOUTS.
ENSURE ALL STRUCTURAL STEEL COLUMNS WITHIN 3m OF SITE BOUNDARY TO BE FIRE PROTECTED TO CODES AND STANDARDS. INSTALL FLASHINGS, EDGE TRIMS AND APPROPRIATE SEASL AS REQUIRED TO ACHIEVE WEATHER TIGHTNESS. FINISH TO BE SAME AS ADJACENT MATERIAL U.N.O.
BUILDING TAG REFER MASTER MATERIALS SCHEDULE FOR THE FOLLOWING AND MORE:
16.1 STRUCTURE SURFACE FINISHES 16.4 FINISHES
16.2 FIXTURES & FITTINGS 16.5 APPLIANCES
16.3 WATERPROOFING SYSTEMS 16.6 TRIMS

L - 01	13mm PLASTERBOARD, WITH P50 SHADOW LINE
L-02	CORNICE 13mm MR PLASTERBOARD, WITH P50 SHADOW LINE
-03	CORNICE - MOISTURE RESISTANT EXPOSED TIMBER CEILING BATTENS
04	40mm SLAB INSULATION
05	6mm FIBRE CEMENT SHEET SOFFIT W/ FLUSH JOINT
06	6mm FIBRE CEMENT SHEET SOFFIT W/ FLUSH JOINT
CEI	LING LEGEND
XXX	
ÇL-C	FLUSH JOINT PLASTERBOARD CEILING. PAINTED FINISH.
CLE	FLUSH JOINT MOISTURE RESISTANT PLASTERBOARD CEILING. PAINTED FINISH.
CL-0	6MM FIBRE CEMENT FLUSH JOINT SOFFIT. REFER MATERIAL TAG FOR FINISH
usc	UNDERSIDE OF SUSPENDED CONCRETE FLOOR SLAB. REFER MATERIAL TAG FOR FINISH
	CONCEALED SOFFIT BOARD INSULATION TO UNDERSIDE OF SLAB ABOVE. CONCEAL IN CEILING VOID. REFER SCHEDULE FOR PRODUCT.
	EXPOSED SOFFIT BOARD INSULATION TO UNDERSIDE OF SLAB ABOVE. E.A. TRIMS TO PERIMETER. REFER SCHEDULE FOR PRODUCT
	ROOF INSULATION BLANKET WITH THERMAL SPACER AND REFLECTIVE FOILS. REFER SCHEDULE FOR PRODUCT.
	E: REFER SCHEDULE FOR DETAILED CEILING / INSULATION INFORMATION. LING NOTES
1.	NOMINATED CEILING HEIGHTS ARE TAKEN FROM RESPECTIVE FLOOR PLAN SFL, U.N.O.
2.	ALL INTERNAL PLASTERBOARD CEILINGS AND BULKHEADS FLUSHED AND PAINTED, U.N.O. REFER INTERIOR SCHEDULE FOR COLOUR.
3.	ALL EXTERNAL SOFFIT LININGS FLUSHED AND PAINTED, U.N.O.
4.	LUMINAIRE SELECTIONS MAY REQUIRE CANISTERS FOR RECESSING INTO CONCRETE SOFFIT, BUILDER TO ALLOW.
5.	PLASTERBOARD CEILINGS WITHIN WET AREAS AND EXTERNAL ARE TO BE MOISTURE RESISTANT.
6.	WHERE THERE IS A DROP CEILING TO A HIGH CEILING, CORNICE TO THE HIGH CEILING ONLY, SQUARE-SET CORNICE FOR DROP CEILING. (ie KITCHENS, ROBES WITH SLIDING DOORS & LAUNDRY CUPBOARDS)
7.	CORNICES TO FULL CEILING PERIMETER INCLUDING WHERE CEILING MEETS BULKHEAD/DROPPED CEILINGS, EXCEPTIONS AS BELOW: WHERE CABINET TOPS FINISH AT CEILING LEVEL, STOP CORNICE AT CABINET TOP TRIMS/SCRIBER (DO NOT CONTINUE IN FRONT OF TOP TRIMS). WHERE THERE IS A BLIND RECESS.
8.	REFER TO SERVICE CONSULTANT DRAWINGS FOR FULL EXTENT OF ELECTRICAL AND MECHANICAL SERVICES INCLUDING; • LIGHTING LAYOUT • POWER, DATE AND COMMS • DRY FIRE SERVICE EQUIPMENT • MECHANICAL SERVICES • CEILING ACCESS PANELS FOR SERVICES WITHIN CEILING SPACE • WET AREA EXHAUST

Architecture + Landscape

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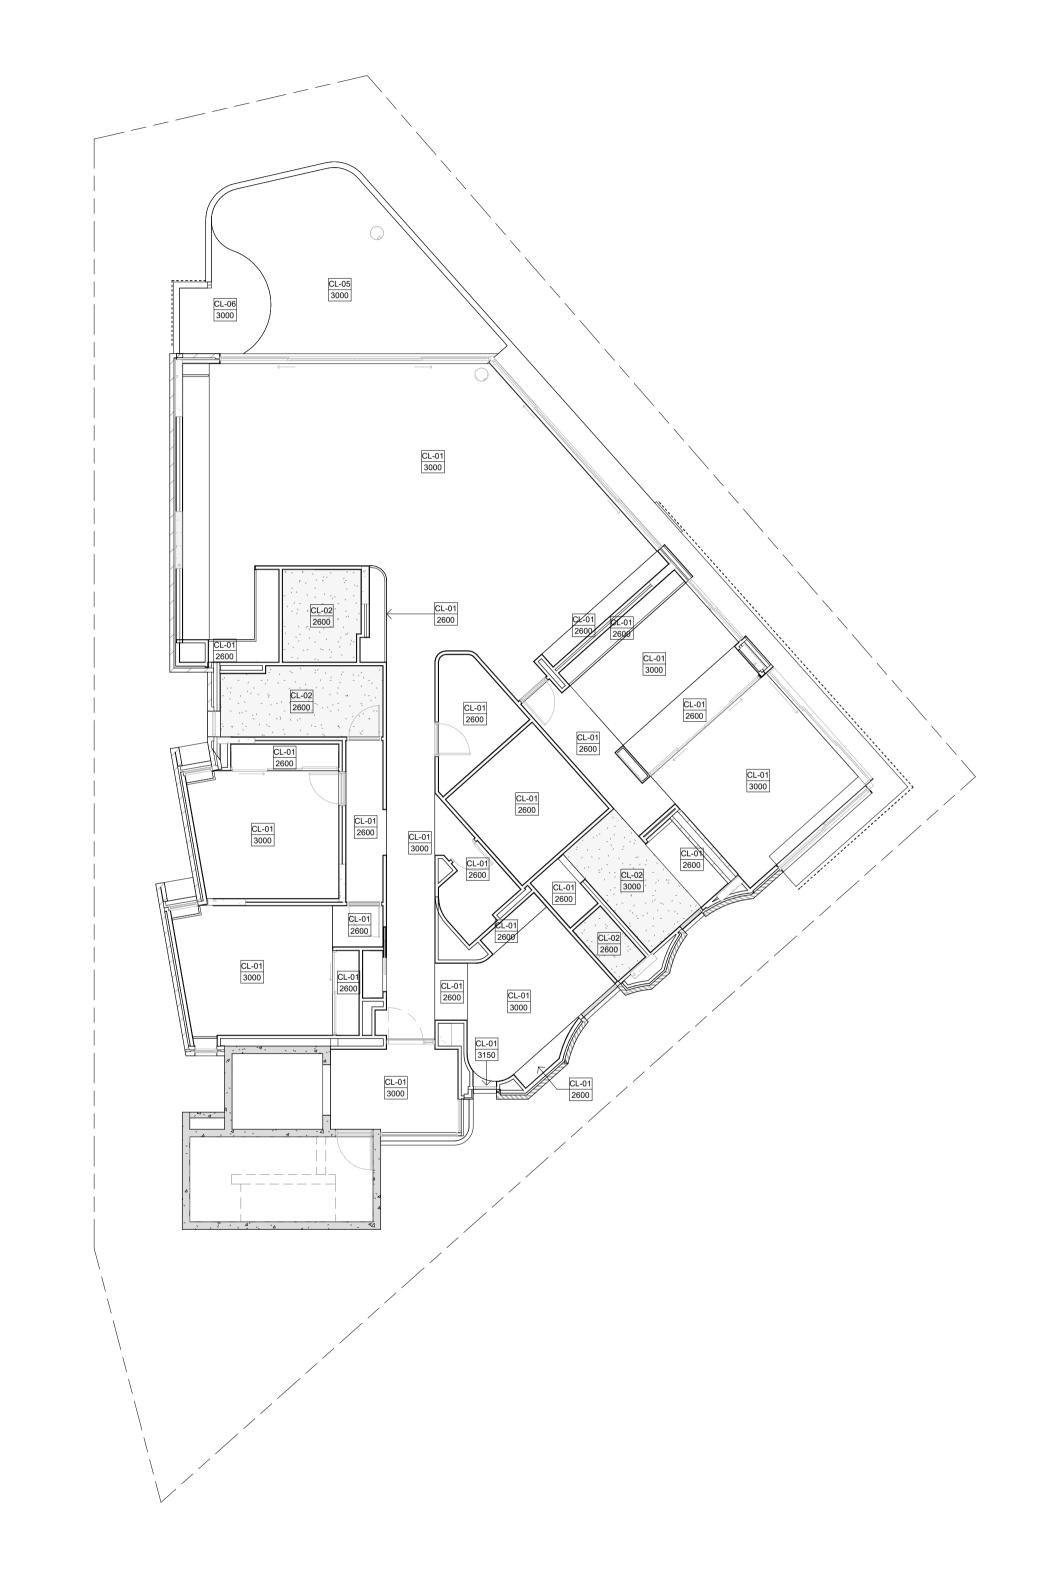


DATE	
	DATE

				CONTRACTOR TO CHECK ALL DIMENSIONS AND LEVELS ON SITE
				BEFORE COMMENCING ANY WORK OR
				PREPARING ANY SHOP DRAWINGS. CAD FIGURE DIMENSIONS TAKE
				PRECEDENCE OVER MEASUREMENTS MANUALLY SCALED OFF DRAWINGS.
				LARGE SCALE DWGS TAKE
DATE Y M D	REV	RECIPIENT / REASON FOR ISSUE	BY	PRECEDENCE OVER SMALLER SCALE DWGS.

CANNING BEACH ROAD LOT 1 65a+b CANNING BEACH ROAD APPLECROSS 6153 Third Floor Ceiling Plan

JC THIS IS A CAD DRAWING DO NOT AMEND MANUALLY CM DESIGNED CHECKED PRINCIPAL REDUCTION DATE JUSTIN CARRIER CLIENT PROJECT CAPA PROJECT No. GRF19 No. 2 DRAWING No. 2027 A5.04 **SCALE** 1: 100 IFC PROGRESS DOCUMENTATION



GENERAL NOTES ALL DIMENSIONS ARE IN MILLIMETRES U.N.O. WRITTEN DIMENSIONS SHALL TAKE PRECEDENCE OVER SCALED CONTRACTOR SHALL CARRY OUT WORK IN CONFORMANCE WITH THE B.C.A./N.C.C. RELEVANT STANDARDS AND THE LOCAL AUTHORITY REQUIREMENTS.
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STRUCTURAL AND SERVICE CONSULTANT DOCUMENTATION TO ENSURE FULL CO-ORDINATION BETWEEN TRADES PRIOR TO WORK COMMENCEMENT. WORK COMMENCEMENT.

LARGE SCALE DRAWINGS SHALL TAKE PRECEDENCE OVER
SMALLER SCALE DRAWINGS. CONTRACTOR SHALL CARRY OUT
WORK IN CONFORMANCE WITH THE B.C.A./N.C.C. RELEVANT
STANDARDS AND THE LOCAL AUTHORITY REQUIREMENTS.
SEEK CLARIFICATION FROM SUPERINTENDENT FOR ANY SEEK CLARIFICATION FROM SUPERINTENDENT FOR ANY DISCREPANCIES.
ALL EXTERNAL FLOOR SURFACES TO FALL AWAY FROM BUILDING.
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BUILDING TAG REFER MASTER MATERIALS SCHEDULE FOR THE FOLLOWING AND MORE:
16.1 STRUCTURE SURFACE FINISHES 16.4 FINISHES
16.2 FIXTURES & FITTINGS 16.5 APPLIANCES
16.3 WATERPROOFING SYSTEMS 16.6 TRIMS

L-0	1	13mm PLASTERBOARD, WITH P50 SHADOW LINE
L-0	2	CORNICE 13mm MR PLASTERBOARD, WITH P50 SHADOW LINE
1 0		CORNICE - MOISTURE RESISTANT EXPOSED TIMBER CEILING BATTENS
L-0 L-0	-	40mm SLAB INSULATION
L-0		6mm FIBRE CEMENT SHEET SOFFIT W/ FLUSH JOINT
L-0	6	6mm FIBRE CEMENT SHEET SOFFIT W/ FLUSH JOINT
	CEILIN	G LEGEND
	XXX XXX	 CEILING MATERIAL TYPE / CORNICE TYPE. REFER SCHEDULE FINISHES HEIGHT ABOVE RESPECTIVE INTERNAL STRUCTURAL FLOOR LEVEL
	ĆĿ-01-	FLUSH JOINT PLASTERBOARD CEILING. PAINTED FINISH.
	CL-02	FLUSH JOINT MOISTURE RESISTANT PLASTERBOARD CEILING. PAINTED FINISH.
	CL-03	6MM FIBRE CEMENT FLUSH JOINT SOFFIT. REFER MATERIAL TAG FOR FINISH
	usc	UNDERSIDE OF SUSPENDED CONCRETE FLOOR SLAB. REFER MATERIAL TAG FOR FINISH
		CONCEALED SOFFIT BOARD INSULATION TO UNDERSIDE OF SLAB ABOVE. CONCEAL IN CEILING VOID. REFER SCHEDULE FOR PRODUCT.
		EXPOSED SOFFIT BOARD INSULATION TO UNDERSIDE OF SLAB ABOVE. E.A. TRIMS TO PERIMETER. REFER SCHEDULE FOR PRODUCT
		ROOF INSULATION BLANKET WITH THERMAL SPACER AND REFLECTIVE FOILS. REFER SCHEDULE FOR PRODUCT.
	CEILIN	FER SCHEDULE FOR DETAILED CEILING / INSULATION INFORMATION. G NOTES
	1.	NOMINATED CEILING HEIGHTS ARE TAKEN FROM RESPECTIVE FLOOR PLAN SFL, U.N.O.
	2.	ALL INTERNAL PLASTERBOARD CEILINGS AND BULKHEADS FLUSHED AND PAINTED, U.N.O. REFER INTERIOR SCHEDULE FOR COLOUR.
	3.	ALL EXTERNAL SOFFIT LININGS FLUSHED AND PAINTED, U.N.O.
	4.	LUMINAIRE SELECTIONS MAY REQUIRE CANISTERS FOR RECESSING INTO CONCRETE SOFFIT, BUILDER TO ALLOW.
	5.	PLASTERBOARD CEILINGS WITHIN WET AREAS AND EXTERNAL ARE TO BE MOISTURE RESISTANT.
	6.	WHERE THERE IS A DROP CEILING TO A HIGH CEILING, CORNICE TO THE HIGH CEILING ONLY, SQUARE-SET CORNICE FOR DROP CEILING. (ie KITCHENS, ROBES WITH SLIDING DOORS & LAUNDRY CUPBOARDS)
	7.	CORNICES TO FULL CEILING PERIMETER INCLUDING WHERE CEILING MEETS BULKHEAD/DROPPED CEILINGS, EXCEPTIONS AS BELOW: WHERE CABINET TOPS FINISH AT CEILING LEVEL, STOP CORNICE AT CABINET TOP TRIMS/SCRIBER (DO NOT CONTINUE IN FRONT OF TOP TRIMS). WHERE THERE IS A BLIND RECESS.
	8.	REFER TO SERVICE CONSULTANT DRAWINGS FOR FULL EXTENT OF ELECTRICAL AND MECHANICAL SERVICES INCLUDING; LIGHTING LAYOUT POWER, DATE AND COMMS DRY FIRE SERVICE EQUIPMENT MECHANICAL SERVICES
		MEST WATER CENTRICES

MECHANICAL SERVICES
CEILING ACCESS PANELS FOR SERVICES
WITHIN CEILING SPACE
WET AREA EXHAUST

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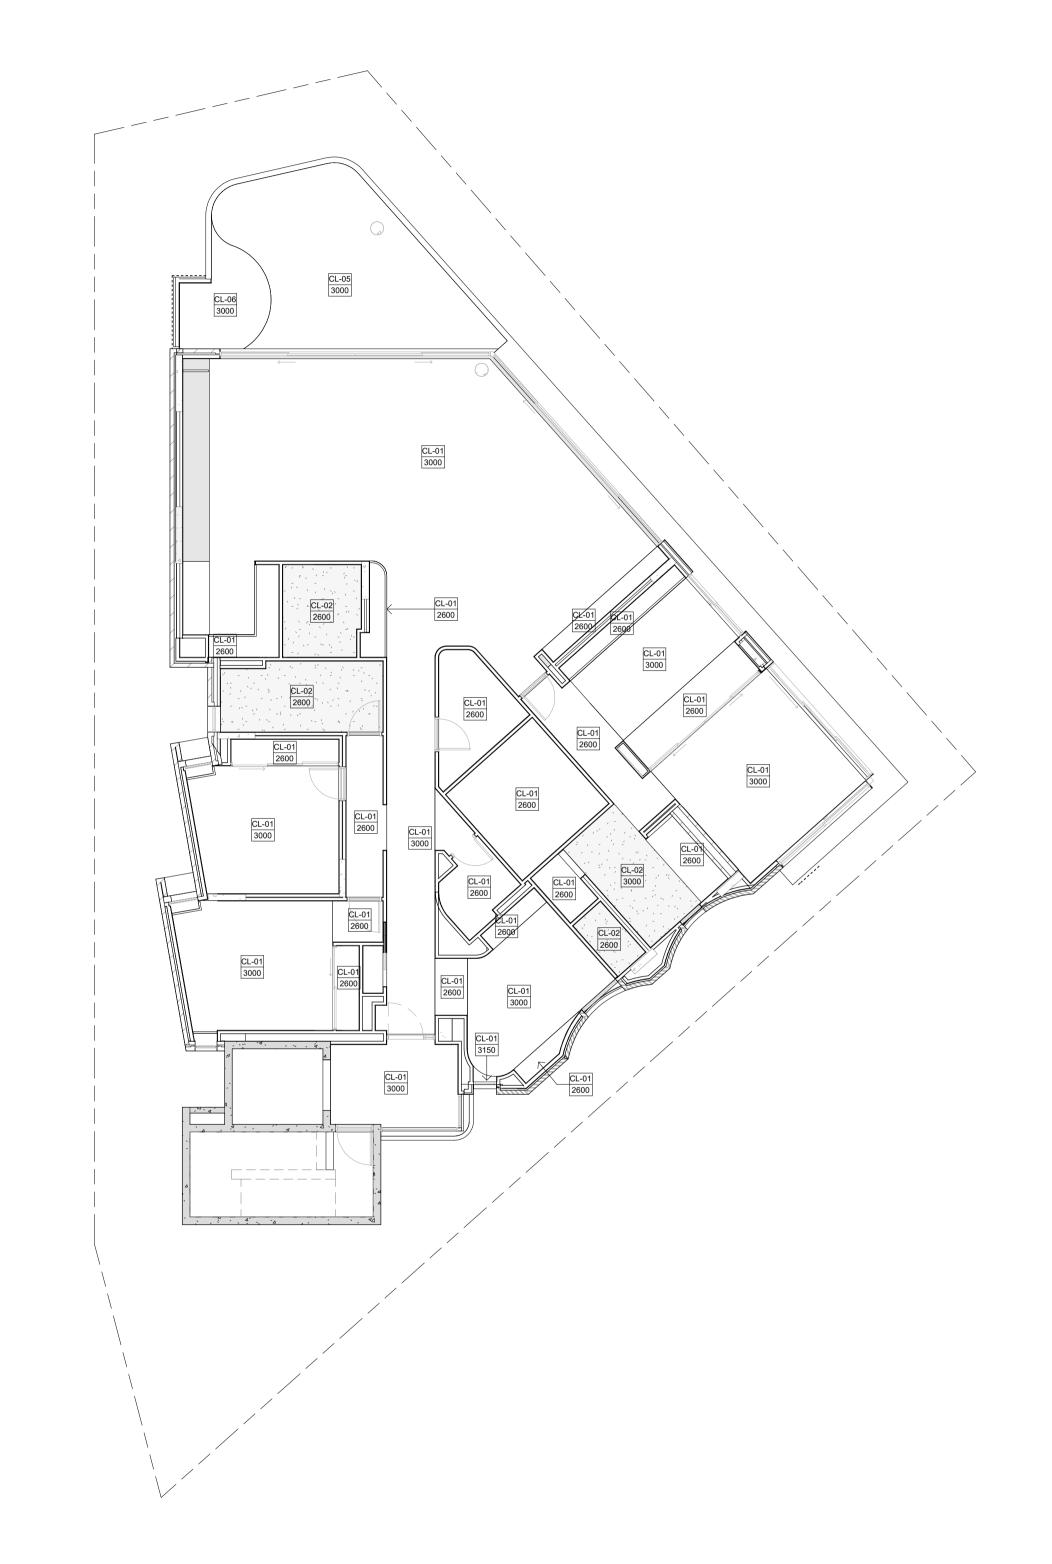


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	YMD	REV	RECIPIENT / REASON FOR ISSUE	BY	DWGS.

CANNING BEACH ROAD LOT 1 65a+b CANNING BEACH ROAD APPLECROSS 6153 Fourth Floor Ceiling plan

THIS IS A CAD DRAWING Designed NOT AMEND MANUALLY Author DESIGNED Checker CHECKED REDUCTION DATE JUSTIN CARRIER CLIENT PROJECT CAPA PROJECT No. GRF19 No. 2 DRAWING No. 2027 No. A5.05 **SCALE** 1: 100 IFC PROGRESS DOCUMENTATION



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THE MAIN CONTRACTOR IS TO ENSURE THIS DRAWING IS READ IN CONJUNCTION WITH ALL RELEVANT ARCHITECTURAL,
STRUCTURAL AND SERVICE CONSULTANT DOCUMENTATION TO ENSURE FULL CO-ORDINATION BETWEEN TRADES PRIOR TO WORK COMMENCEMENT. WORK COMMENCEMENT.

LARGE SCALE DRAWINGS SHALL TAKE PRECEDENCE OVER

SMALLER SCALE DRAWINGS. CONTRACTOR SHALL CARRY OUT

WORK IN CONFORMANCE WITH THE B.C.A./N.C.C. RELEVANT

STANDARDS AND THE LOCAL AUTHORITY REQUIREMENTS.

SEEK CLARIFICATION FROM SUPERINTENDENT FOR ANY SEEK CLARIFICATION FROM SUPERINTENDENT FOR ANY DISCREPANCIES.

ALL EXTERNAL FLOOR SURFACES TO FALL AWAY FROM BUILDING.

REFER INTERIOR DOCUMENTATION FOR SETOUTS AND EXACT LOCATIONS OF CABINETRY, FITTINGS, FIXTURES, PLUMBING, FLOOR WASTES AND TILING.

ALL MATERIALS SHALL BE NEW & COMFORM TO WHAT IS SHOWN ON THE DRAWINGS AND IN THE SCHEDULES.

THE CONTRACTOR SHALL CHECK & VERIFY ALL DIMENSIONS ON SITE, PRIOR TO THE COMMENCEMENT OF ANY BUILDING WORK.

ALL WINDOW DIMENSIONS ARE NOMINAL AND ARE TO BE MEASURED ON SITE. MEASURED ON SITE.
THE CONTRACTOR SHALL VISIT THE SITE & NOTE ALL SITE CONDITIONS & ACCESS REQUIREMENTS.
REFER TO WALL TYPES PLANS FOR WALL SETOUTS.
REFER SLAB SETOUT PLANS FOR SLAB AND STRUCTURAL REFER SLAB SETOUT PLANS FUR SLAB AND STRUCTURAL COLUMN SETOUTS.
ENSURE ALL STRUCTURAL STEEL COLUMNS WITHIN 3m OF SITE BOUNDARY TO BE FIRE PROTECTED TO CODES AND STANDARDS. INSTALL FLASHINGS, EDGE TRIMS AND APPROPRIATE SEASL AS REQUIRED TO ACHIEVE WEATHER TIGHTNESS. FINISH TO BE SAME AS ADJACENT MATERIAL U.N.O.
BUILDING TAG REFER MASTER MATERIALS SCHEDULE FOR THE FOLLOWING AND MORE:
16.1 STRUCTURE SURFACE FINISHES 16.4 FINISHES
16.2 FIXTURES & FITTINGS 16.5 APPLIANCES
16.3 WATERPROOFING SYSTEMS 16.6 TRIMS

01			13mm PLASTERBOARD, WITH P50 SHADOW LINE CORNICE
02			13mm MR PLASTERBOARD, WITH P50 SHADOW LINE CORNICE - MOISTURE RESISTANT
03			EXPOSED TIMBER CEILING BATTENS
04			40mm SLAB INSULATION
05			6mm FIBRE CEMENT SHEET SOFFIT W/ FLUSH JOINT
06			6mm FIBRE CEMENT SHEET SOFFIT W/ FLUSH JOINT
	CEILIN	G LEC	GEND
	XXX	← F	CEILING MATERIAL TYPE / CORNICE TYPE. REFER SCHEDULE INISHES HEIGHT ABOVE RESPECTIVE INTERNAL STRUCTURAL FLOOR LEVEL
	ÇL-01.		H JOINT PLASTERBOARD NG. PAINTED FINISH.
	CL-02		H JOINT MOISTURE RESISTANT TERBOARD CEILING. PAINTED H.
	CL-03		FIBRE CEMENT FLUSH JOINT SOFFIT. R MATERIAL TAG FOR FINISH
	usc		RSIDE OF SUSPENDED CONCRETE FLOOR REFER MATERIAL TAG FOR FINISH
		SLAB	EALED SOFFIT BOARD INSULATION TO UNDERSIDE OF ABOVE. CONCEAL IN CEILING VOID. REFER SCHEDULE PRODUCT.
		SLAB	SED SOFFIT BOARD INSULATION TO UNDERSIDE OF ABOVE. E.A. TRIMS TO PERIMETER. REFER DULE FOR PRODUCT
			INSULATION BLANKET WITH THERMAL SPACER AND ECTIVE FOILS. REFER SCHEDULE FOR PRODUCT.
	NOTE: RECEILING	G NO	CHEDULE FOR DETAILED CEILING / INSULATION INFORMATION. TES DMINATED CEILING HEIGHTS ARE TAKEN FROM ESPECTIVE FLOOR PLAN SFL, U.N.O.
	2.	Βl	L INTERNAL PLASTERBOARD CEILINGS AND JILKHEADS FLUSHED AND PAINTED, U.N.O. REFER TERIOR SCHEDULE FOR COLOUR.
	3.	AL	L EXTERNAL SOFFIT LININGS FLUSHED AND PAINTED, N.O.
	4.	RE	IMINAIRE SELECTIONS MAY REQUIRE CANISTERS FOR ECESSING INTO CONCRETE SOFFIT, BUILDER TO LOW.
	5.		ASTERBOARD CEILINGS WITHIN WET AREAS AND (TERNAL ARE TO BE MOISTURE RESISTANT.
	6.	CC	HERE THERE IS A DROP CEILING TO A HIGH CEILING, DRNICE TO THE HIGH CEILING ONLY, SQUARE-SET DRNICE FOR DROP CEILING. (ie KITCHENS, ROBES WITH IDING DOORS & LAUNDRY CUPBOARDS)
	7.	W	ORNICES TO FULL CEILING PERIMETER INCLUDING HERE CEILING MEETS BULKHEAD/DROPPED CEILINGS, (CEPTIONS AS BELOW: WHERE CABINET TOPS FINISH AT CEILING LEVEL, STOP CORNICE AT CABINET TOP TRIMS/SCRIBER (DO NOT CONTINUE IN FRONT OF TOP TRIMS). WHERE THERE IS A BLIND RECESS.
	8.	EX	EFER TO SERVICE CONSULTANT DRAWINGS FOR FULL (TENT OF ELECTRICAL AND MECHANICAL SERVICES CLUDING; LIGHTING LAYOUT POWER, DATE AND COMMS DRY FIRE SERVICE EQUIPMENT MECHANICAL SERVICES CEILING ACCESS PANELS FOR SERVICES WITHIN CEILING SPACE WET AREA EXHAUST



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e. inio@gninii-group.com.au			
	DATE Y.M.D	REV	RECIPIENT / REASON FOR ISSUE

CONTRACTOR TO CHECK ALL **CANNING BEACH ROAD** DIMENSIONS AND LEVELS ON SITE BEFORE COMMENCING ANY WORK OR LOT 1 65a+b CANNING BEACH ROAD PREPARING ANY SHOP DRAWINGS. APPLECROSS 6153 CAD FIGURE DIMENSIONS TAKE PRECEDENCE OVER MEASUREMENTS
MANUALLY SCALED OFF DRAWINGS.
LARGE SCALE DWGS TAKE
PRECEDENCE OVER SMALLER SCALE

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LARGE SCALE DWGS TAKE
PRECEDENCE OVER SMALLER SCALE

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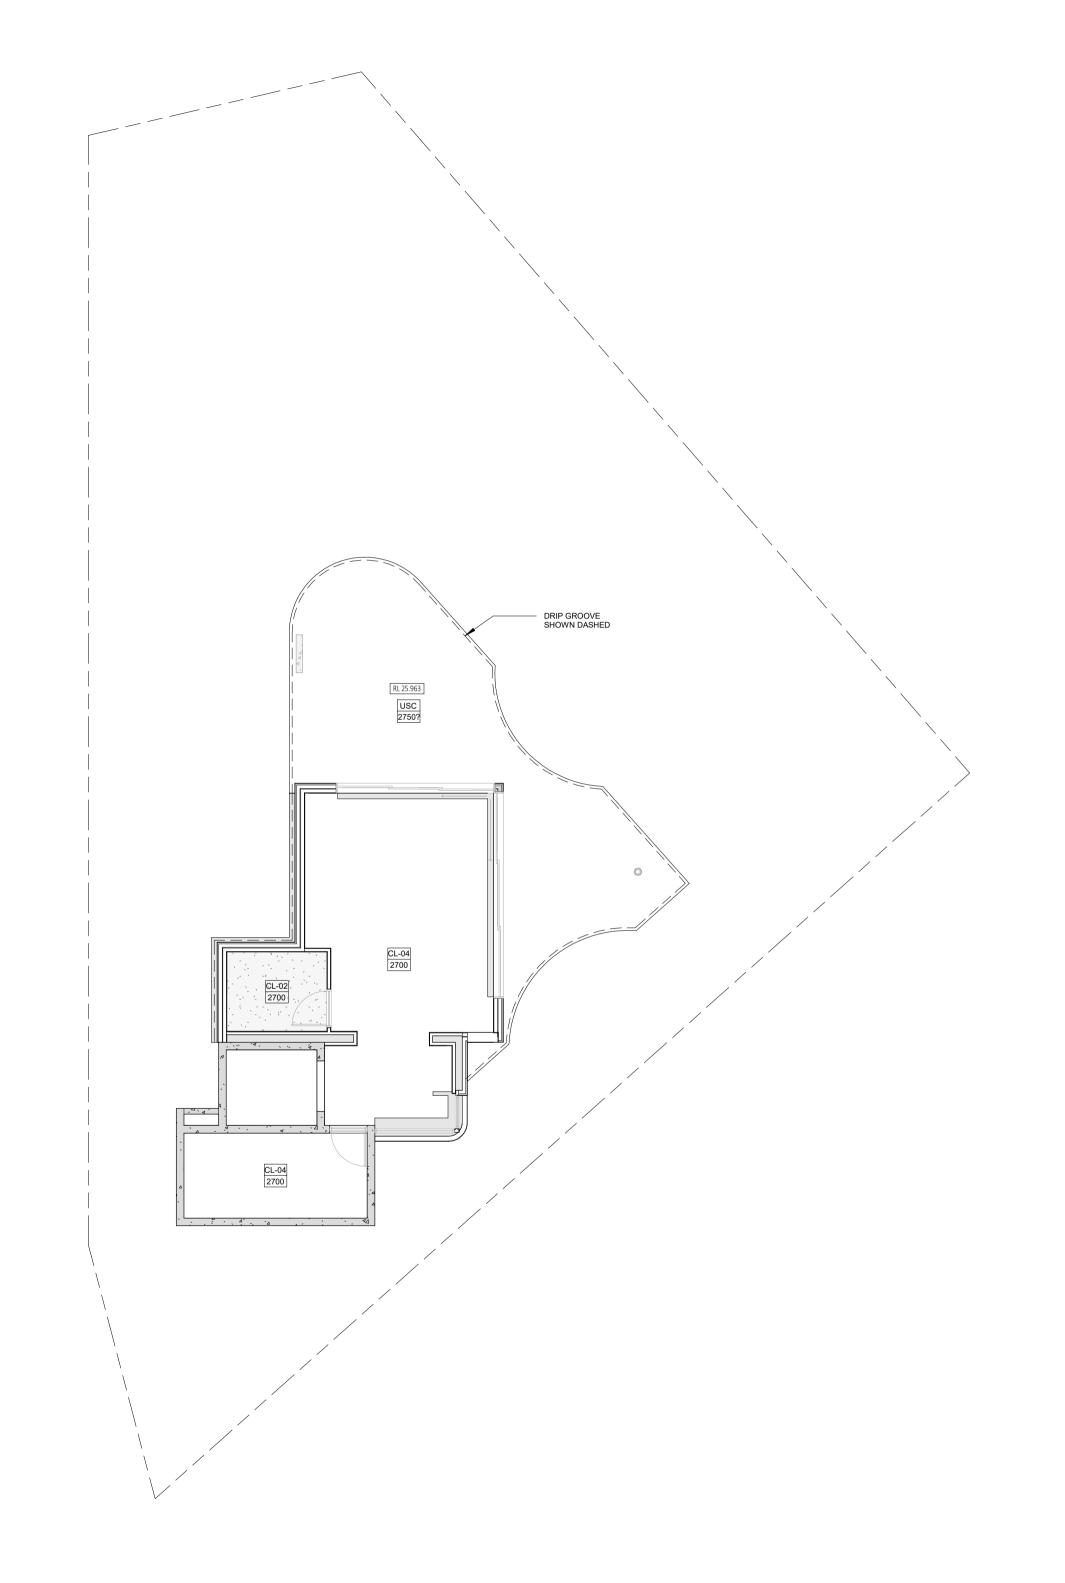
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SMALLER SCALE DRAWINGS. CONTRACTOR SHALL CARRY OUT WORK IN CONFORMANCE WITH THE B.C.A./N.C.C. RELEVANT STANDARDS AND THE LOCAL AUTHORITY REQUIREMENTS. SEEK CLARIFICATION FROM SUPERINTENDENT FOR ANY DISCREPANCIES.
ALL EXTERNAL FLOOR SURFACES TO FALL AWAY FROM BUILDING. REFER INTERIOR DOCUMENTATION FOR SETOUTS AND EXACT LOCATIONS OF CABINETRY, FITTINGS, FIXTURES, PLUMBING, FLOOR WASTES AND TILING. FLOOR WASTES AND TILING.
ALL MATERIALS SHALL BE NEW & COMFORM TO WHAT IS SHOWN
ON THE DRAWINGS AND IN THE SCHEDULES.
THE CONTRACTOR SHALL CHECK & VERIFY ALL DIMENSIONS ON
SITE, PRIOR TO THE COMMENCEMENT OF ANY BUILDING WORK. ALL WINDOW DIMENSIONS ARE NOMINAL AND ARE TO BE MEASURED ON SITE.
THE CONTRACTOR SHALL VISIT THE SITE & NOTE ALL SITE CONDITIONS & ACCESS REQUIREMENTS. REFER TO WALL TYPES PLANS FOR WALL SETOUTS.
REFER SLAB SETOUT PLANS FOR SLAB AND STRUCTURAL REFER SLAB SETOUT PLANS FUR SLAB AND STRUCTURAL COLUMN SETOUTS.
ENSURE ALL STRUCTURAL STEEL COLUMNS WITHIN 3m OF SITE BOUNDARY TO BE FIRE PROTECTED TO CODES AND STANDARDS. INSTALL FLASHINGS, EDGE TRIMS AND APPROPRIATE SEASL AS REQUIRED TO ACHIEVE WEATHER TIGHTNESS. FINISH TO BE SAME AS ADJACENT MATERIAL U.N.O.
BUILDING TAG

CL-01	13mm PLASTERBOARD, WITH P50 SHADOW LINE CORNICE			
CL-02	13mm MR PLASTERBOARD, WITH P50 SHADOW LINE CORNICE - MOISTURE RESISTANT			
CL-03	EXPOSED TIMBER CEILING BATTENS			
CL-04	40mm SLAB INSULATION			
CL-05	6mm FIBRE CEMENT SHEET SOFFIT W/ FLUSH JOINT			
CL-06	6mm FIBRE CEMENT SHEET SOFFIT W/ FLUSH JOINT			
CEILING LEG	GEND			
XXX — F	CEILING MATERIAL TYPE / CORNICE TYPE. REFER SCHEDULE FINISHES HEIGHT ABOVE RESPECTIVE INTERNAL STRUCTURAL FLOOR LEVEL			

REFER MASTER MATERIALS SCHEDULE FOR THE FOLLOWING AND MORE:
16.1 STRUCTURE SURFACE FINISHES 16.4 FINISHES
16.2 FIXTURES & FITTINGS 16.5 APPLIANCES
16.3 WATERPROOFING SYSTEMS 16.6 TRIMS

FLUSH JOINT PLASTERBOARD
CEILING. PAINTED FINISH.

FLUSH JOINT MOISTURE RESISTANT
PLASTERBOARD CEILING. PAINTED
FINISH.

CL-03
6MM FIBRE CEMENT FLUSH JOINT SOFFIT.
REFER MATERIAL TAG FOR FINISH

UNDERSIDE OF SUSPENDED CONCRETE FLOOR
SLAB. REFER MATERIAL TAG FOR FINISH

CONCEALED SOFFIT BOARD INSULATION TO UNDERSIDE OF
SLAB ABOVE. CONCEAL IN CEILING VOID. REFER SCHEDULE
FOR PRODUCT.

EXPOSED SOFFIT BOARD INSULATION TO UNDERSIDE OF SLAB ABOVE. E.A. TRIMS TO PERIMETER. REFER SCHEDULE FOR PRODUCT

ROOF INSULATION BLANKET WITH THERMAL SPACER AND REFLECTIVE FOILS. REFER SCHEDULE FOR PRODUCT.

NOTE: REFER SCHEDULE FOR DETAILED CEILING / INSULATION INFORMATION.

CEILING NOTES

1. NOMINATED CEILING HEIGHTS ARE TAKEN FROM RESPECTIVE FLOOR PLAN SEL. U.N.O.

NOMINATED CEILING HEIGHTS ARE TAKEN FROM RESPECTIVE FLOOR PLAN SFL, U.N.O.

 ALL INTERNAL PLASTERBOARD CEILINGS AND

2. ALL INTERNAL PLASTERBOARD CEILINGS AND BULKHEADS FLUSHED AND PAINTED, U.N.O. REFER INTERIOR SCHEDULE FOR COLOUR.

 ALL EXTERNAL SOFFIT LININGS FLUSHED AND PAINTED, U.N.O.
 LUMINAIRE SELECTIONS MAY REQUIRE CANISTERS FOR

5. PLASTERBOARD CEILINGS WITHIN WET AREAS AND EXTERNAL ARE TO BE MOISTURE RESISTANT.

6. WHERE THERE IS A DROP CEILING TO A HIGH CEILING, CORNICE TO THE HIGH CEILING ONLY, SQUARE-SET CORNICE FOR DROP CEILING. (ie KITCHENS, ROBES WITH SUIDING DOORS & LAUNDRY CURPOARDS)

CORNICE FOR DROP CEILING. (ie KITCHENS, ROBES WITH SLIDING DOORS & LAUNDRY CUPBOARDS)

CORNICES TO FULL CEILING PERIMETER INCLUDING WHERE CEILING MEETS BULKHEAD/DROPPED CEILINGS,

EXCEPTIONS AS BELOW:
 WHERE CABINET TOPS FINISH AT CEILING
 LEVEL, STOP CORNICE AT CABINET TOP
 TRIMS/SCRIBER (DO NOT CONTINUE IN FRONT
 OF TOP TRIMS).
 WHERE THERE IS A BLIND RECESS.

8. REFER TO SERVICE CONSULTANT DRAWINGS FOR FULL EXTENT OF ELECTRICAL AND MECHANICAL SERVICES INCLUDING;

INCLUDING;

LIGHTING LAYOUT

POWER, DATE AND COMMS

DRY FIRE SERVICE EQUIPMENT

MECHANICAL SERVICES

CEILING ACCESS PANELS FOR SERVICES
WITHIN CEILING SPACE

WET AREA EXHAUST

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				BEFORE COMMENCING ANY WORK OR
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				CAD FIGURE DIMENSIONS TAKE
				PRECEDENCE OVER MEASUREMENTS
				MANUALLY SCALED OFF DRAWINGS.
				LARGE SCALE DWGS TAKE
DATE		<u> </u>		PRECEDENCE OVER SMALLER SCALE
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VORK OR /INGS. KF	LOT 1 65a+b CANNING BEACH ROAD APPLECROSS 6153
REMENTS	Roof Terrace Ceiling Plan


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DESIGNED
JC
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REDUCTION

30mm@A1
15mm@A3

CLIENT PROJECT
No.
GRF19
CAPA PROJECT
No.
GRF19
CAPA PROJECT
No.
A5.07



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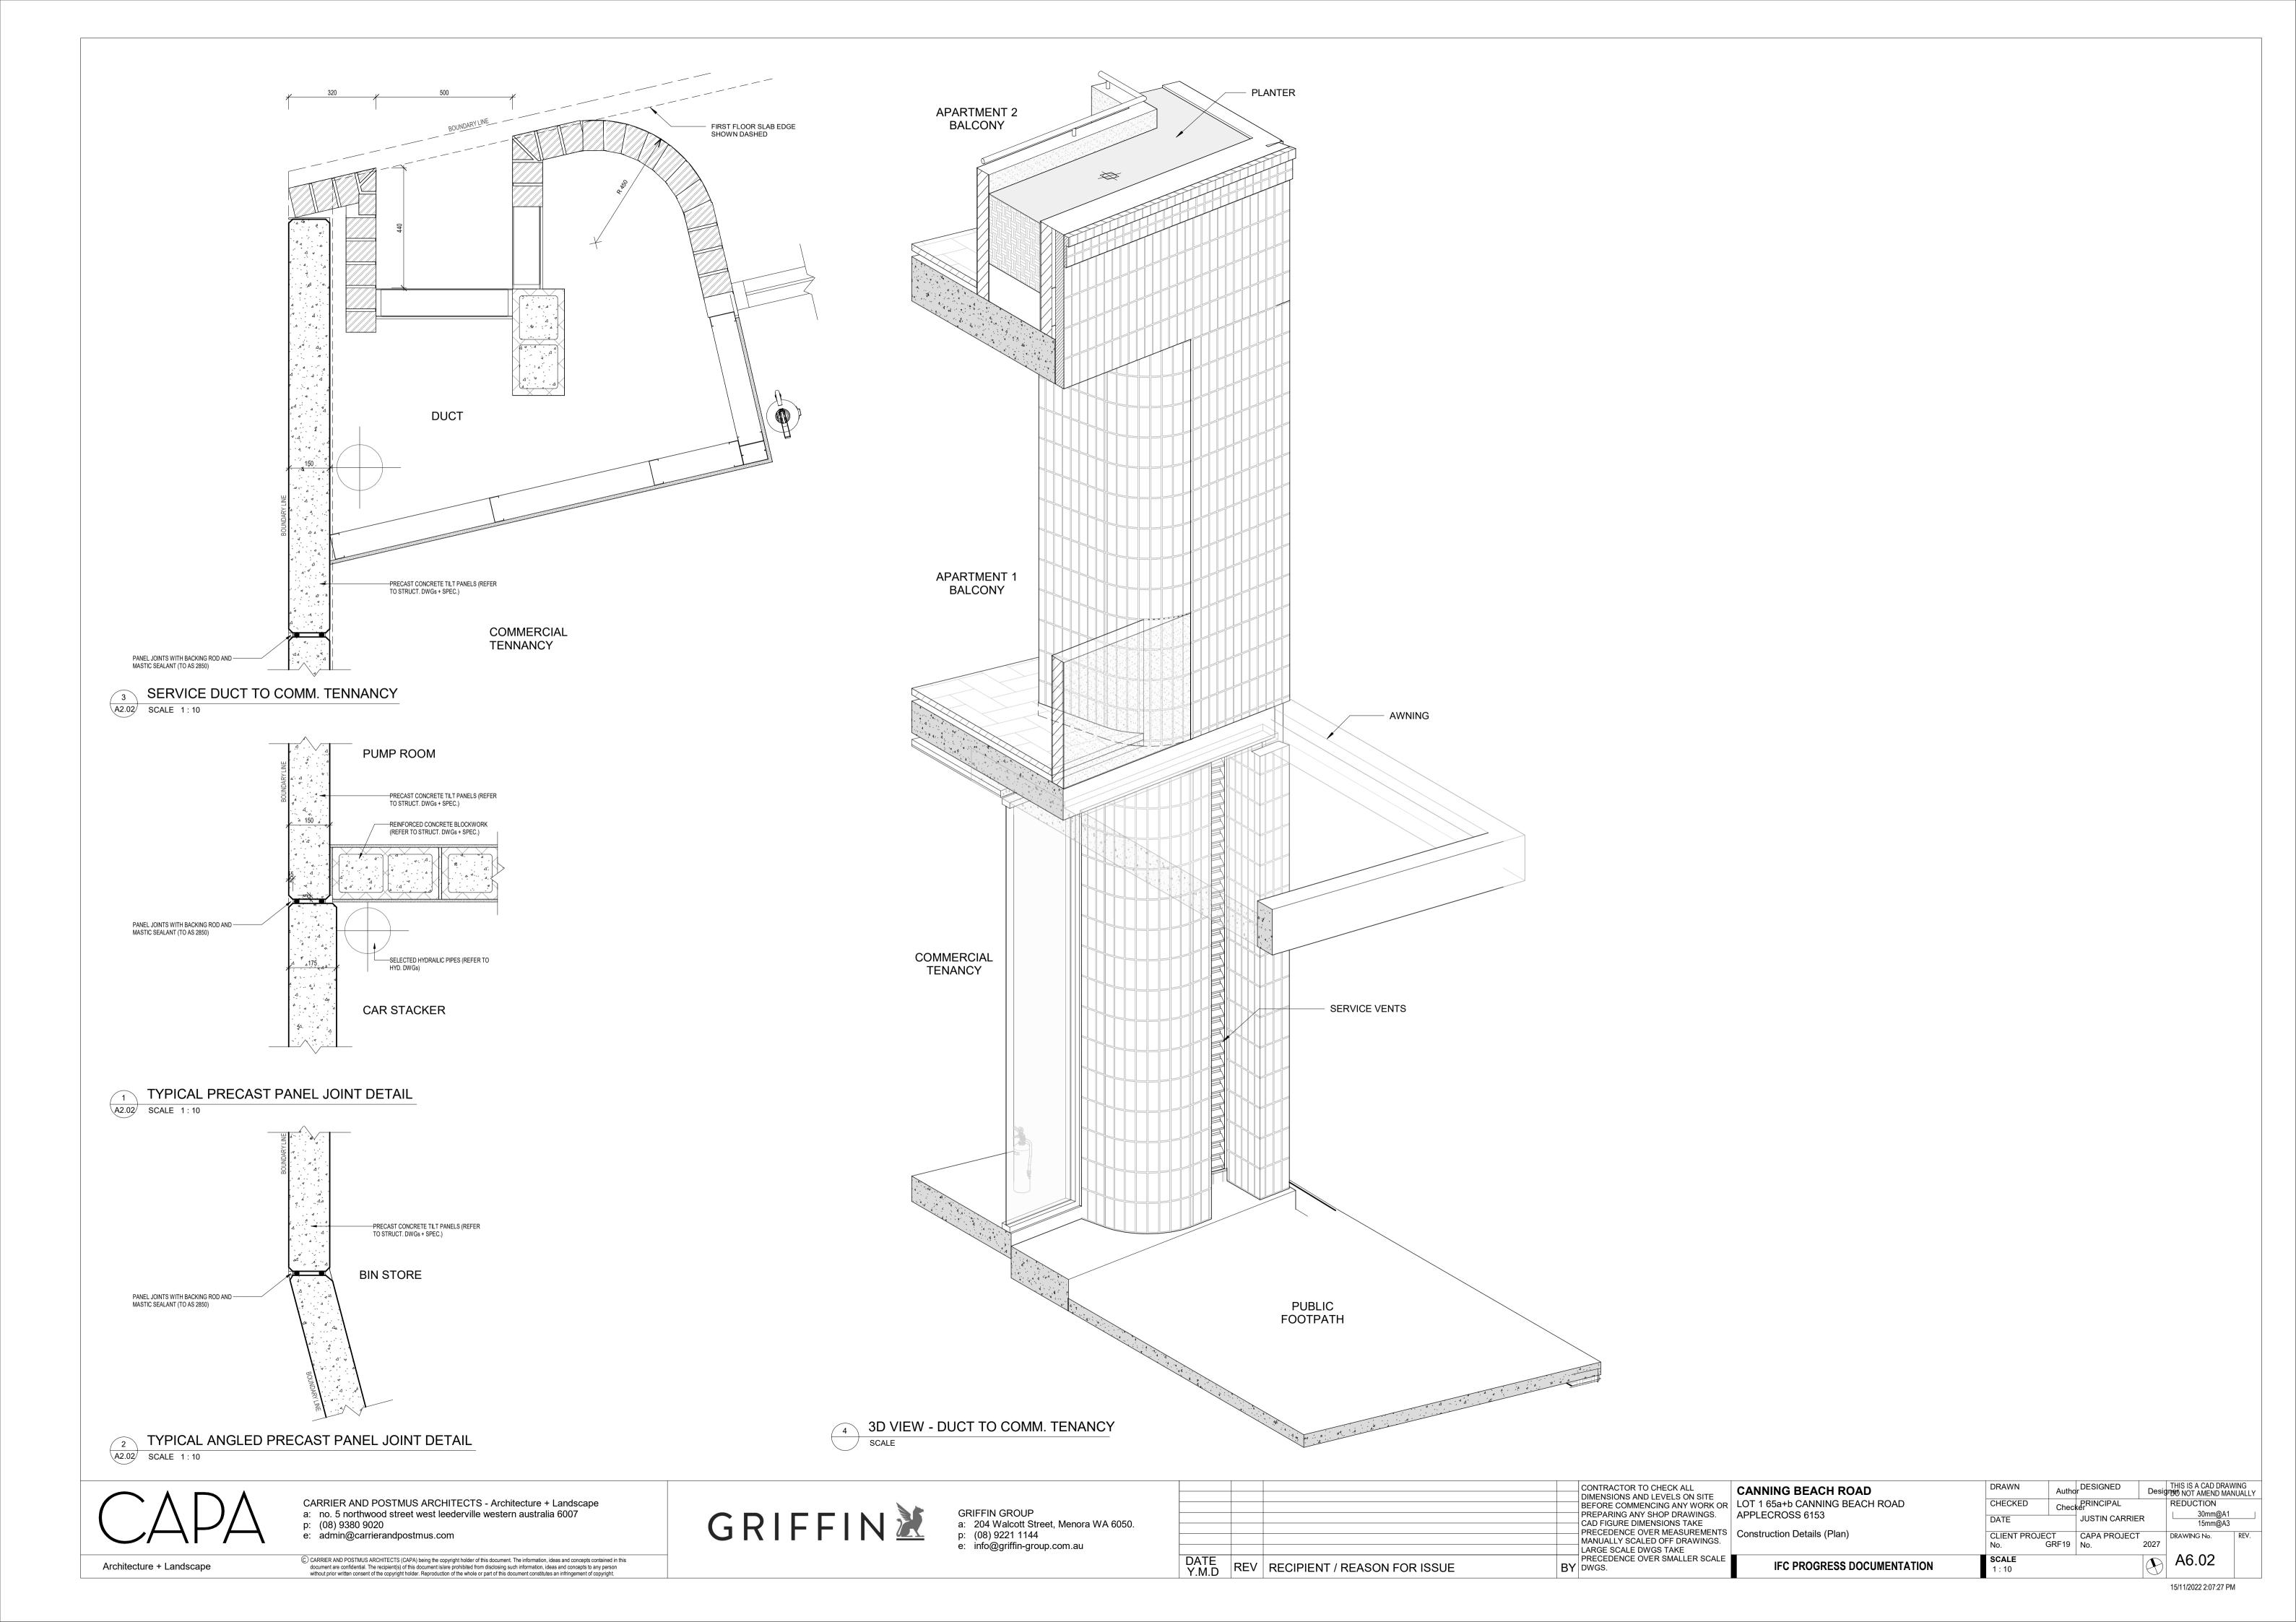
LARGE SCALE DWGS TAKE DATE Y.M.D PRECEDENCE OVER SMALLER SCALE REV | RECIPIENT / REASON FOR ISSUE BY DWGS.

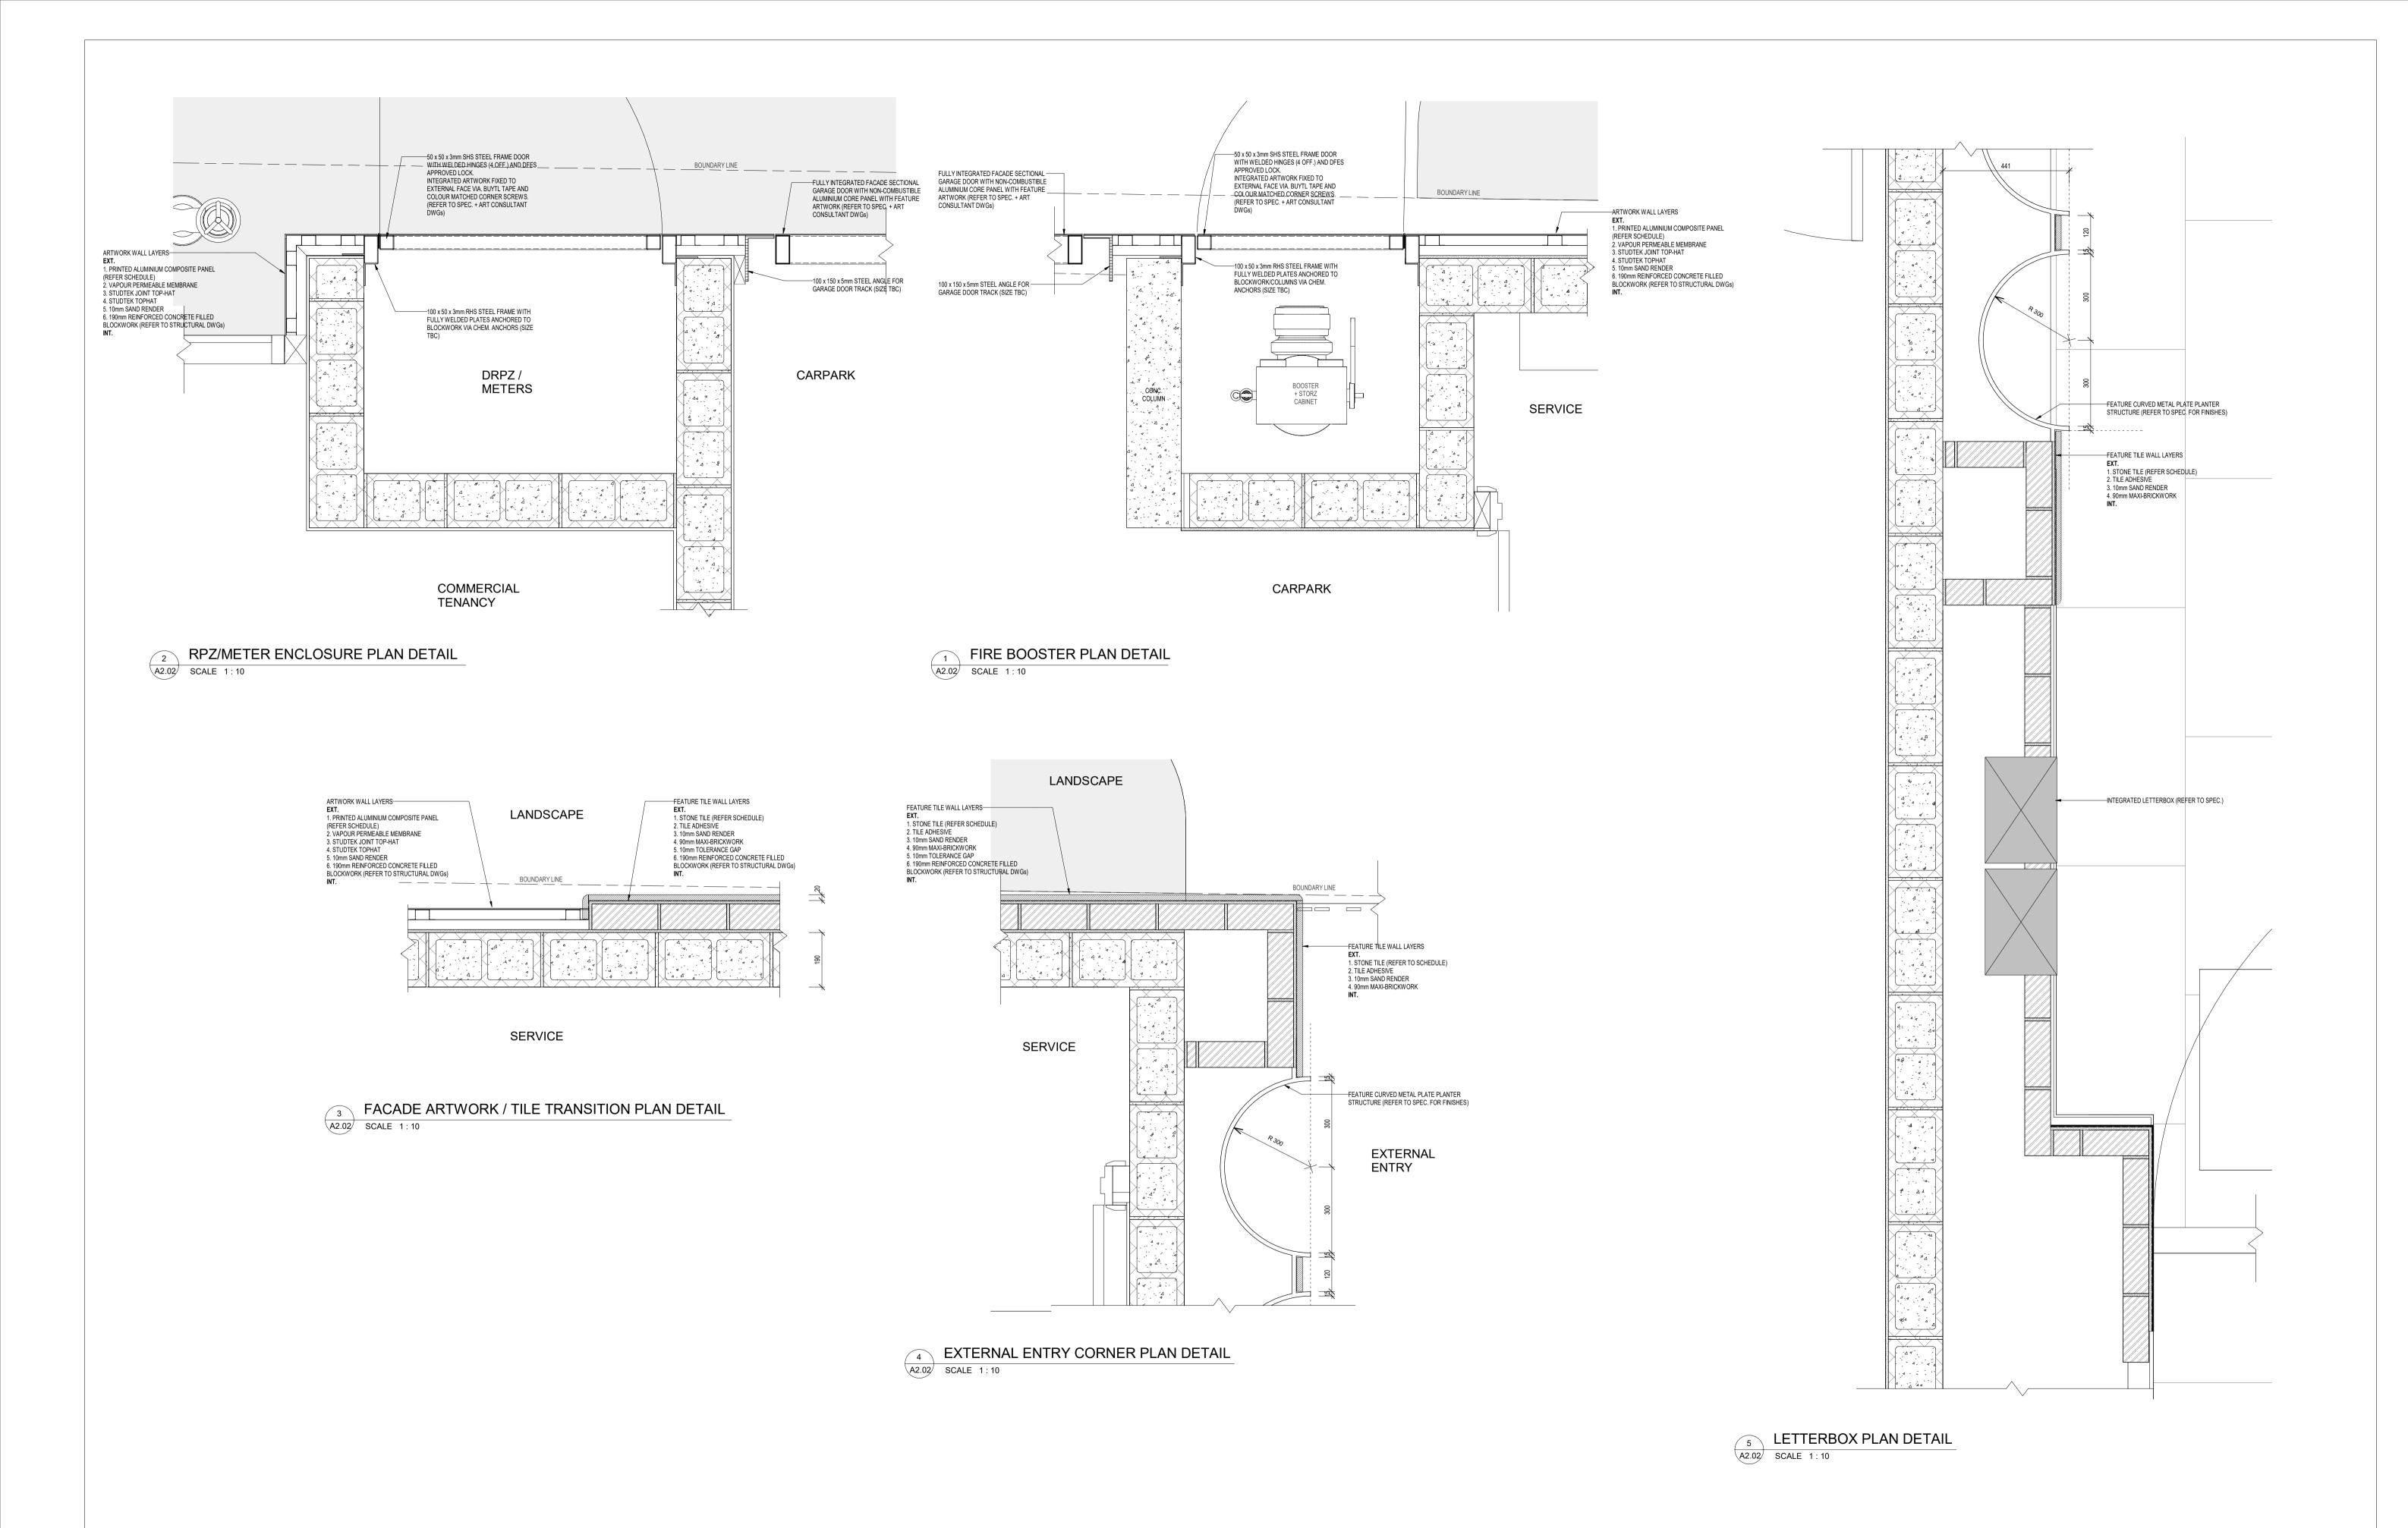
CANNING BEACH ROAD BEFORE COMMENCING ANY WORK OR LOT 1 65a+b CANNING BEACH ROAD APPLECROSS 6153


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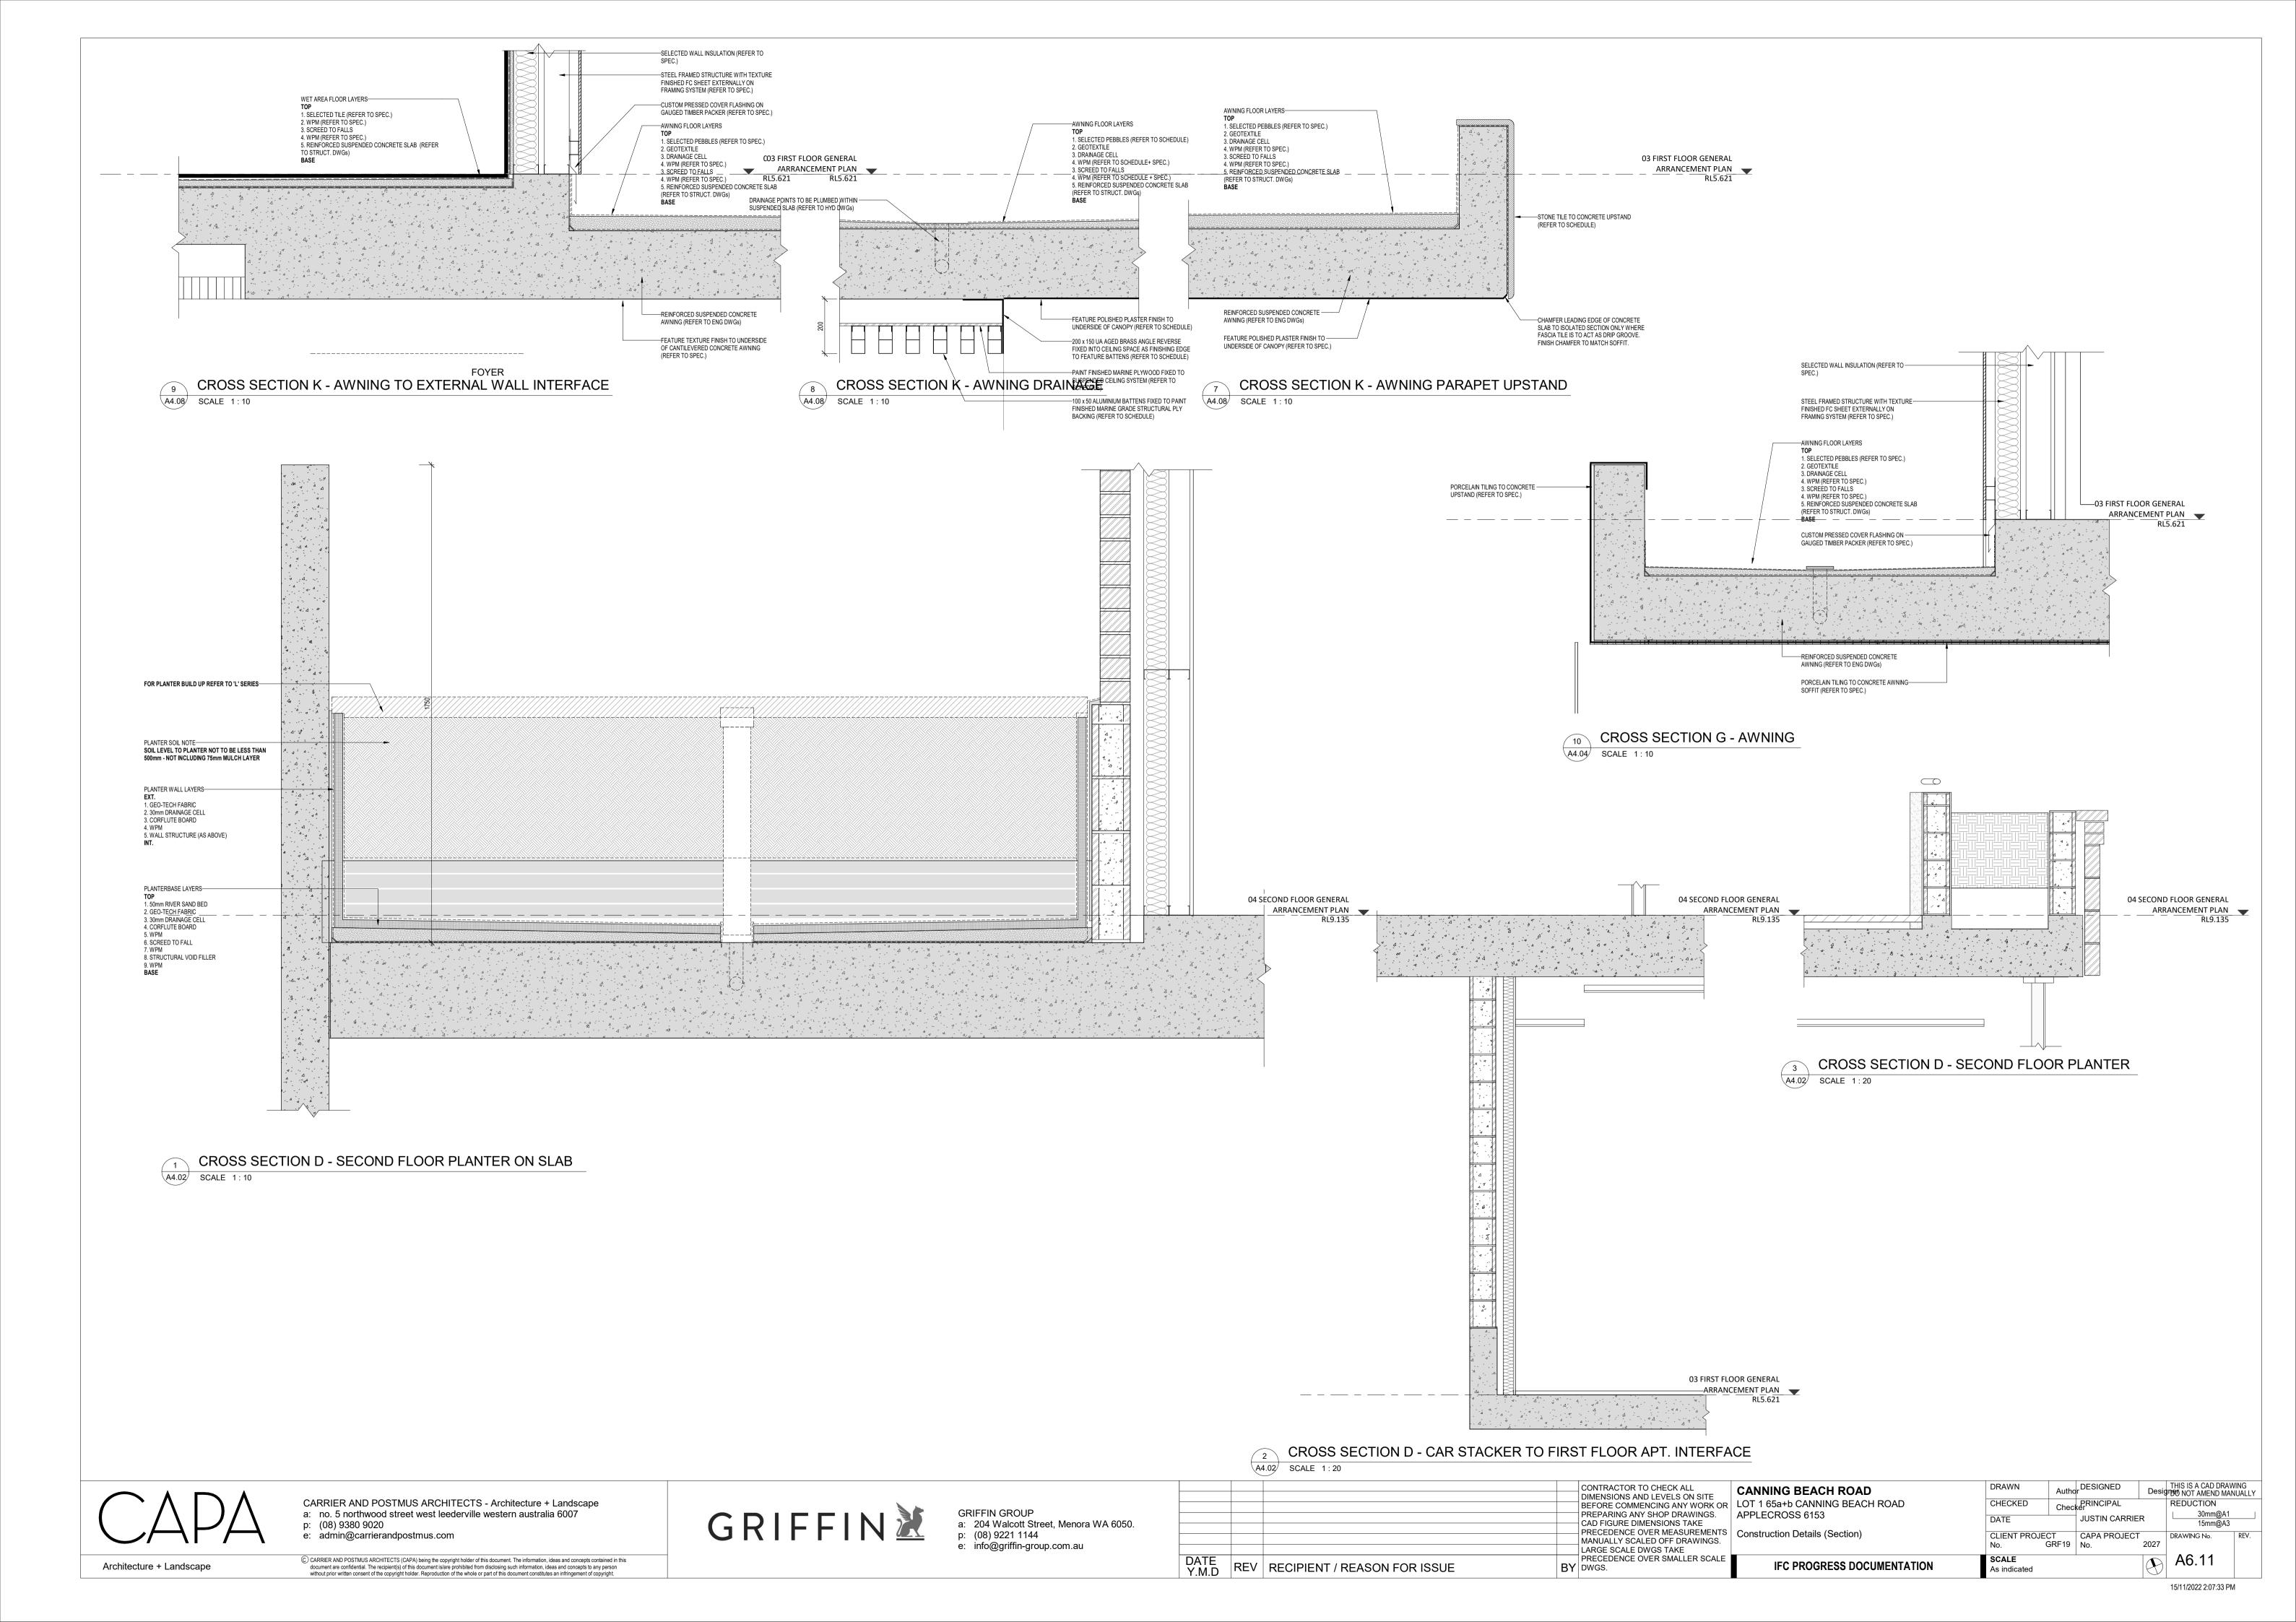
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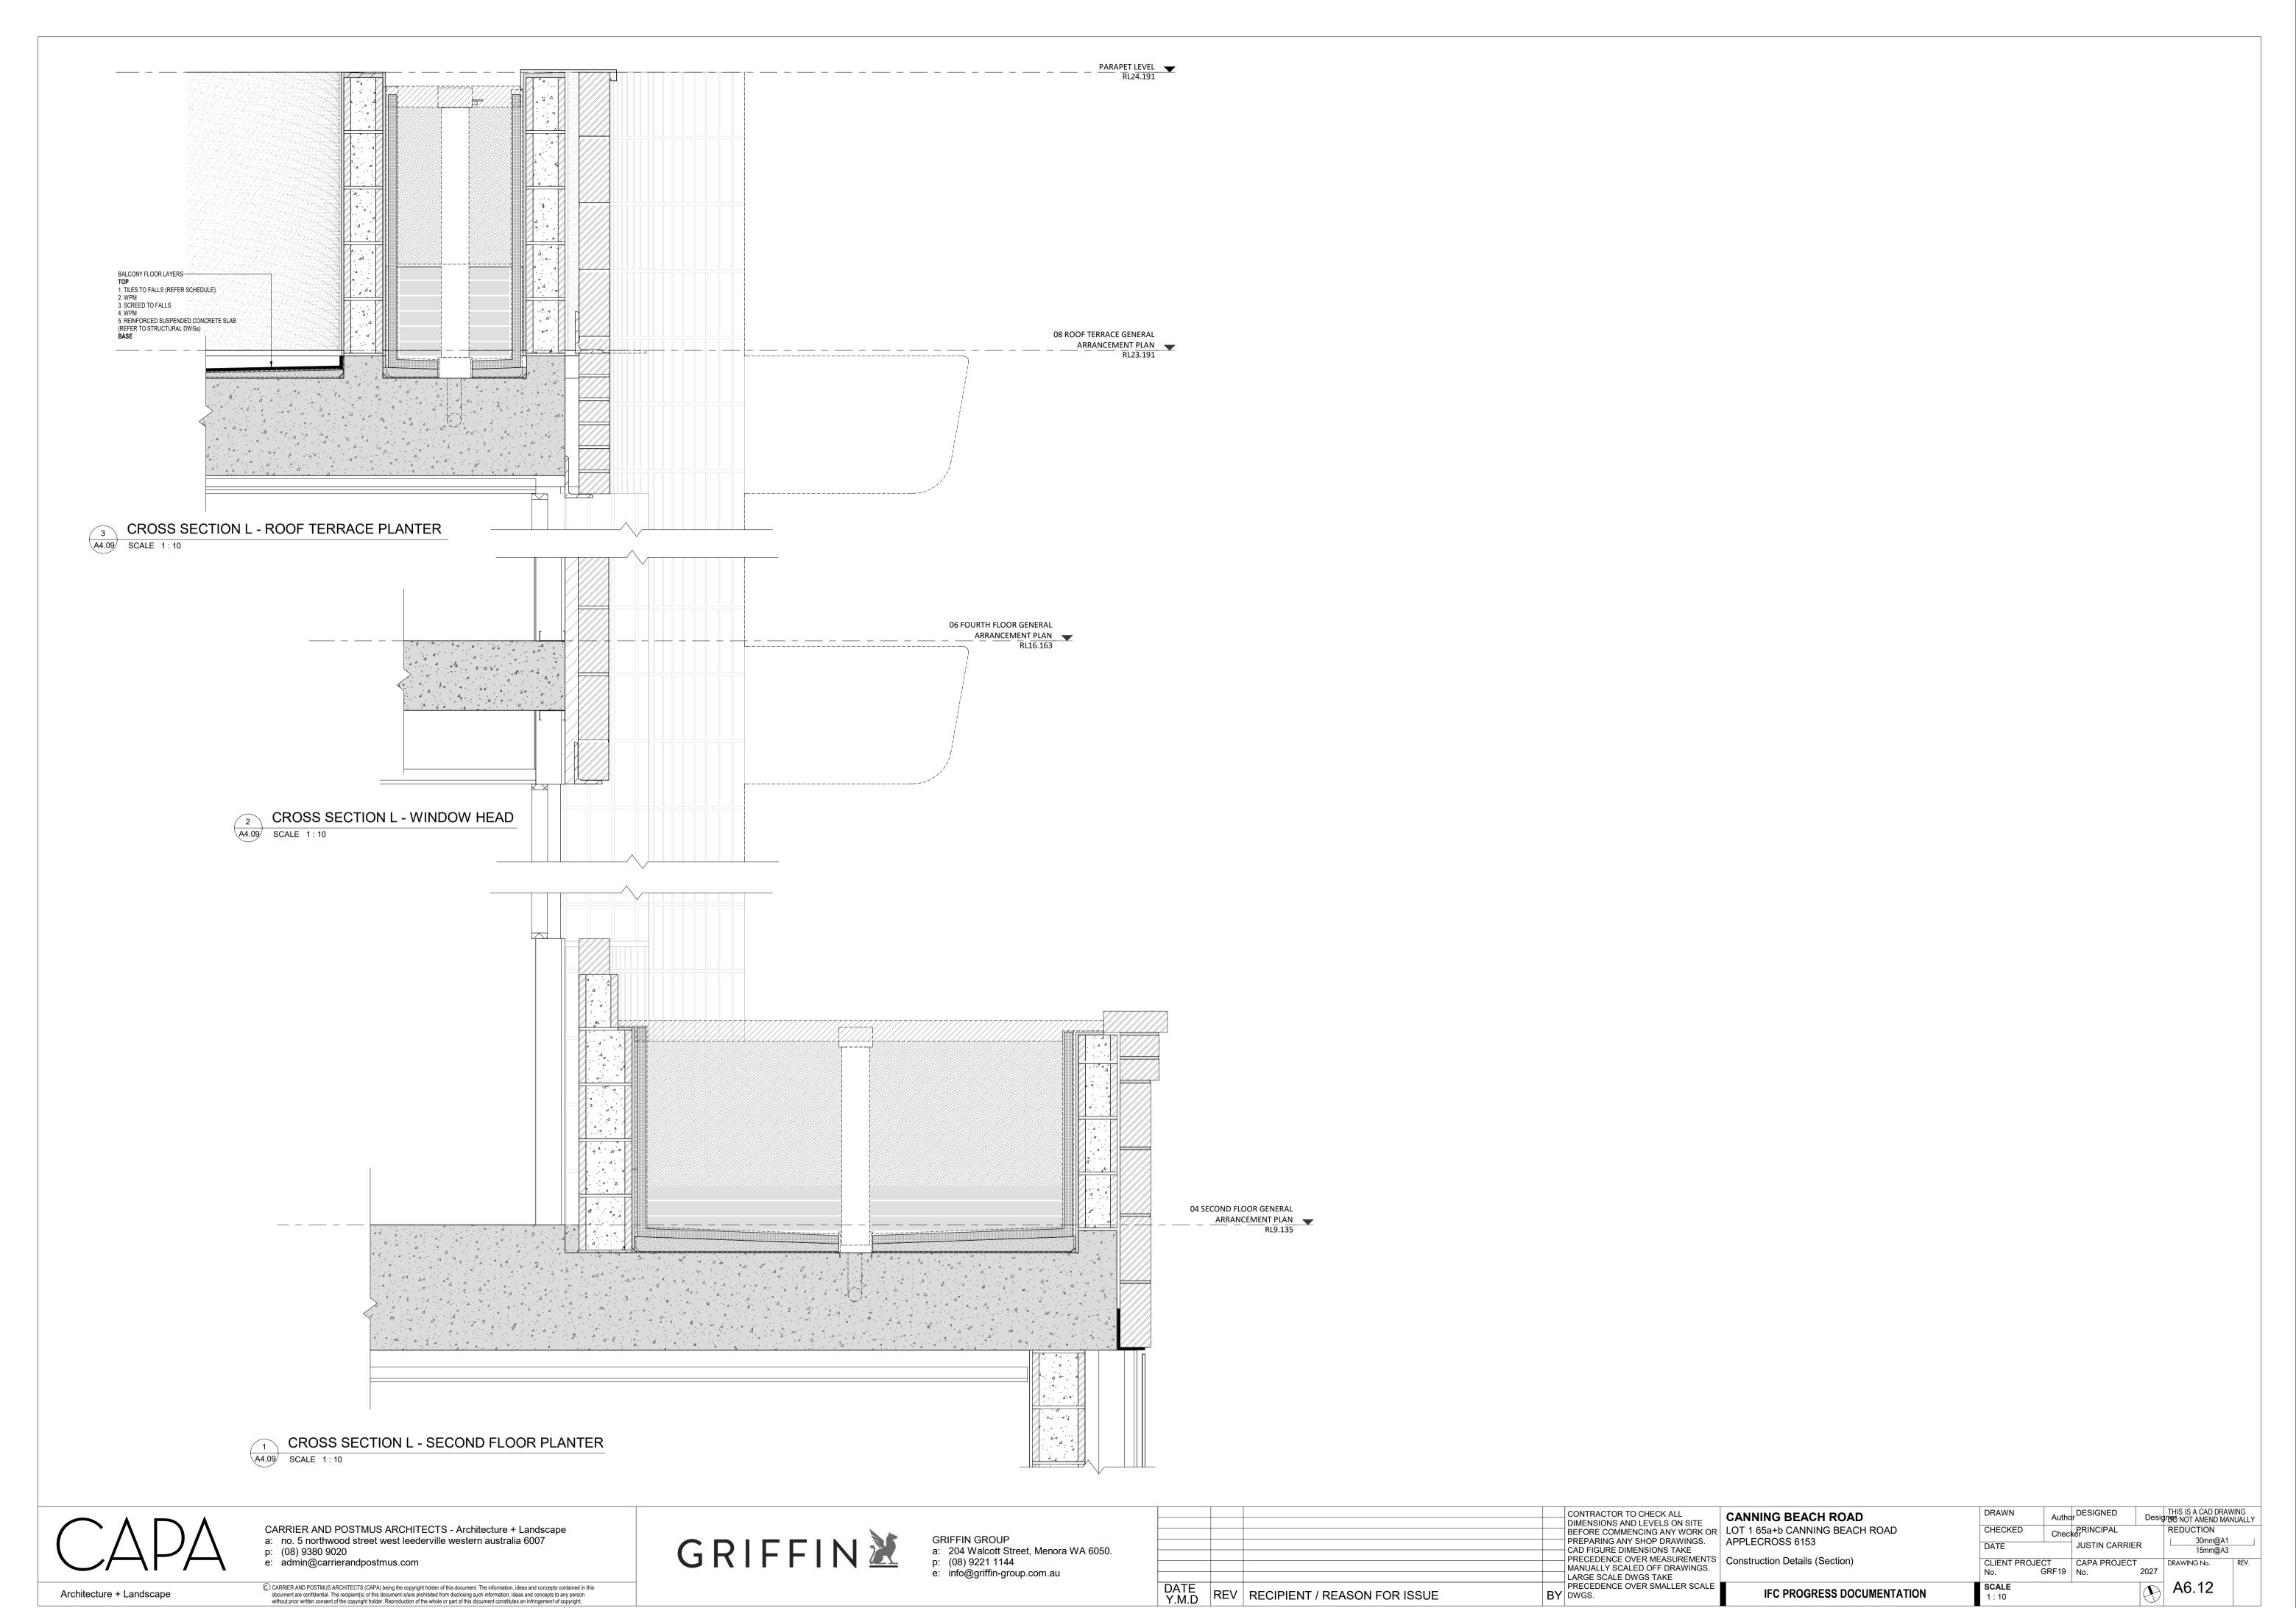
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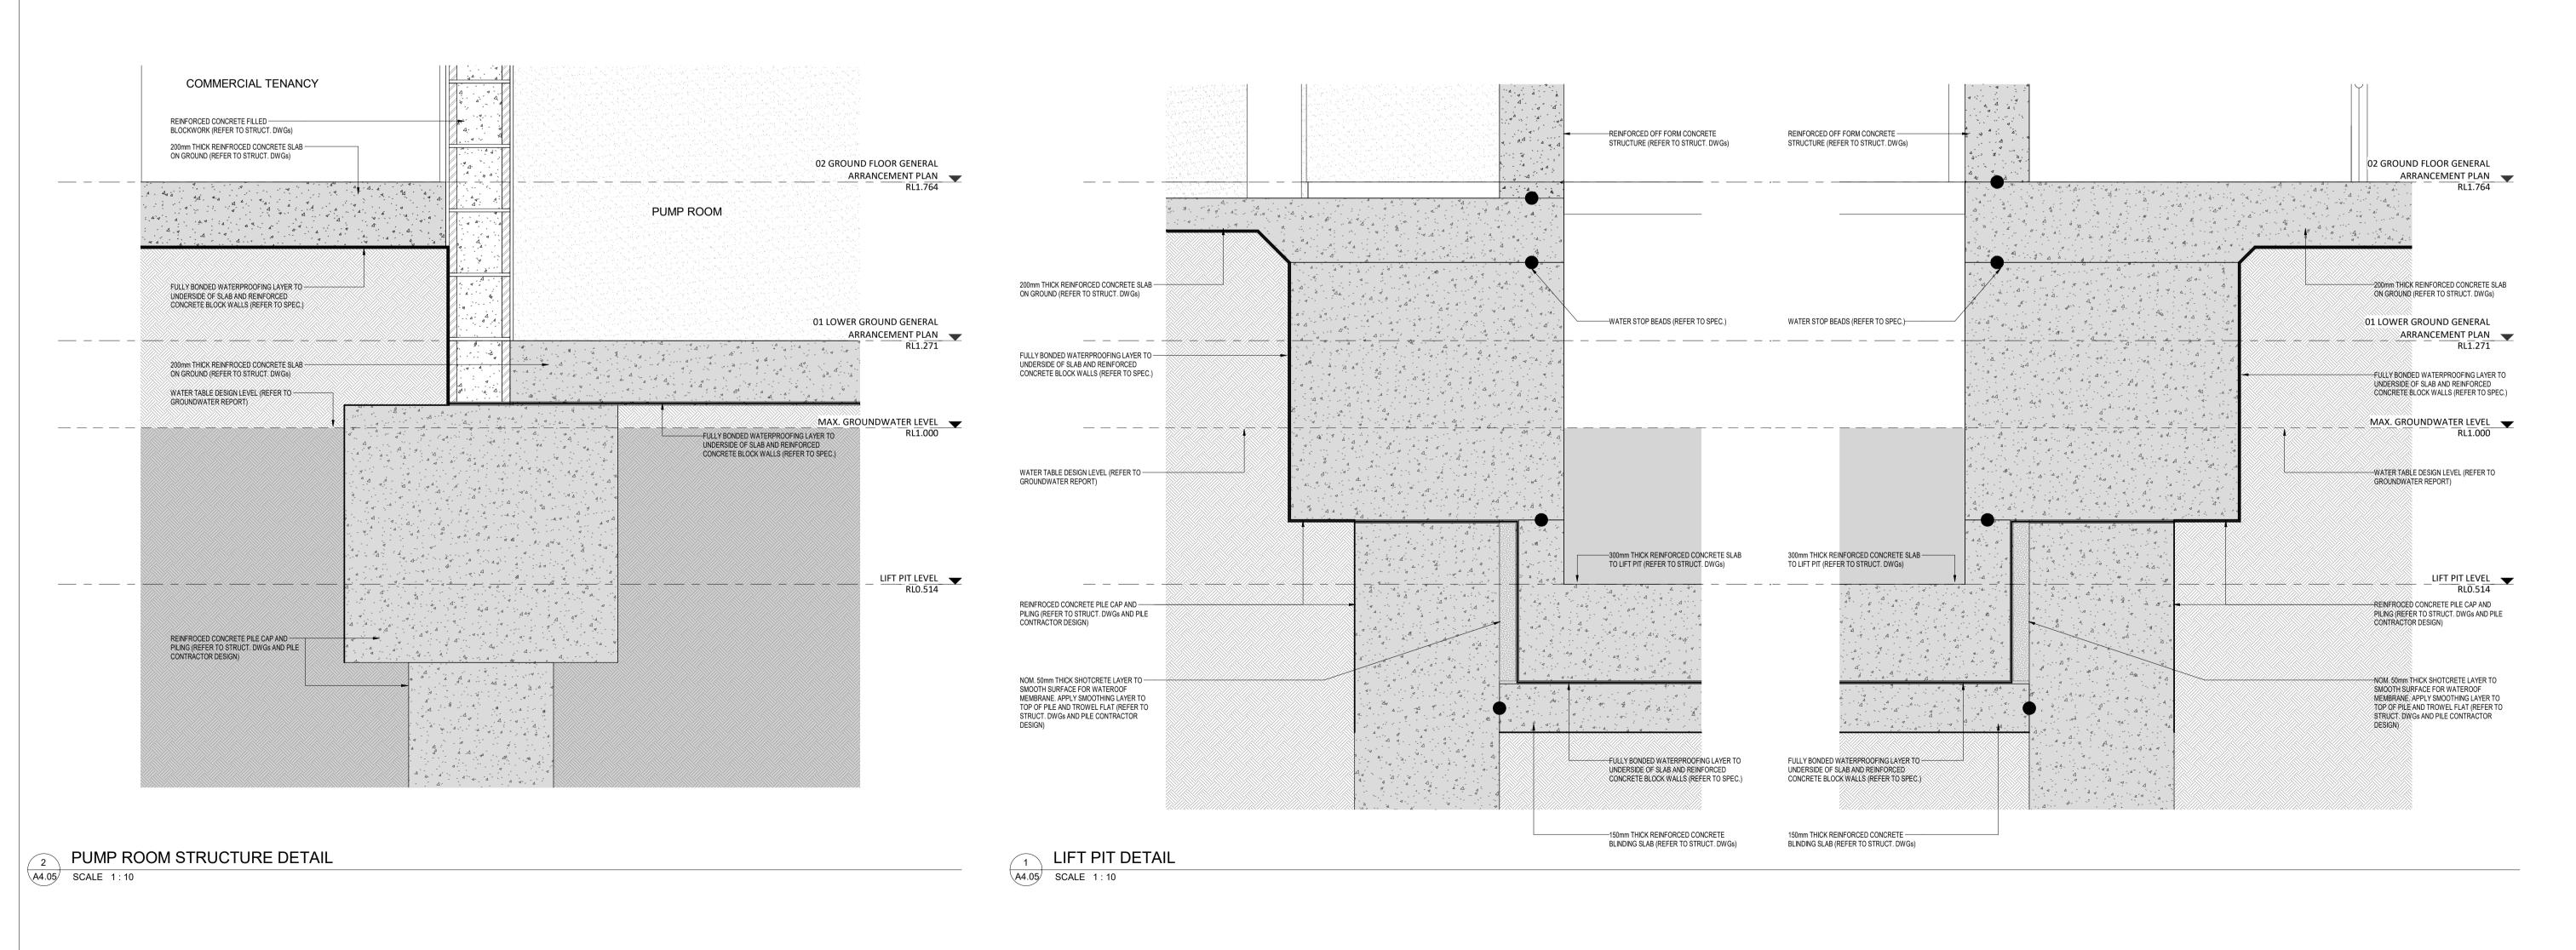






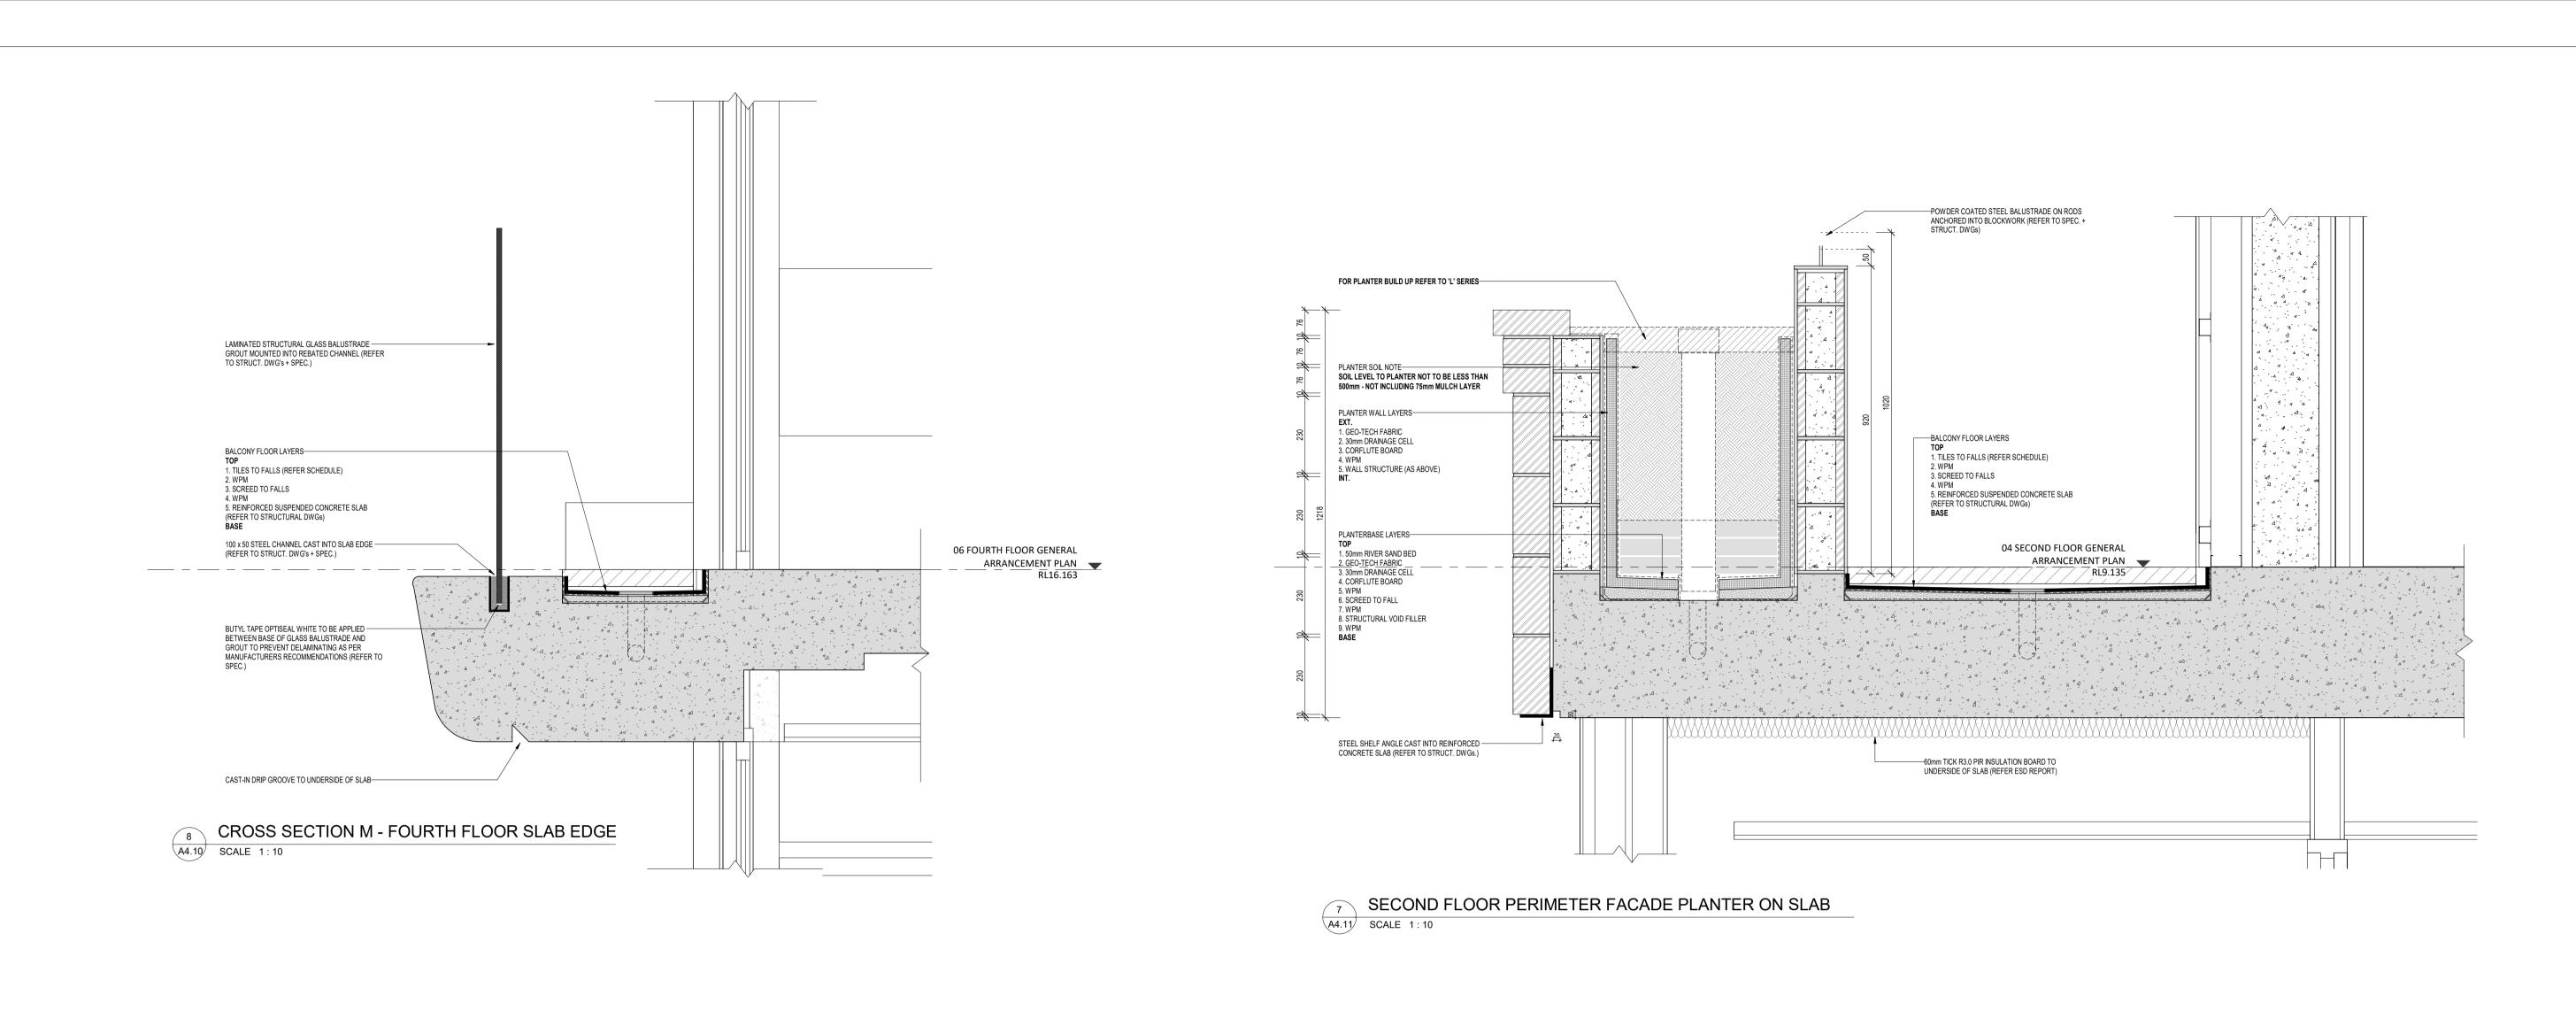

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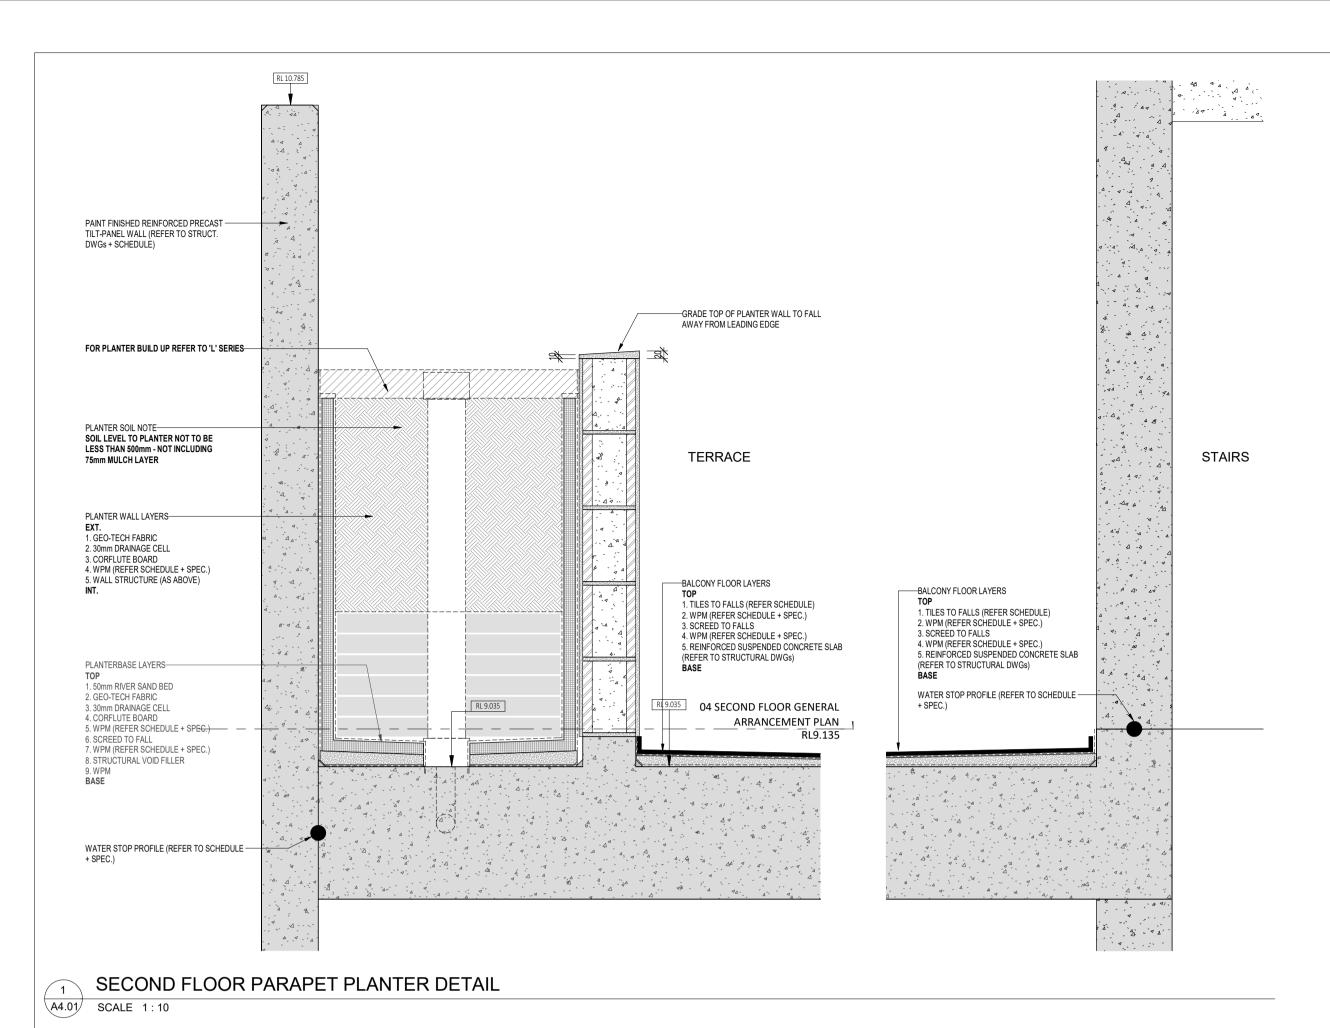
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CANNING BEACH ROAD APPLECROSS 6153 DATE

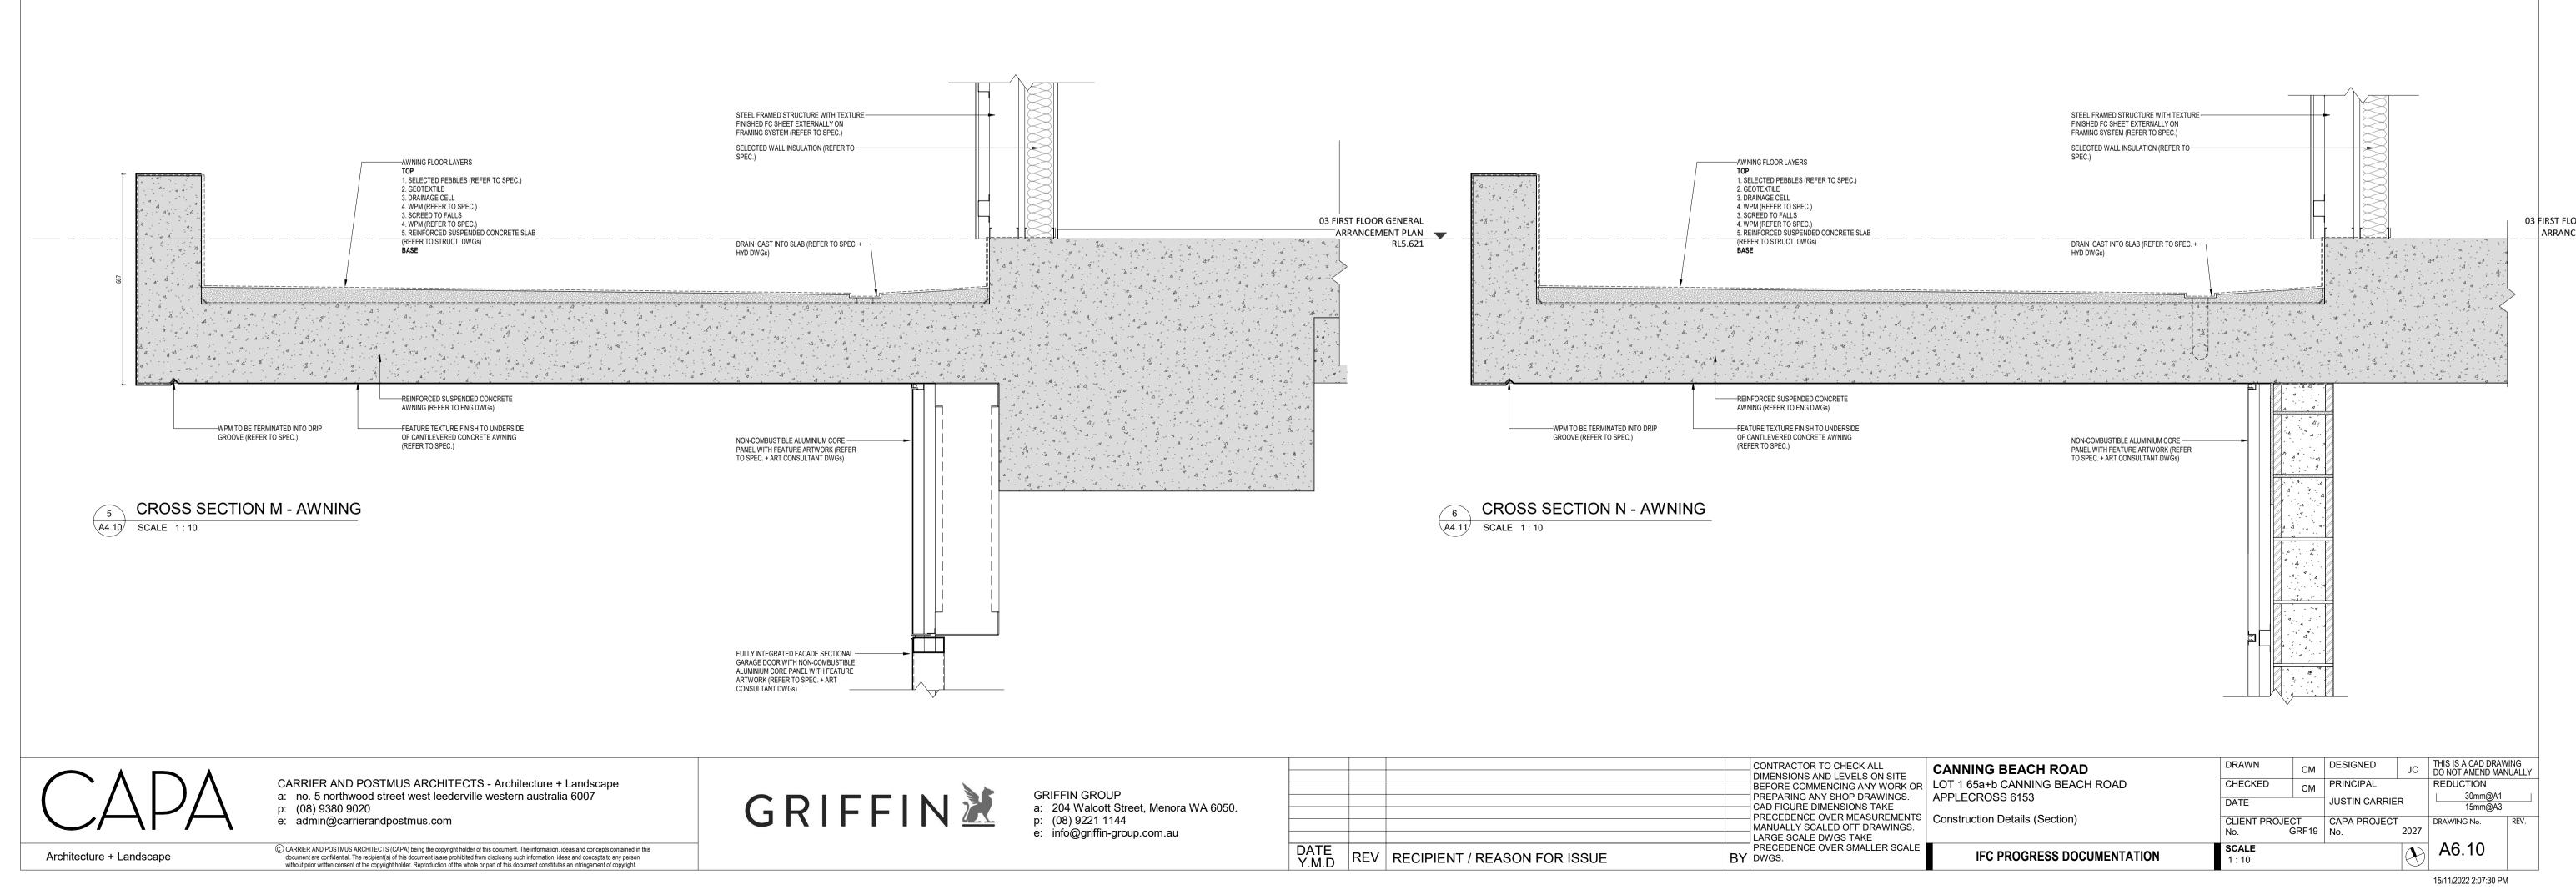Author THIS IS A CAD DRAWING Designed NOT AMEND MANUALLY CHECKED Checker PRINCIPAL REDUCTION 30mm@A1 15mm@A3 JUSTIN CARRIER CLIENT PROJECT CAPA No. GRF19 No. DRAWING No. CAPA PROJECT 2027 A6.13 SCALE IFC PROGRESS DOCUMENTATION

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BASE (REFER TO STRUCT. DWGs) 09 ROOF PLAN REINFORCED SUSPENDED CONCRETE ROOF AND REINFORCED SUSPENDED CONCRETE ROOF AND UPSTAND / DOWNTURN (REFER TO ENG DWGs) . . A- à -WATER STOP PROFILE (REFER TO SCHEDULE --WATER STOP PROFILE (REFER TO SCHEDULE + SPEC.) STAIRS 44. STAIRS

CONCRETE ROOF TO STAIRWELL DETAIL

A4.01 SCALE 1:10

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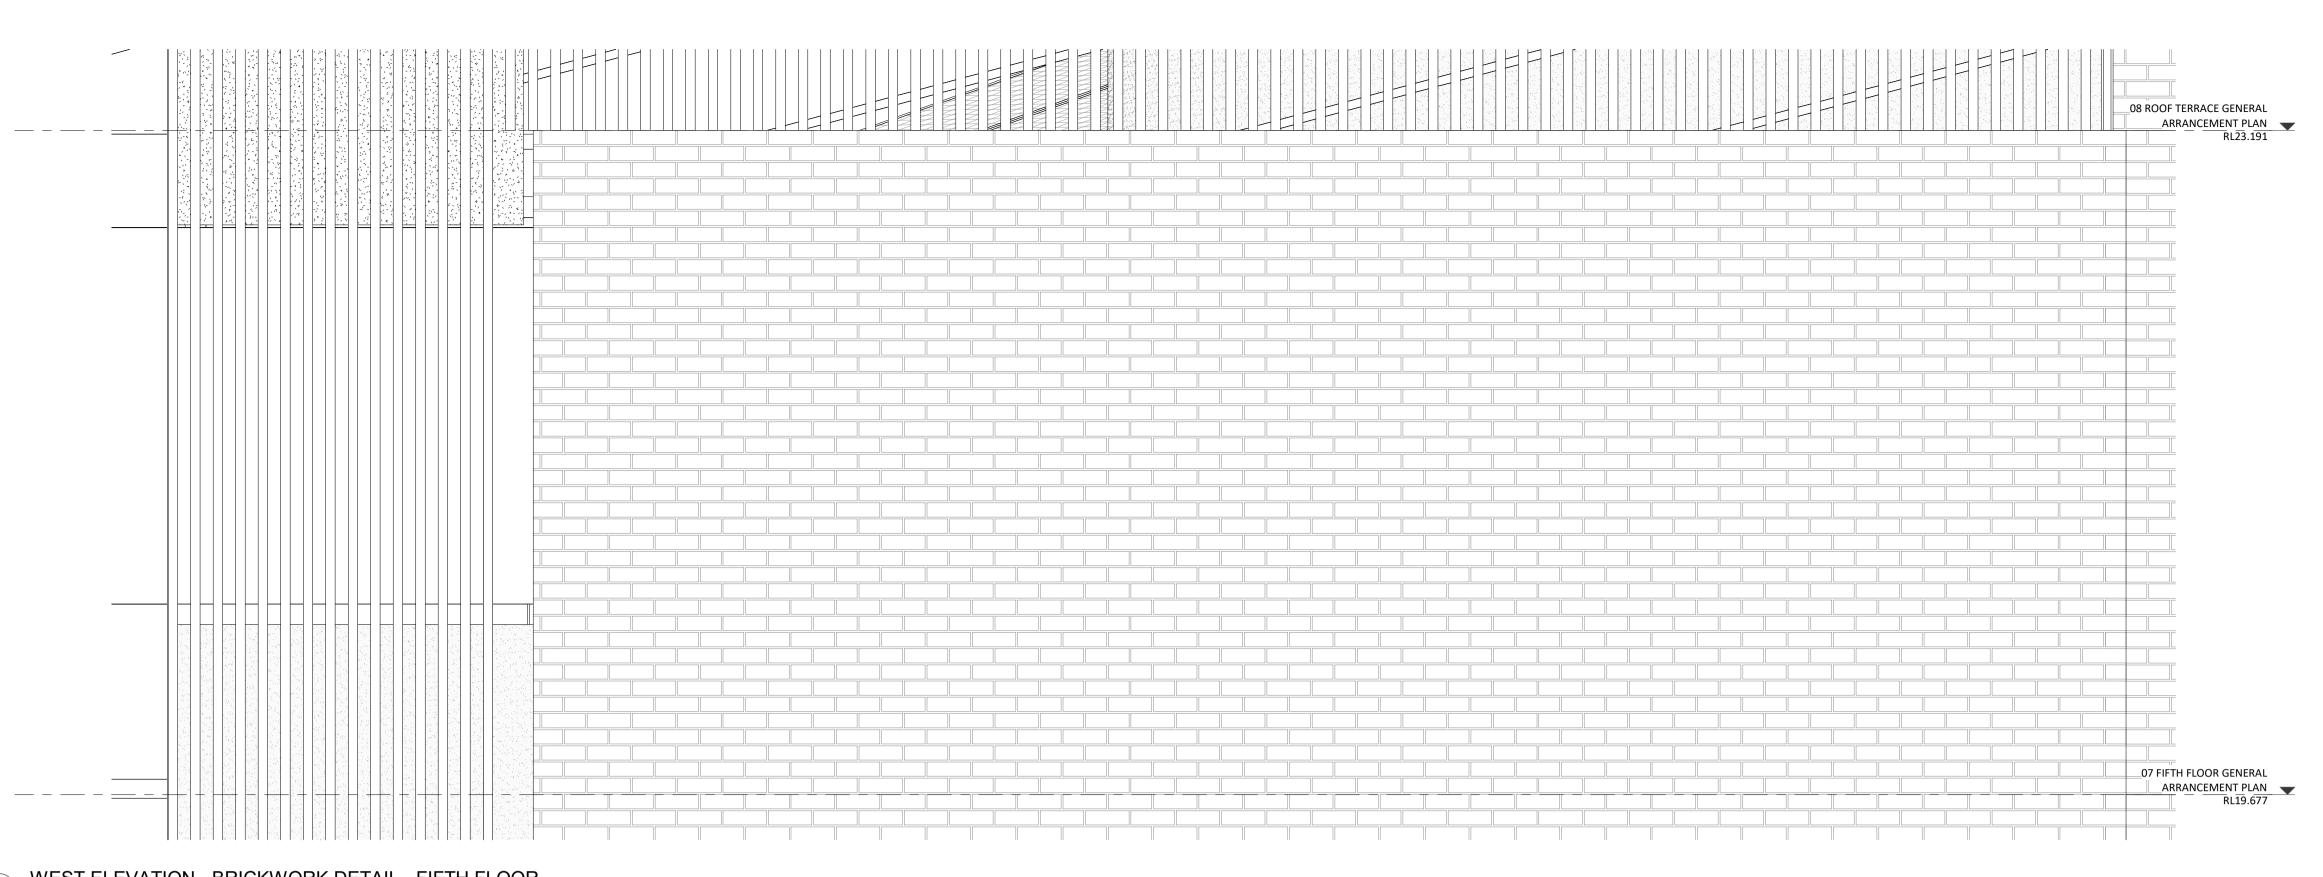
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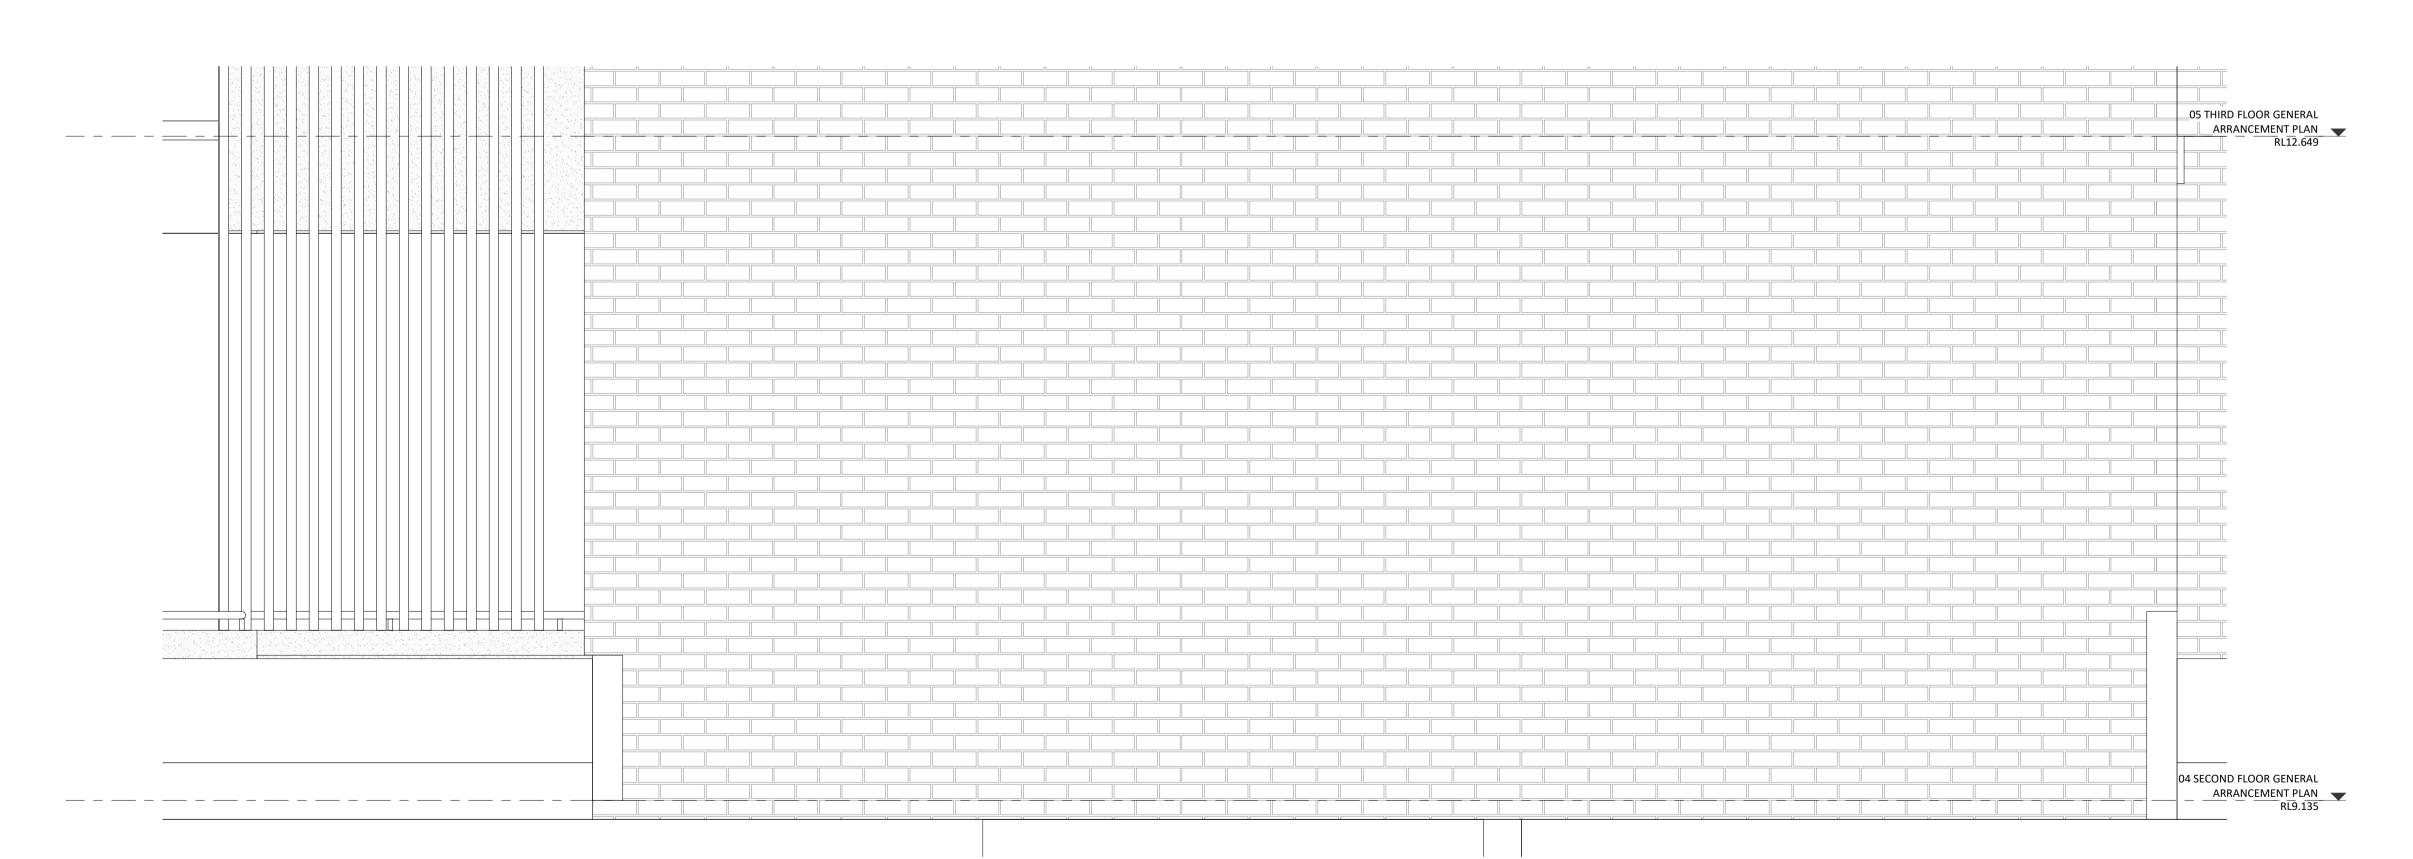
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1 WEST KEY ELEVATION
A2.02 SCALE 1:500

WEST ELEVATION - BRICKWORK DETAIL - FIFTH FLOOR

A3.03 SCALE 1:20



WEST ELEVATION - BRICKWORK DETAIL - SECOND FLOOR

A3.03 SCALE 1:20

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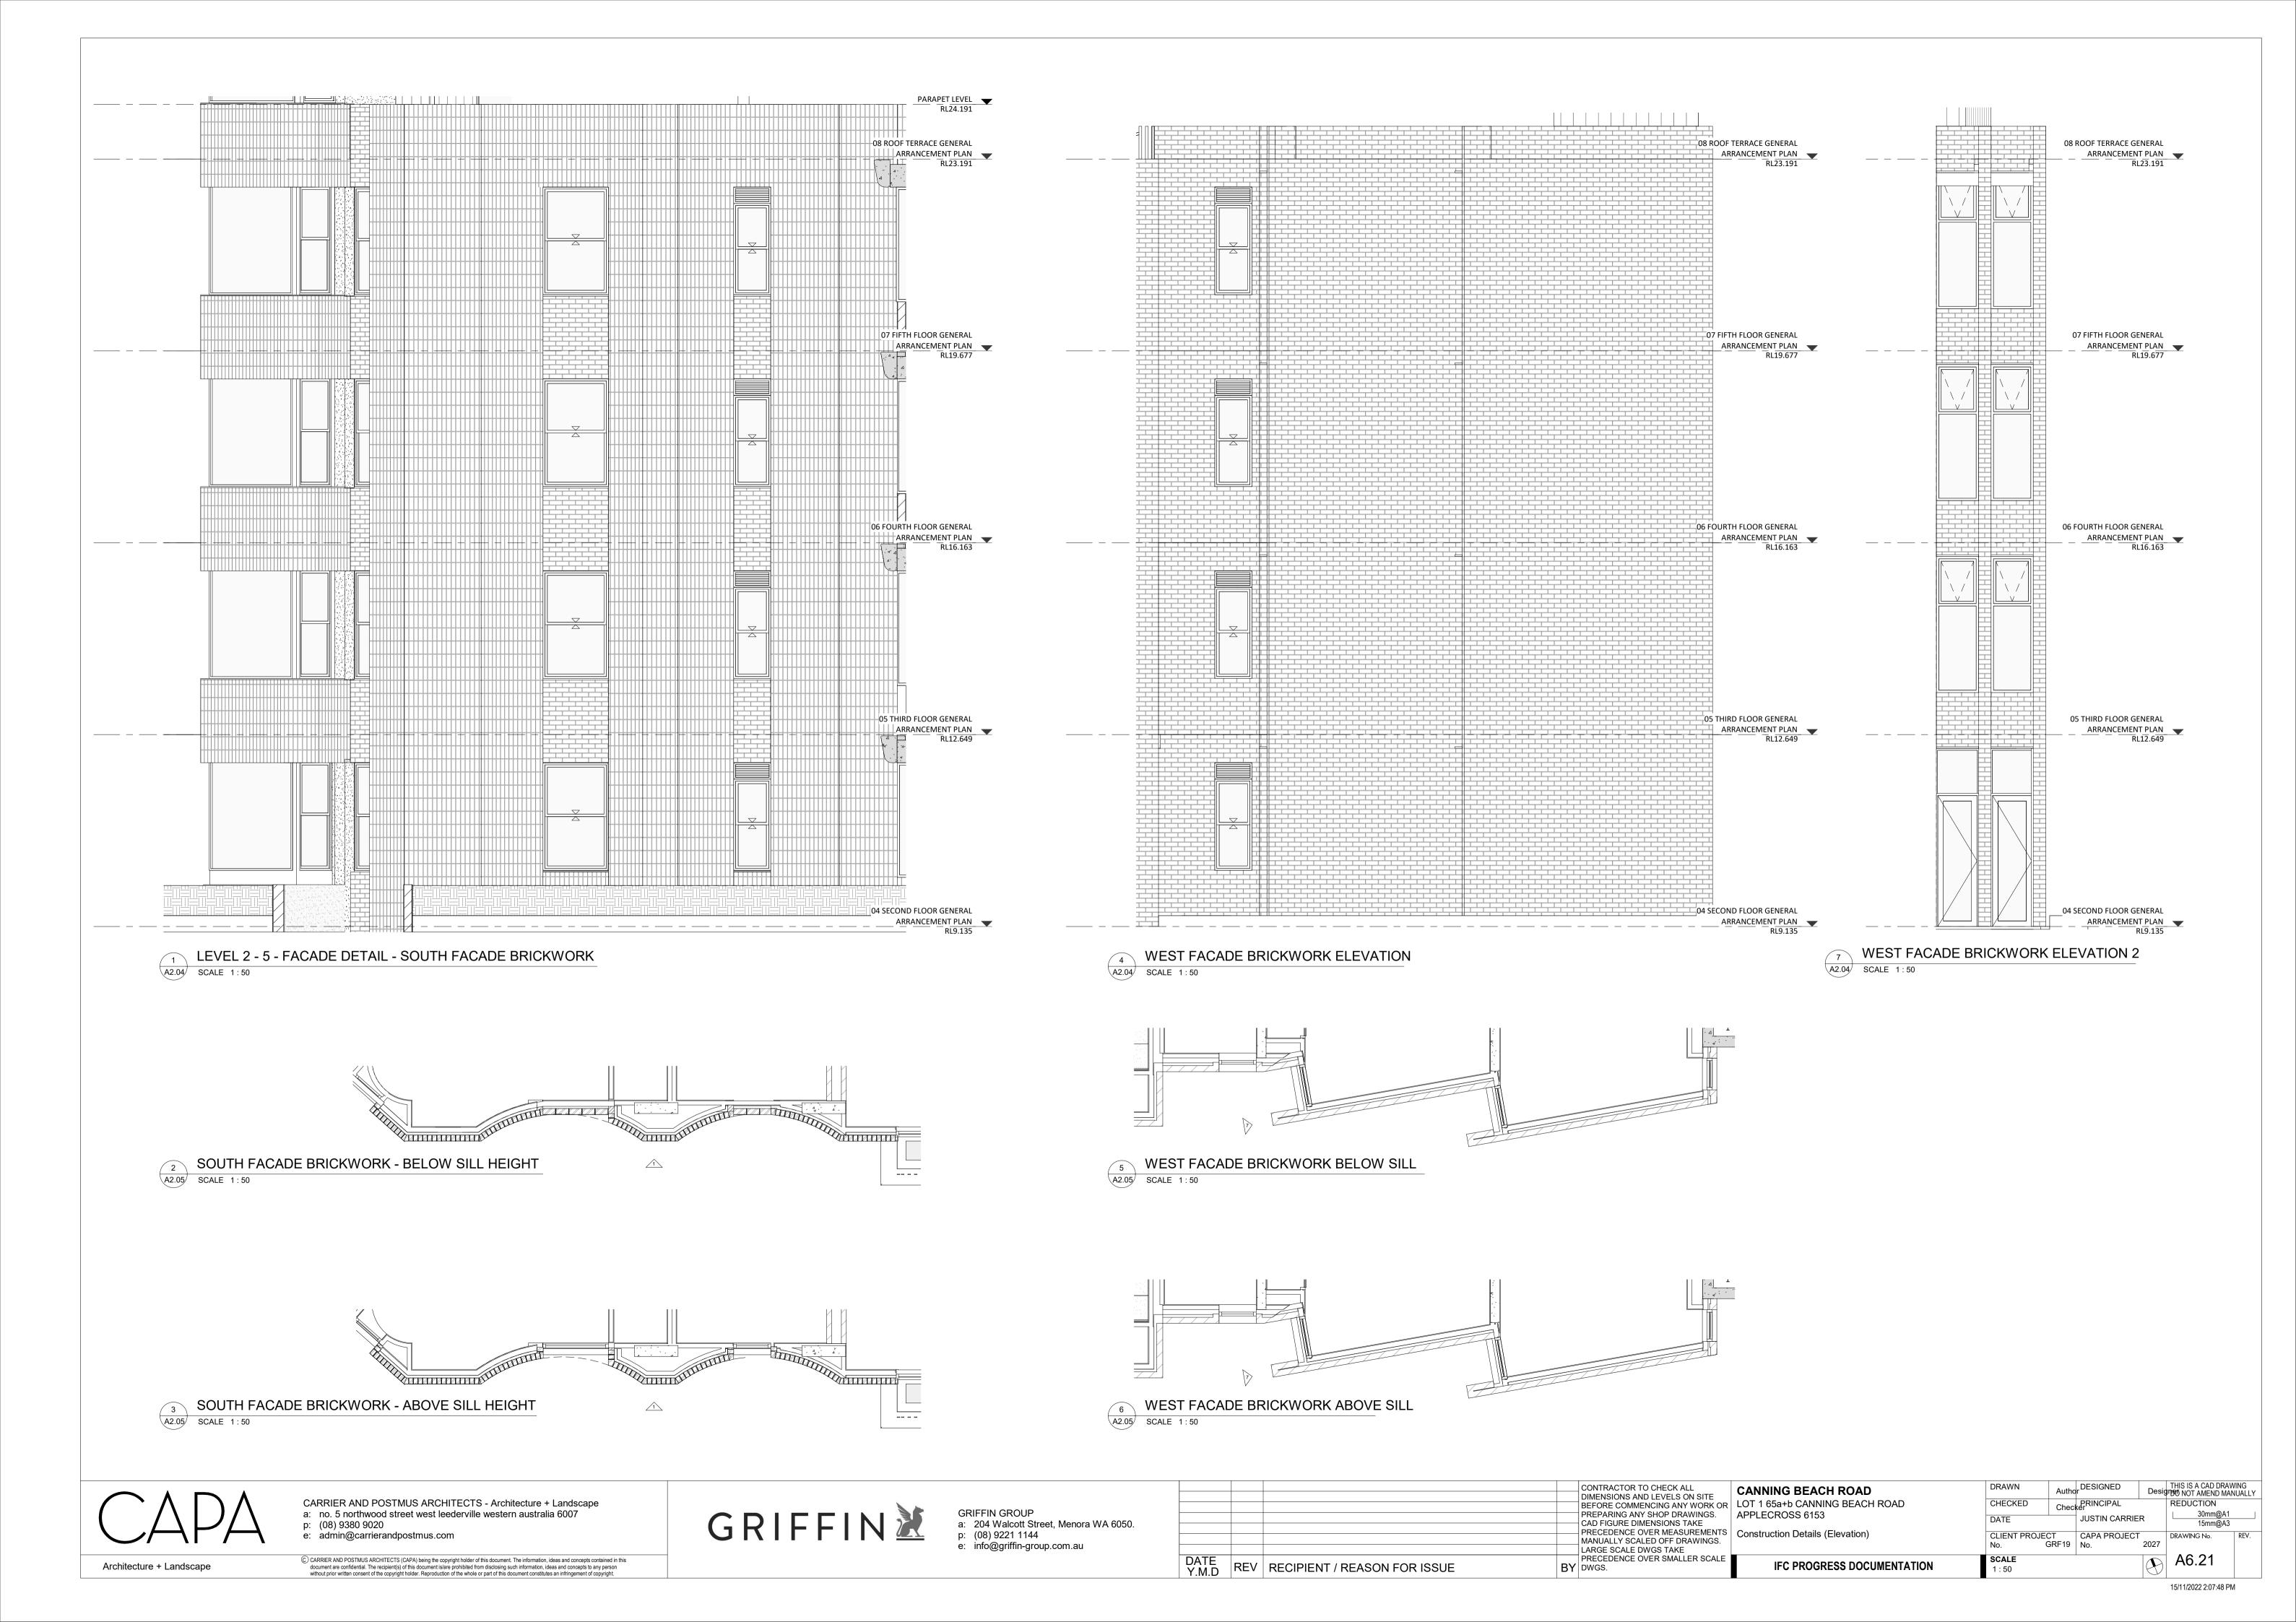
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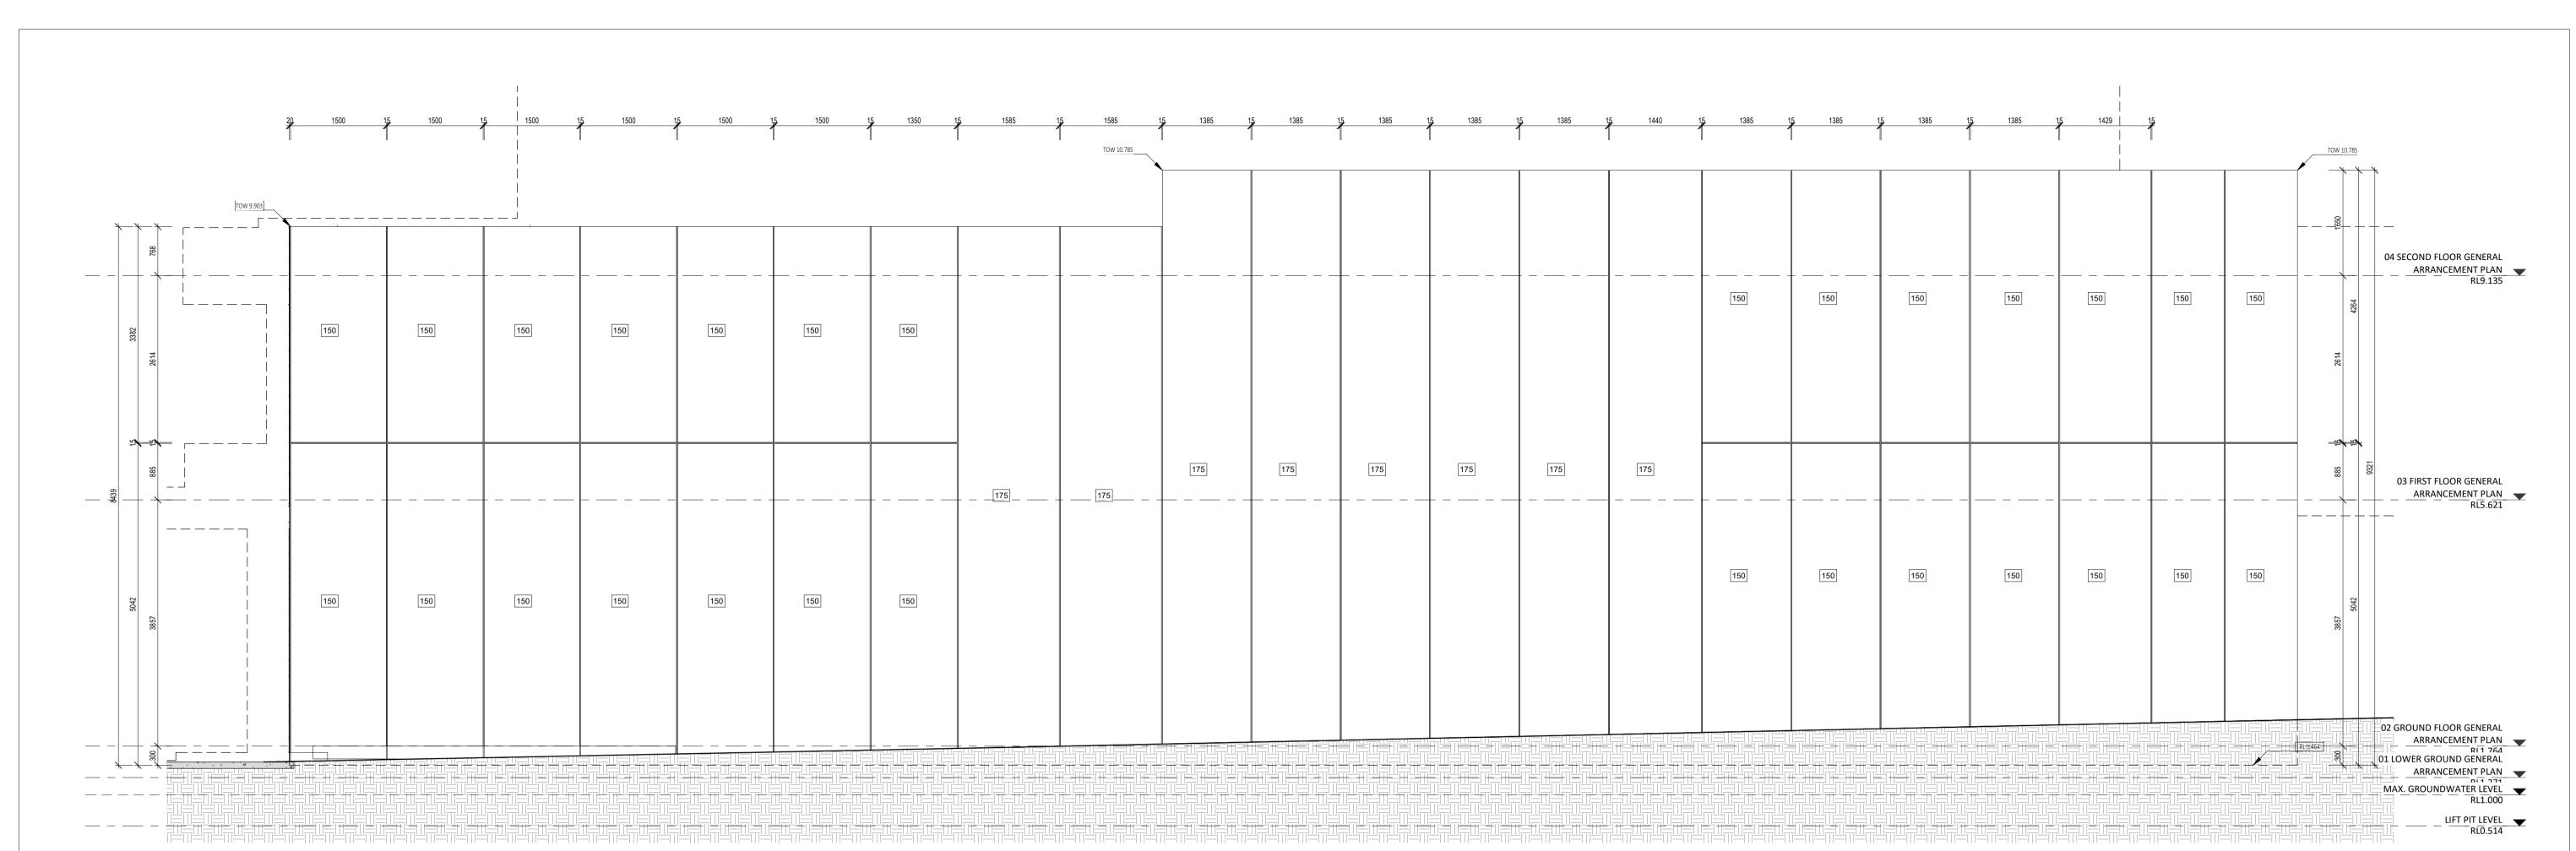


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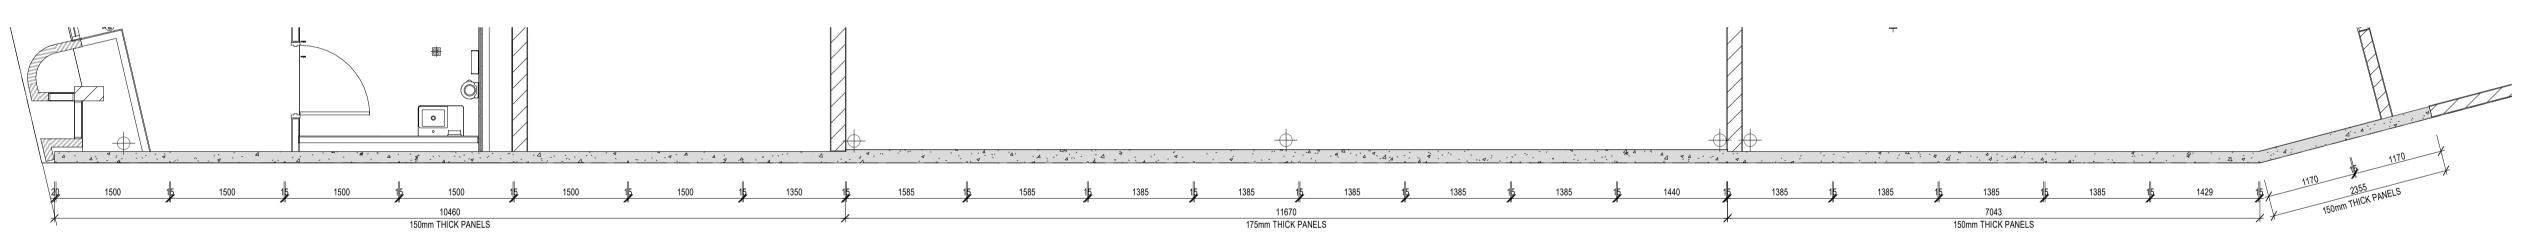
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SCALE As indicated				A6.20	
	CHECKED DATE CLIENT PROJECT No. (C) SCALE	CHECKED Check DATE CLIENT PROJECT No. GRF19 SCALE	CHECKED Checker PRINCIPAL DATE JUSTIN CARRIE CLIENT PROJECT CAPA PROJECT No. GRF19 SCALE	CHECKED Checker PRINCIPAL DATE JUSTIN CARRIER CLIENT PROJECT No. GRF19 CAPA PROJECT No. 2027 SCALE	CHECKED Checker JUSTIN CARRIER REDUCTION DATE JUSTIN CARRIER 30mm@A1 15mm@A3 CLIENT PROJECT No. GRF19 CAPA PROJECT No. 2027 SCALE A6.20





DETAIL ELEVATION - PRECAST WALL

A3.03 SCALE 1:50



PLAN DETAIL PRECAST WALL SCALE 1:50

Architecture + Landscape

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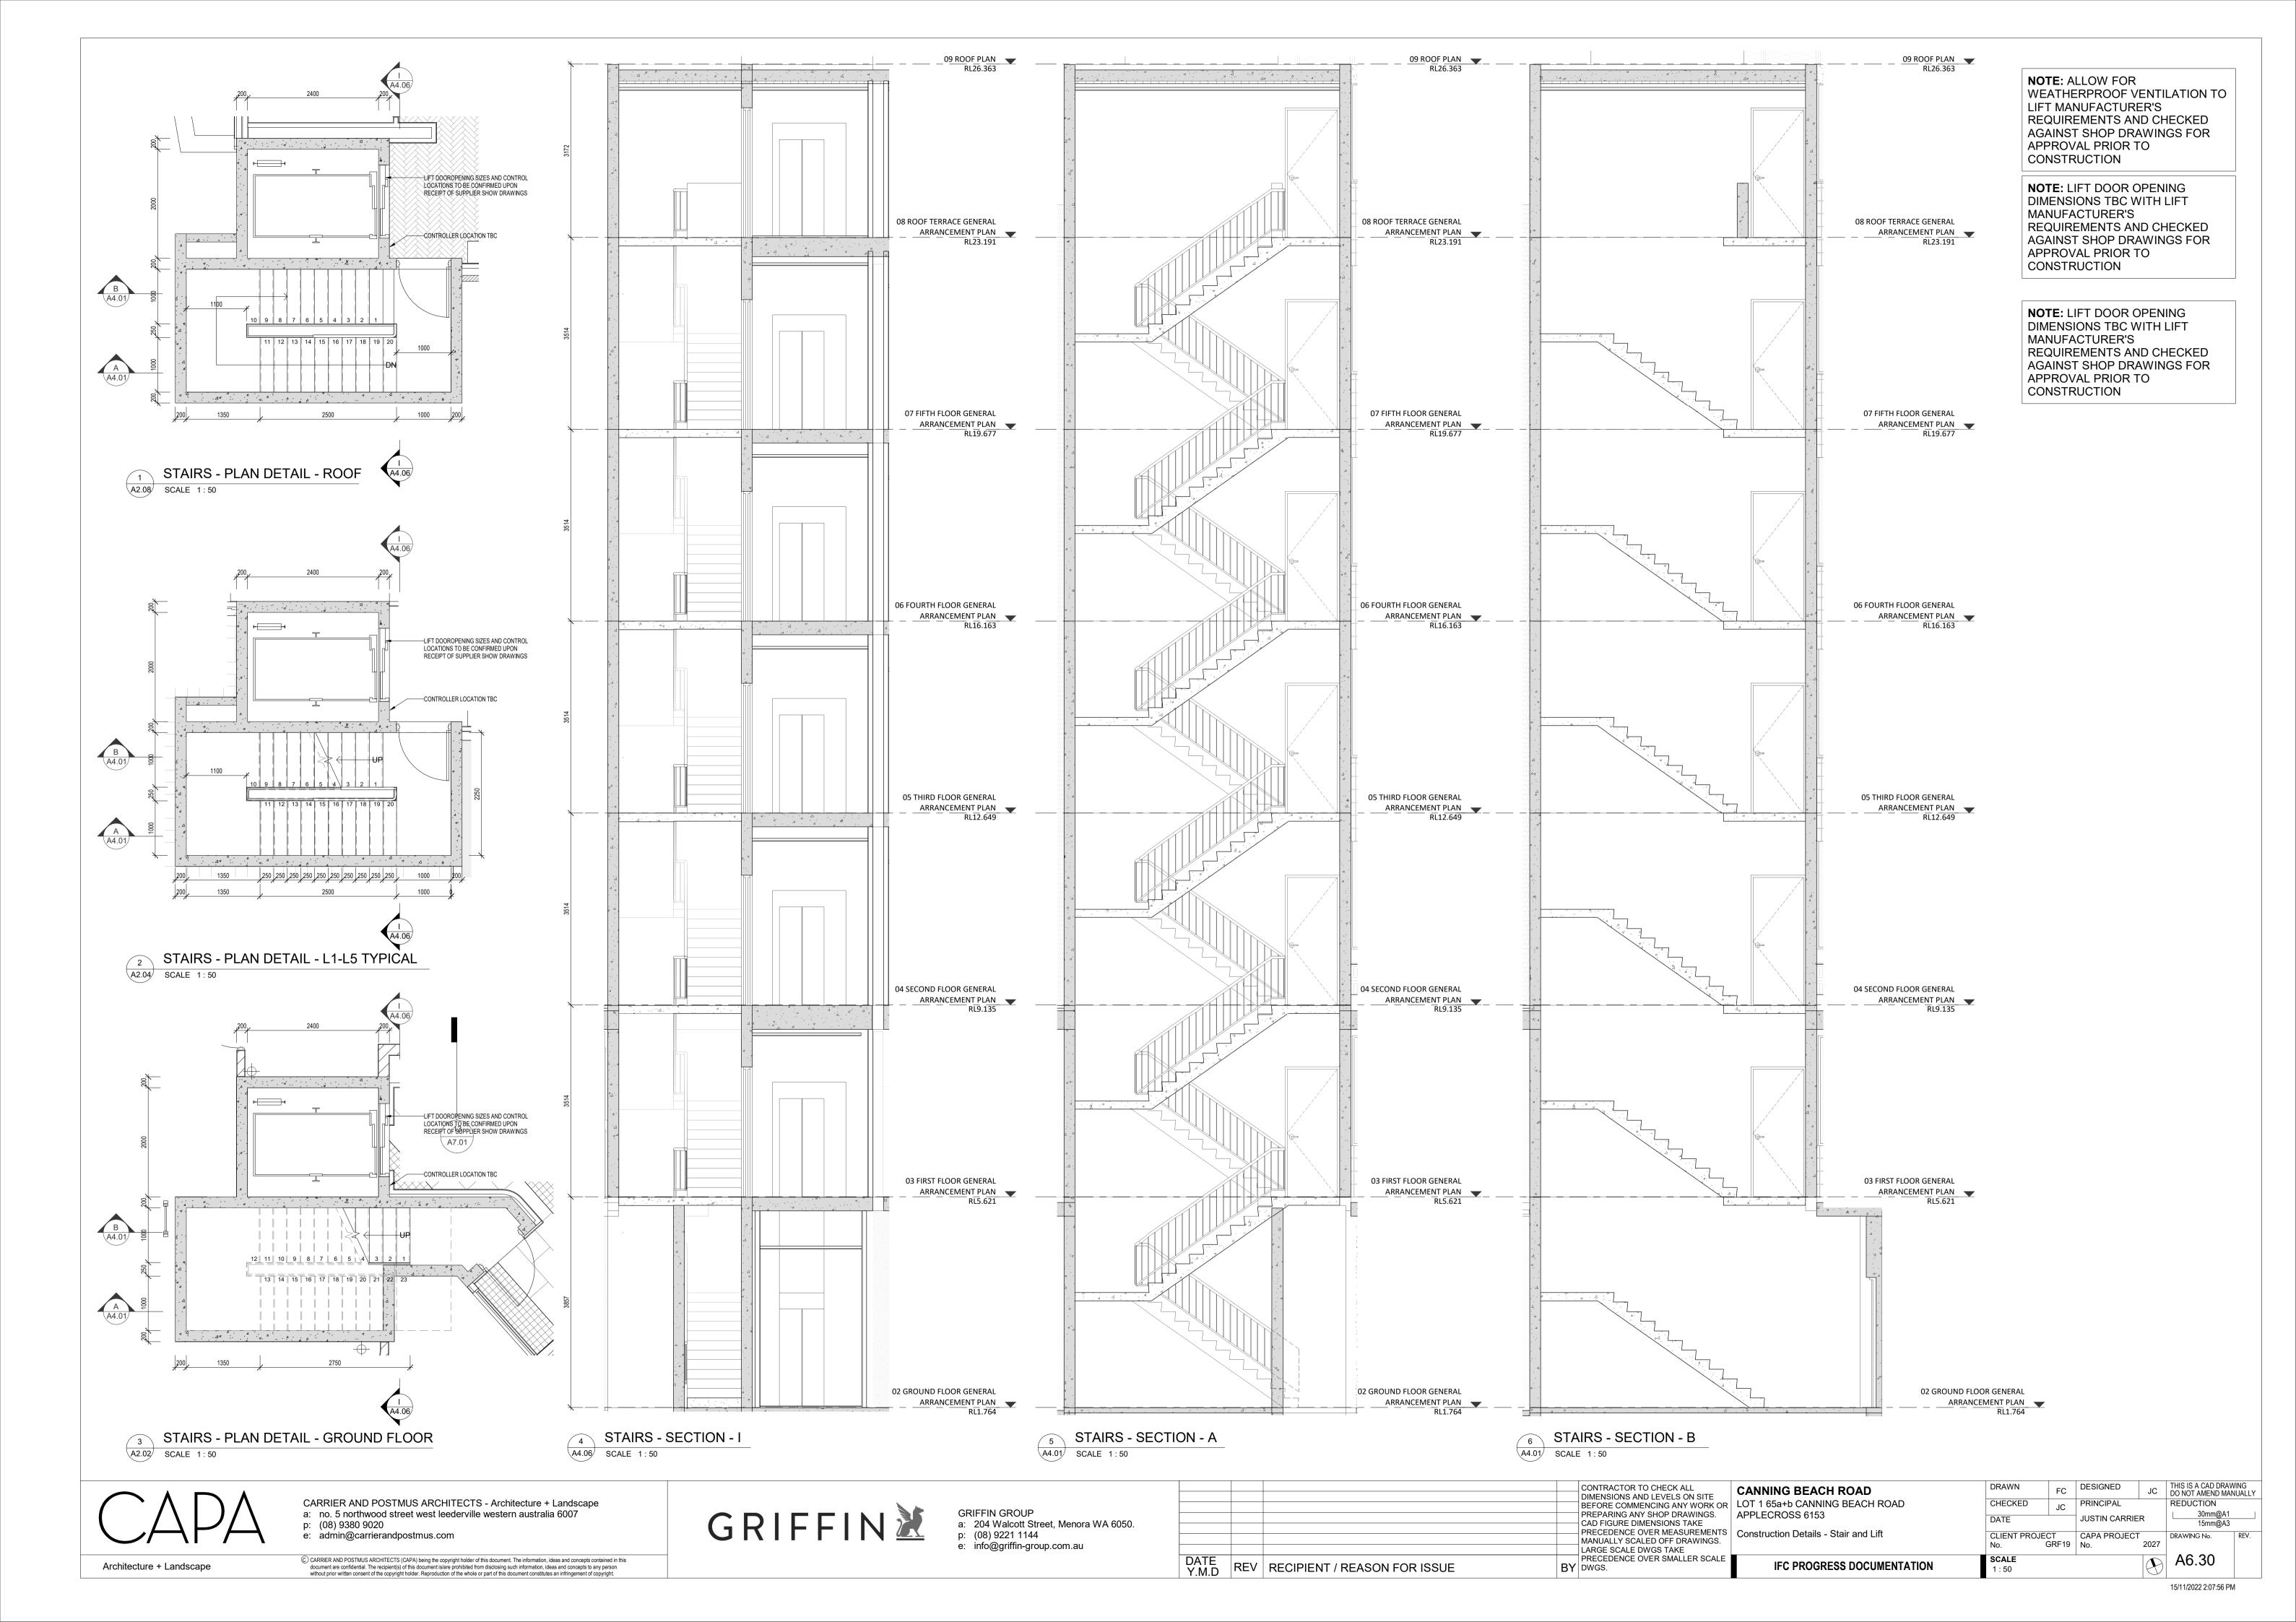
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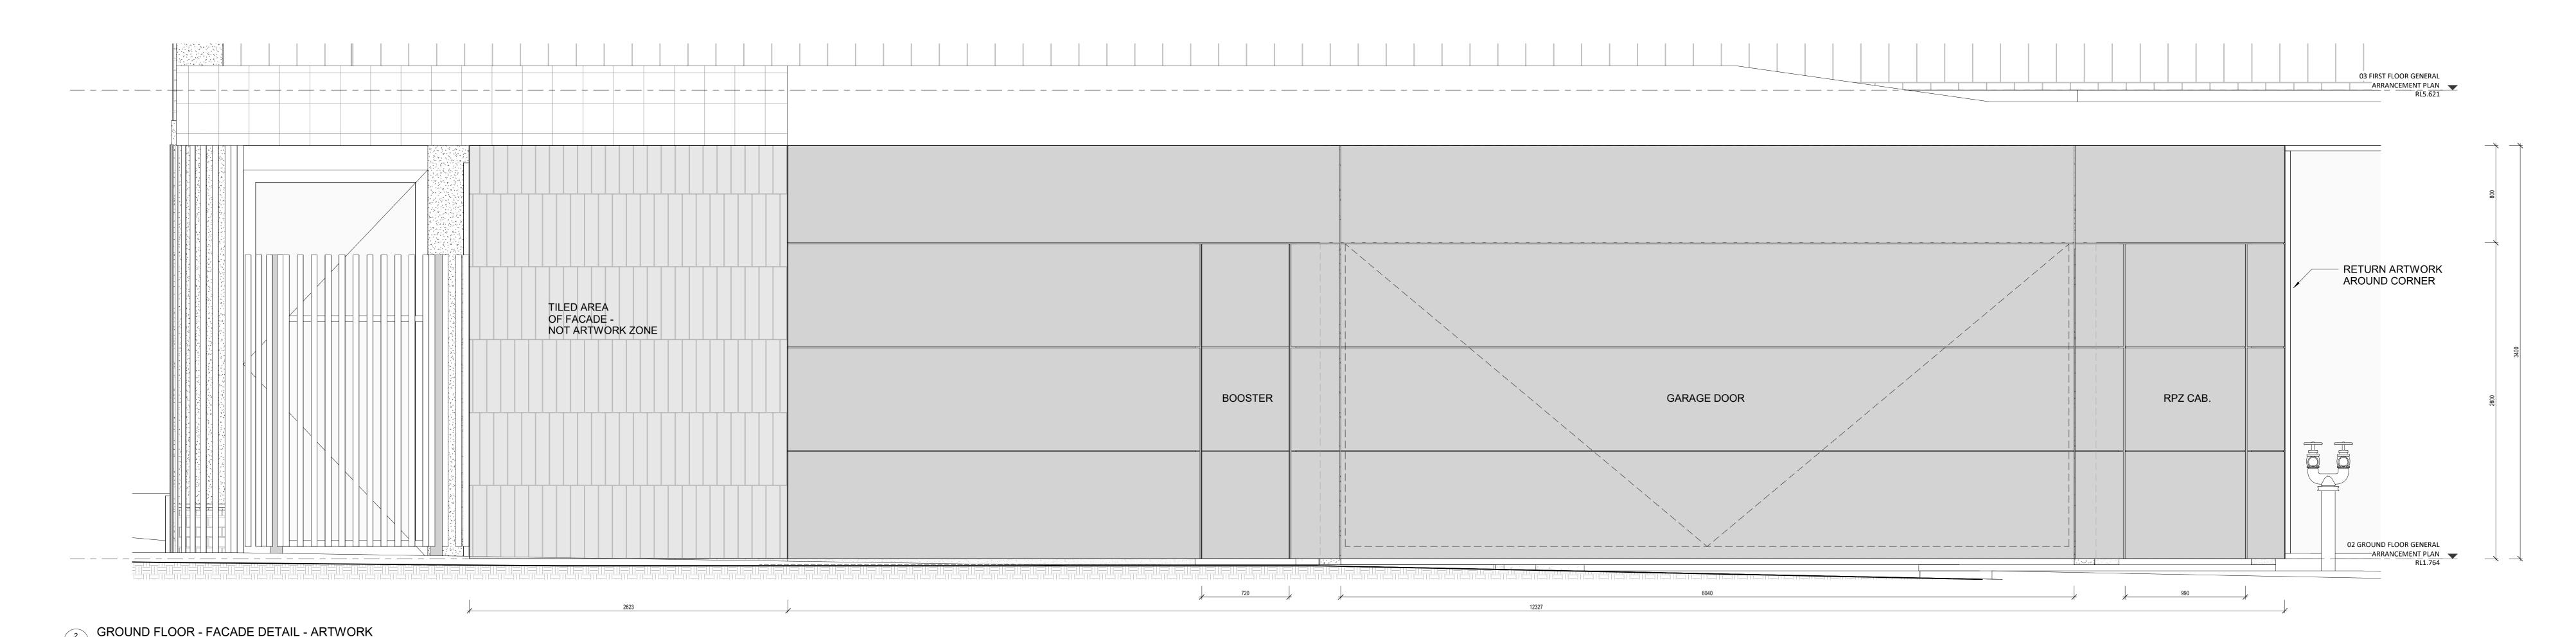
CONTRACTOR TO CHECK ALL DIMENSIONS AND LEVELS ON SITE BEFORE COMMENCING ANY WORK OR LOT 1 65a+b CANNING BEACH ROAD PREPARING ANY SHOP DRAWINGS. APPLECROSS 6153 CAD FIGURE DIMENSIONS TAKE PRECEDENCE OVER MEASUREMENTS | Construction Details (Elevation) - Precast Wall MANUALLY SCALED OFF DRAWINGS. LARGE SCALE DWGS TAKE DATE Y.M.D REV RECIPIENT / REASON FOR ISSUE PRECEDENCE OVER SMALLER SCALE BY DWGS.

CANNING BEACH ROAD

IFC PROGRESS DOCUMENTATION

THIS IS A CAD DRAWING Designed NOT AMEND MANUALLY Author DESIGNED CHECKED Checker REDUCTION DATE JUSTIN CARRIER CLIENT PROJECT CAPA PROJECT No. GRF19 No. 2 DRAWING No. 2027 No. **SCALE** 1:50 A6.22





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CONTRACTOR TO CHECK
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PREPARING ANY SHOP DRAWINGS.
CAD FIGURE DIMENSIONS TAKE
PRECEDENCE OVER MEASUREMENTS
MANUALLY SCALED OFF DRAWINGS.
LARGE SCALE DWGS TAKE
PRECEDENCE OVER SMALLER SCALE
DWGS.

CANNING BEACH ROAD
LOT 1 65a+b CANNING BEACH ROAD
APPLECROSS 6153
Construction Details (Elevation) - Artwork

DRAWN
Author

CHECKED
Checker

DATE

CLIENT PROJECT
No.

GRF19

SCALE
1:20


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REDUCTION
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1:100@A2


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REV.


A6.34


15/11/2022 2:07:58 PM



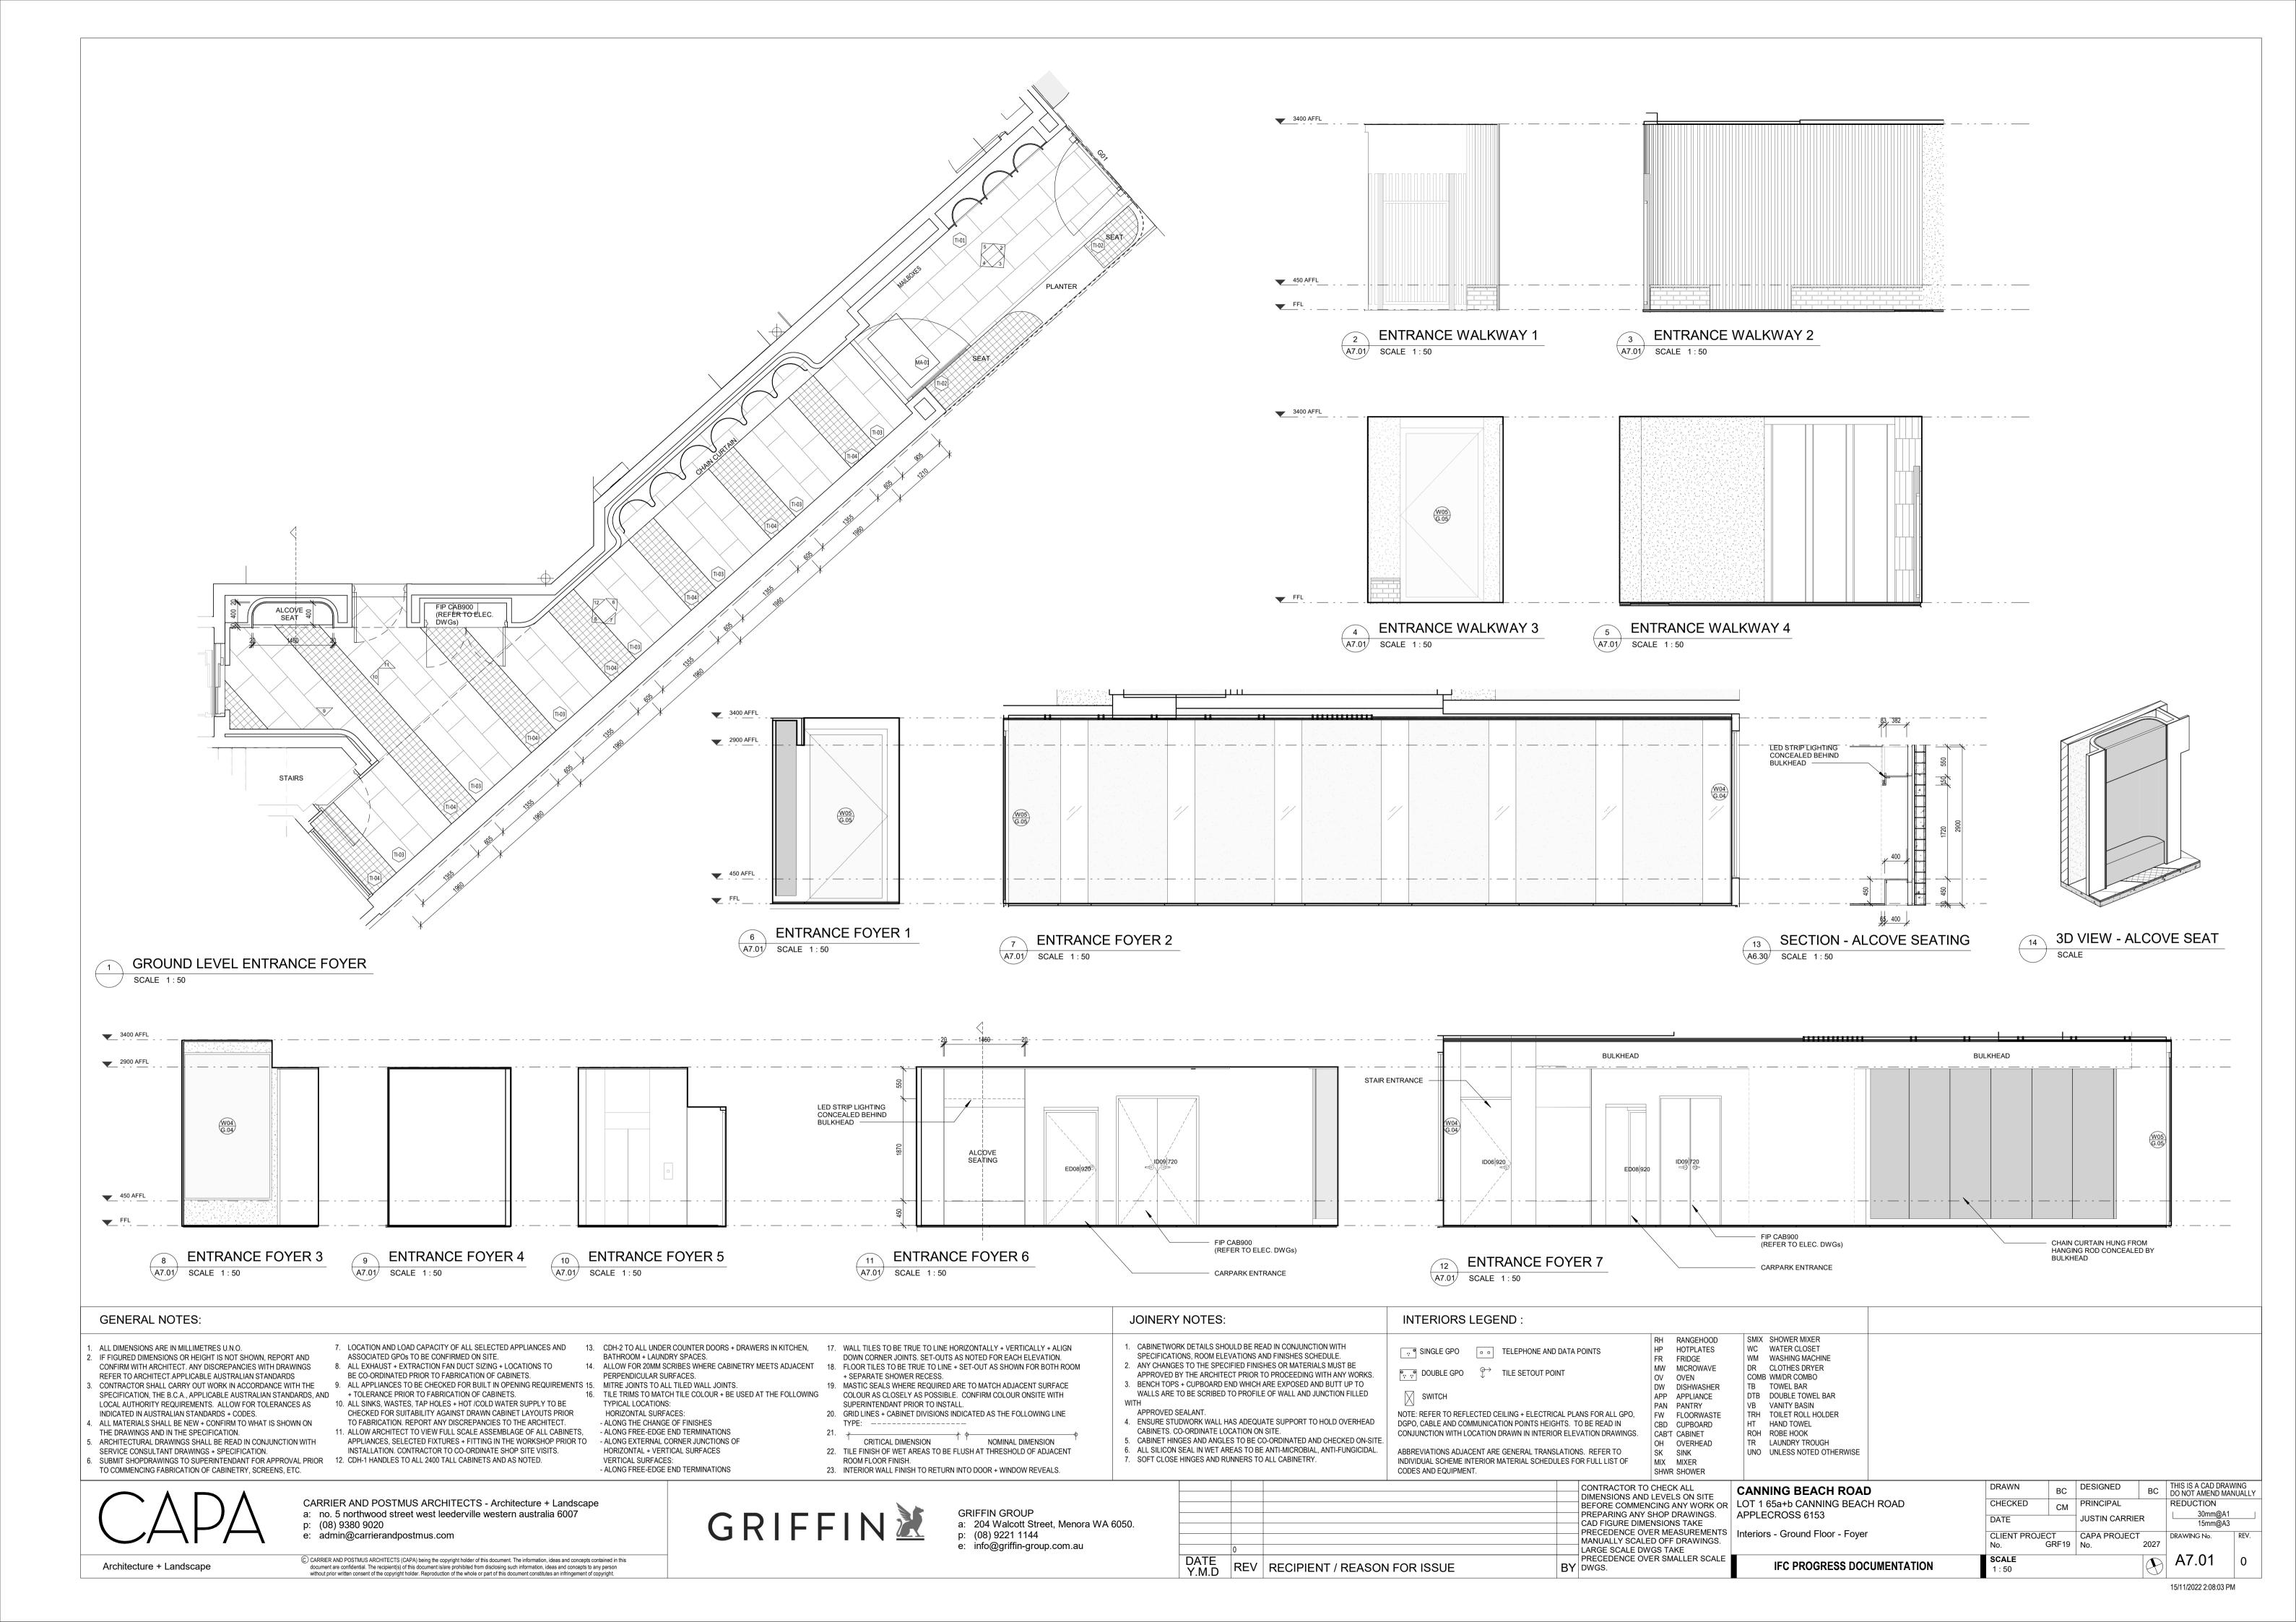

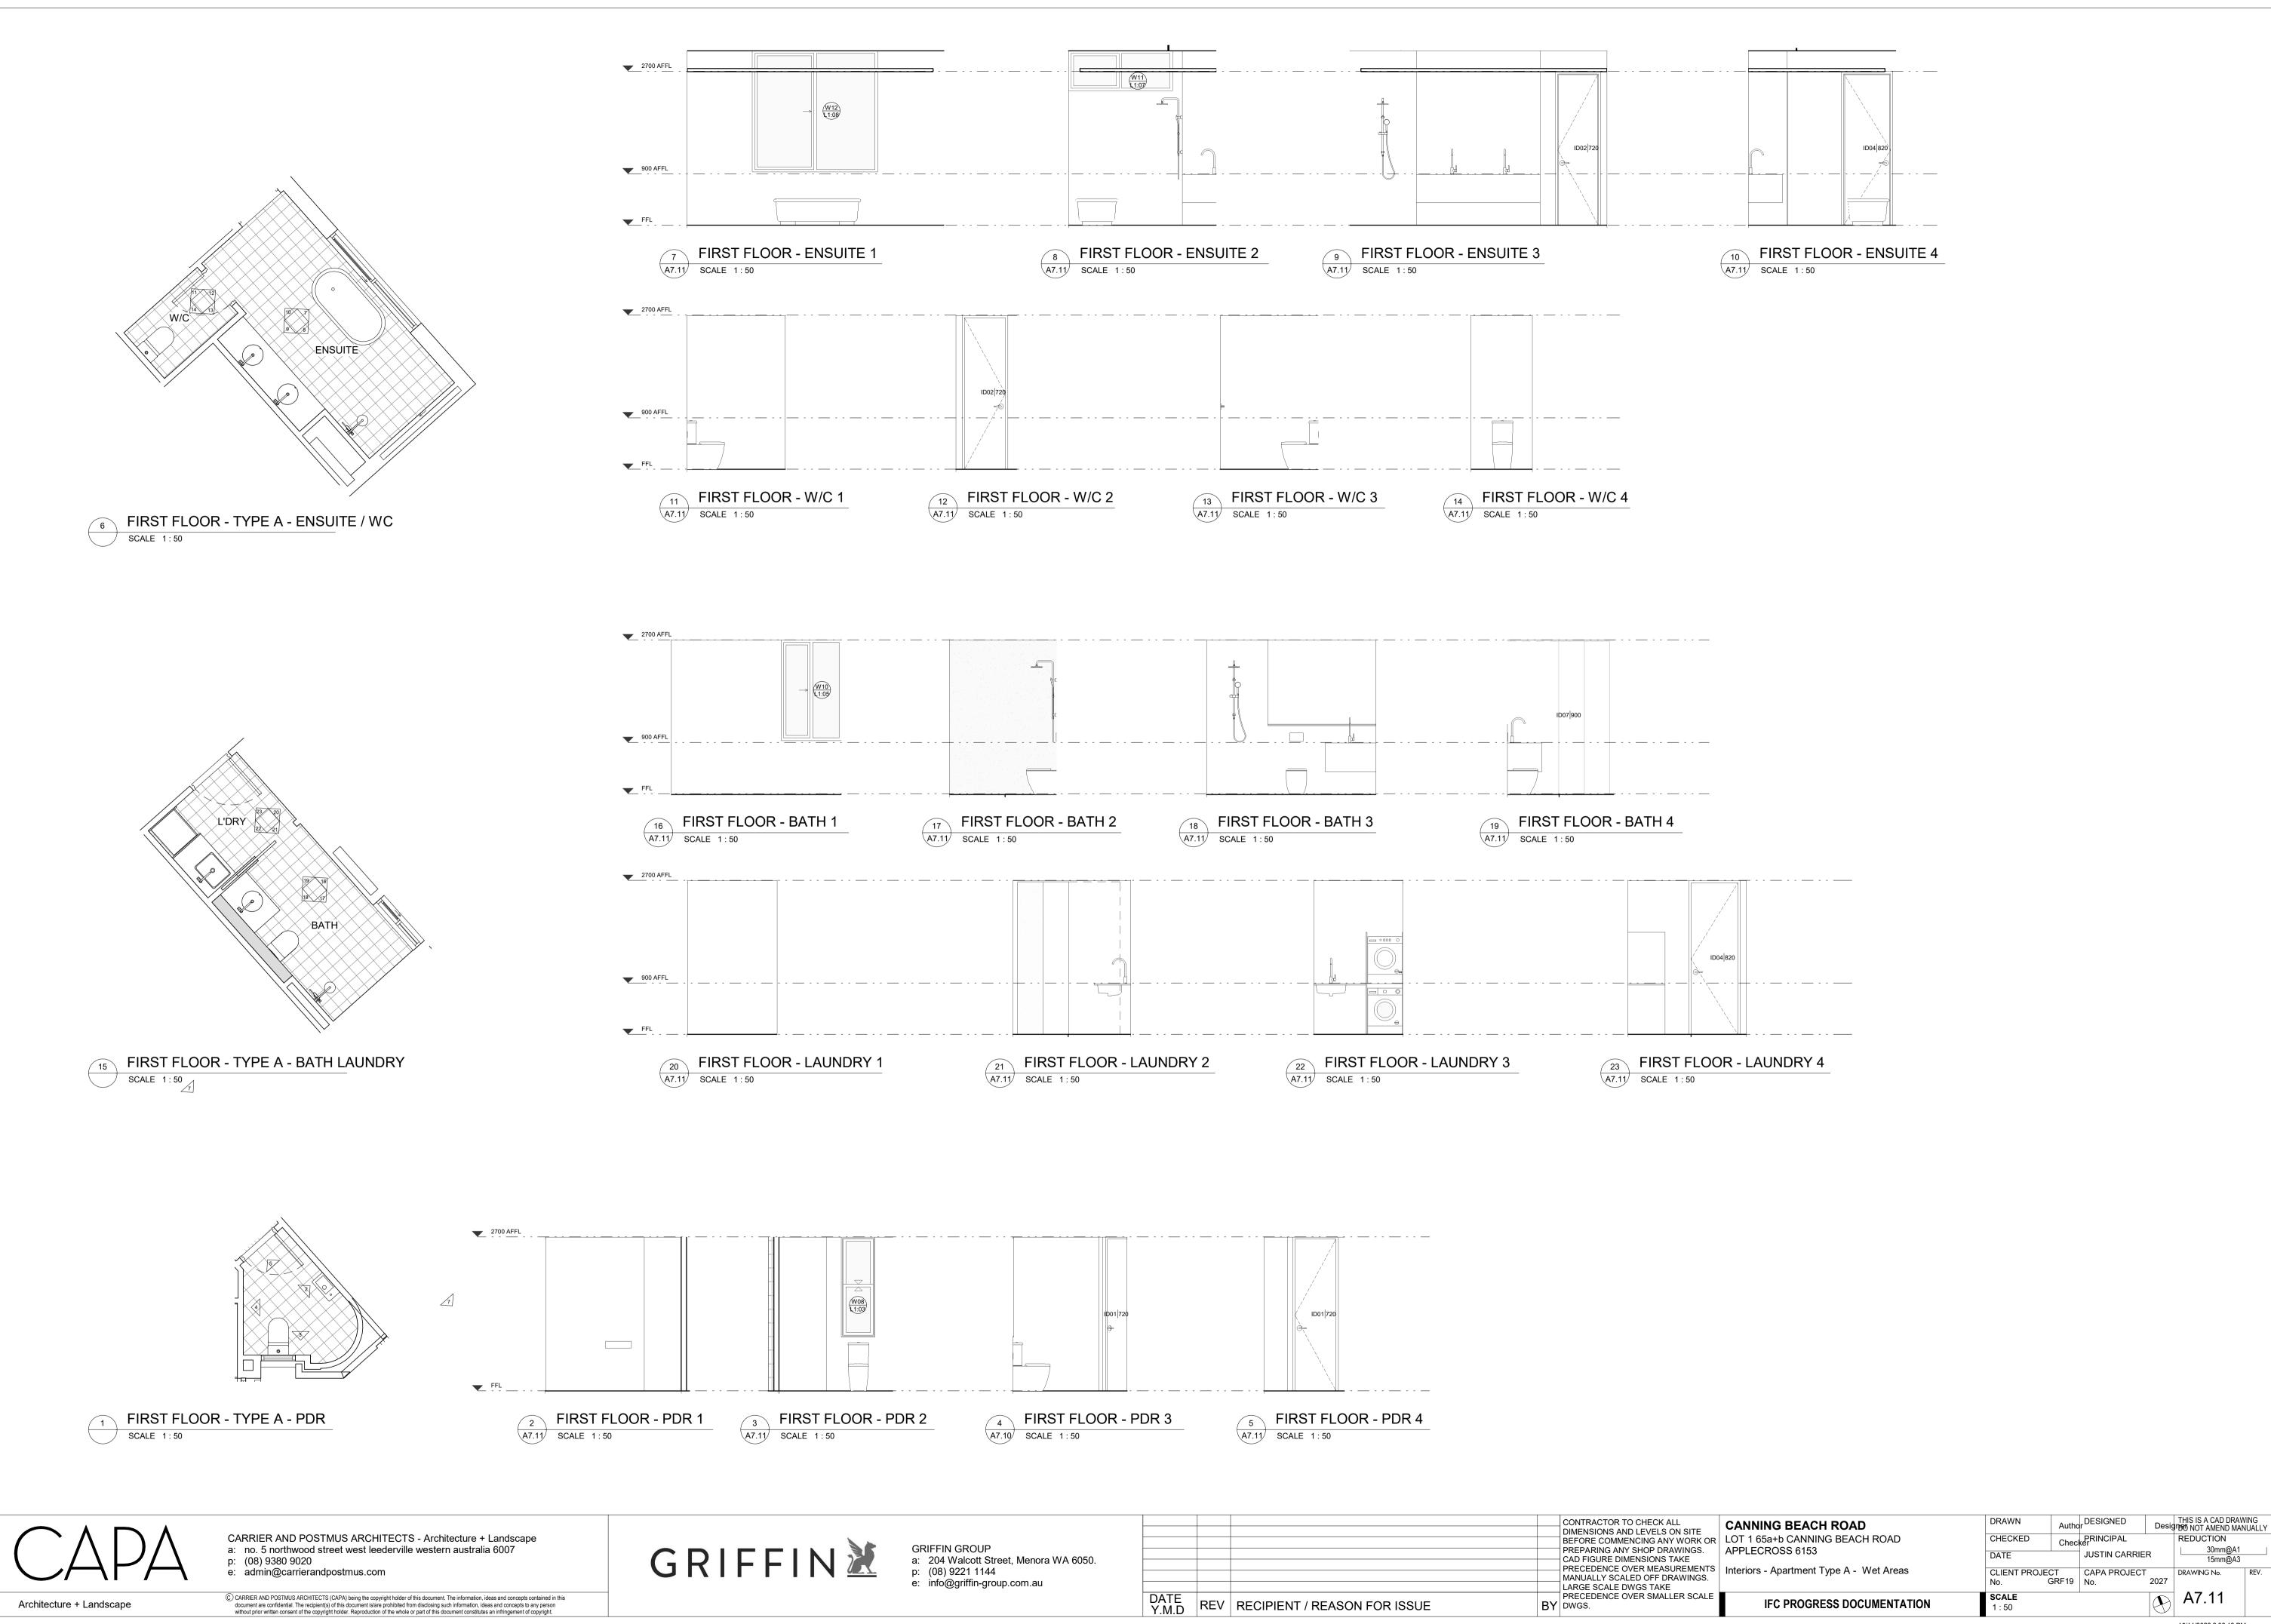15/11/2022 2:08:13 PM

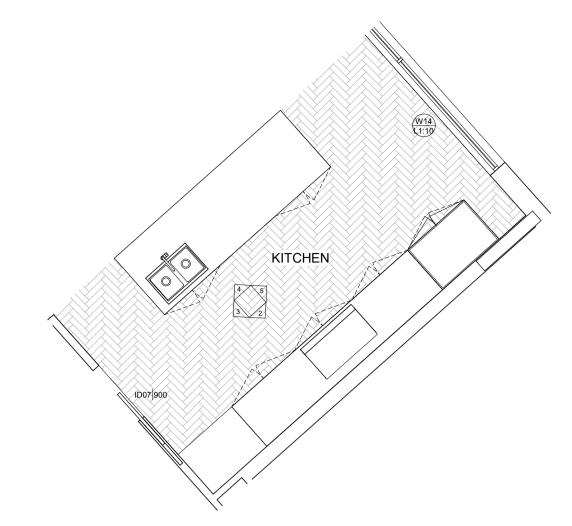

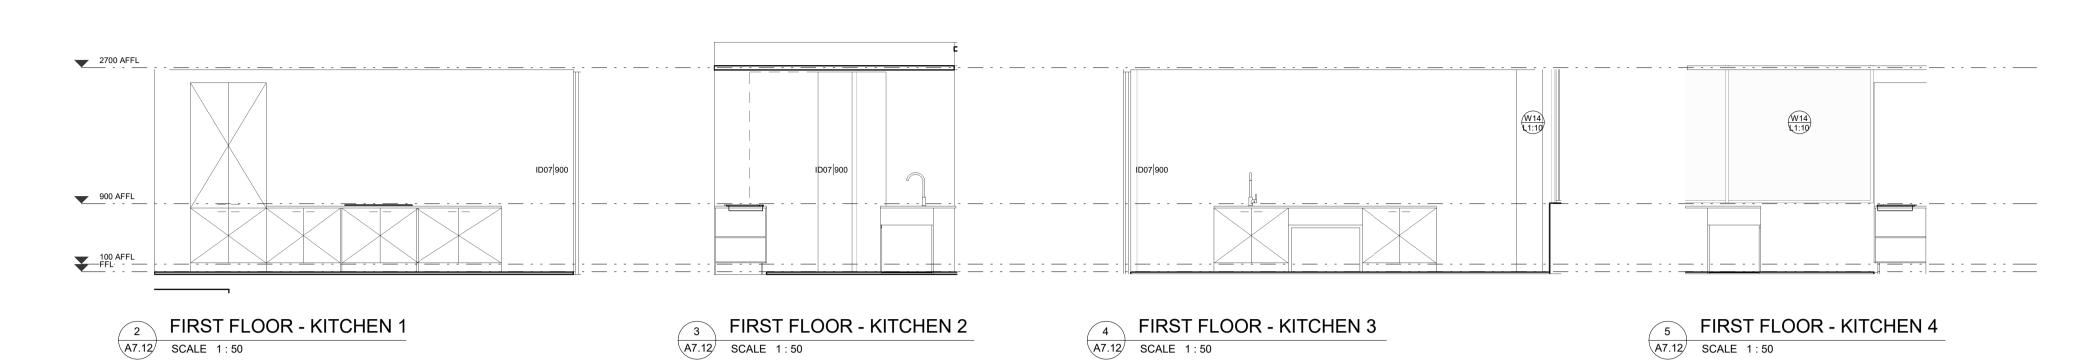

1 FIRST FLOOR - TYPE A - KITCHEN
SCALE 1:50

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MANUALLY SCALED OFF DRAWINGS.
LARGE SCALE DWGS TAKE
PRECEDENCE OVER SMALLER SCALE

MANUALLY SCALED OFF DRAWINGS.
LARGE SCALE DWGS TAKE
PRECEDENCE OVER SMALLER SCALE

MANUALLY SCALED OFF DRAWINGS.


LEC PROGRESS DOCUMENTS DATE Y.M.D REV RECIPIENT / REASON FOR ISSUE BY DWGS.

CANNING BEACH ROAD BEFORE COMMENCING ANY WORK OR LOT 1 65a+b CANNING BEACH ROAD

IFC PROGRESS DOCUMENTATION

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SCALE

PRECEDENCE OVER MEASUREMENTS | Interiors - Apartment Type B - Kitchen, Laundry, Bar

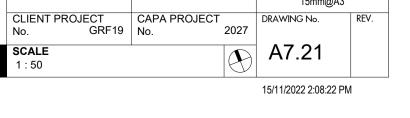IFC PROGRESS DOCUMENTATION


MANUALLY SCALED OFF DRAWINGS.

PRECEDENCE OVER SMALLER SCALE

LARGE SCALE DWGS TAKE

BY DWGS.

REV | RECIPIENT / REASON FOR ISSUE

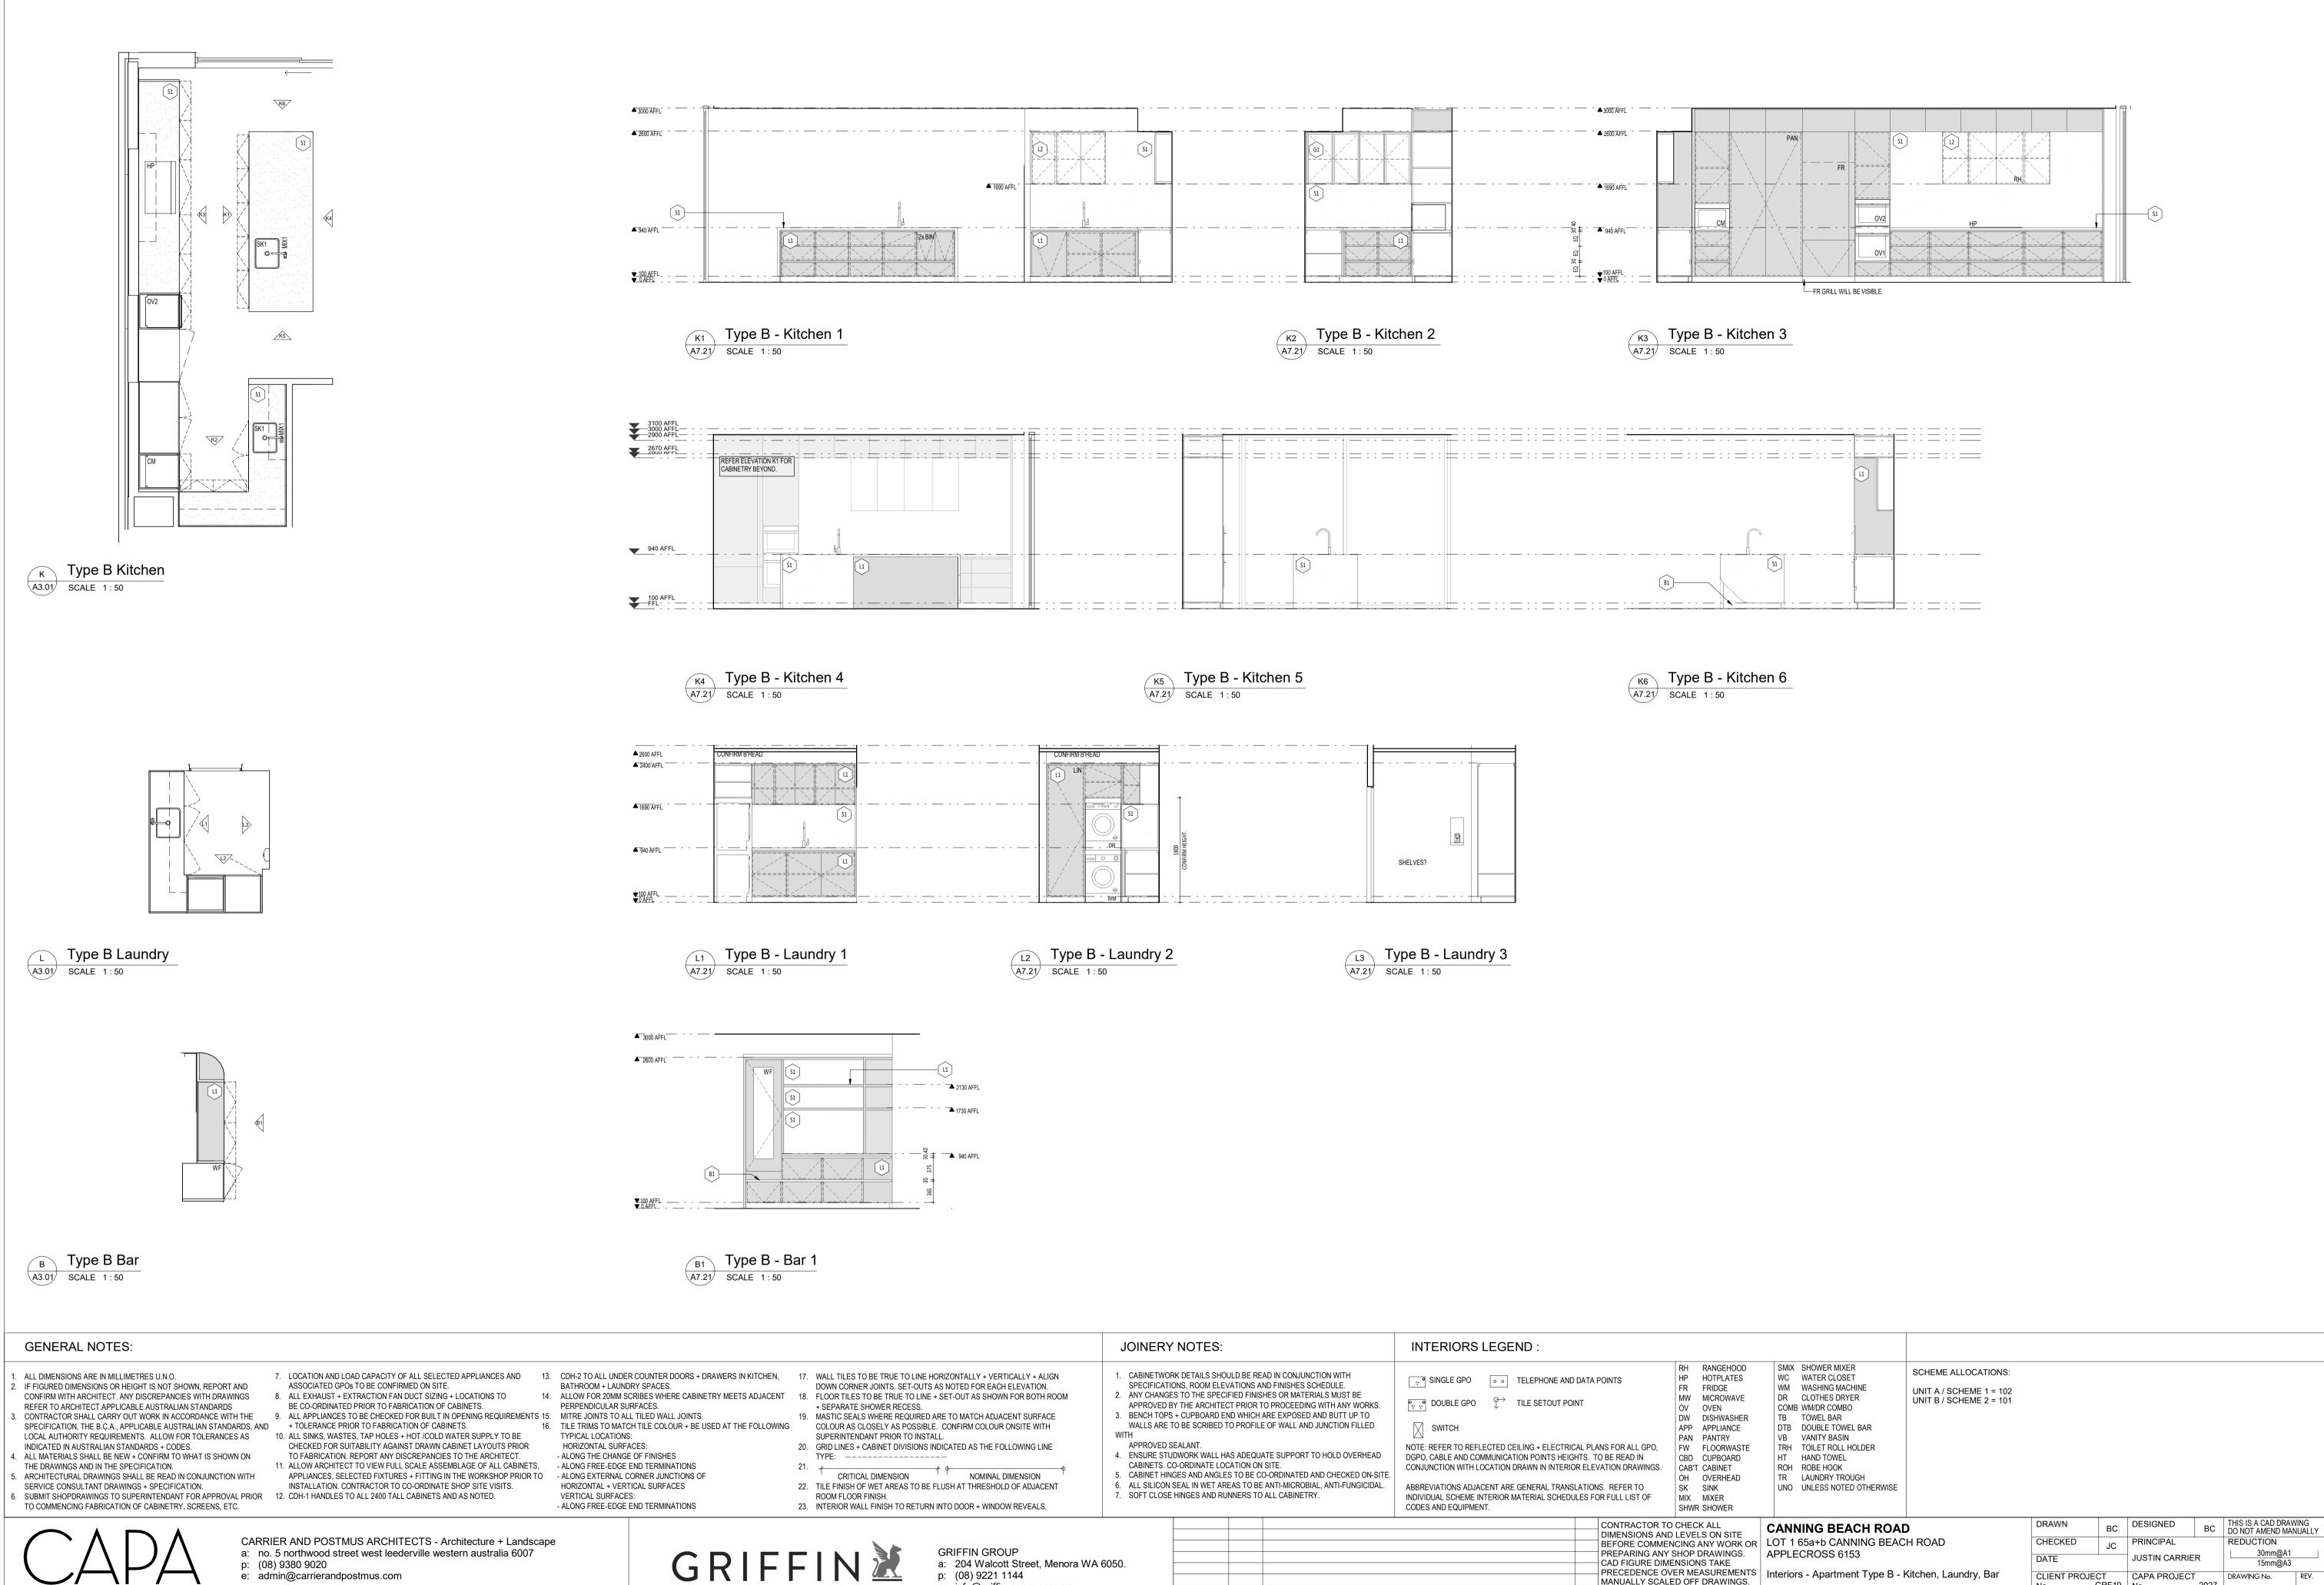

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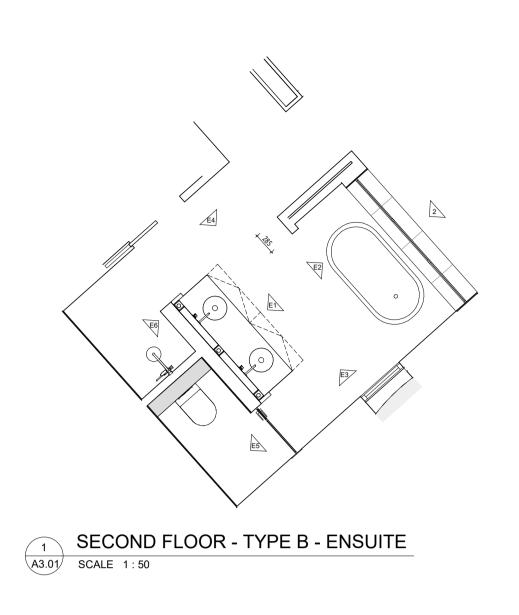
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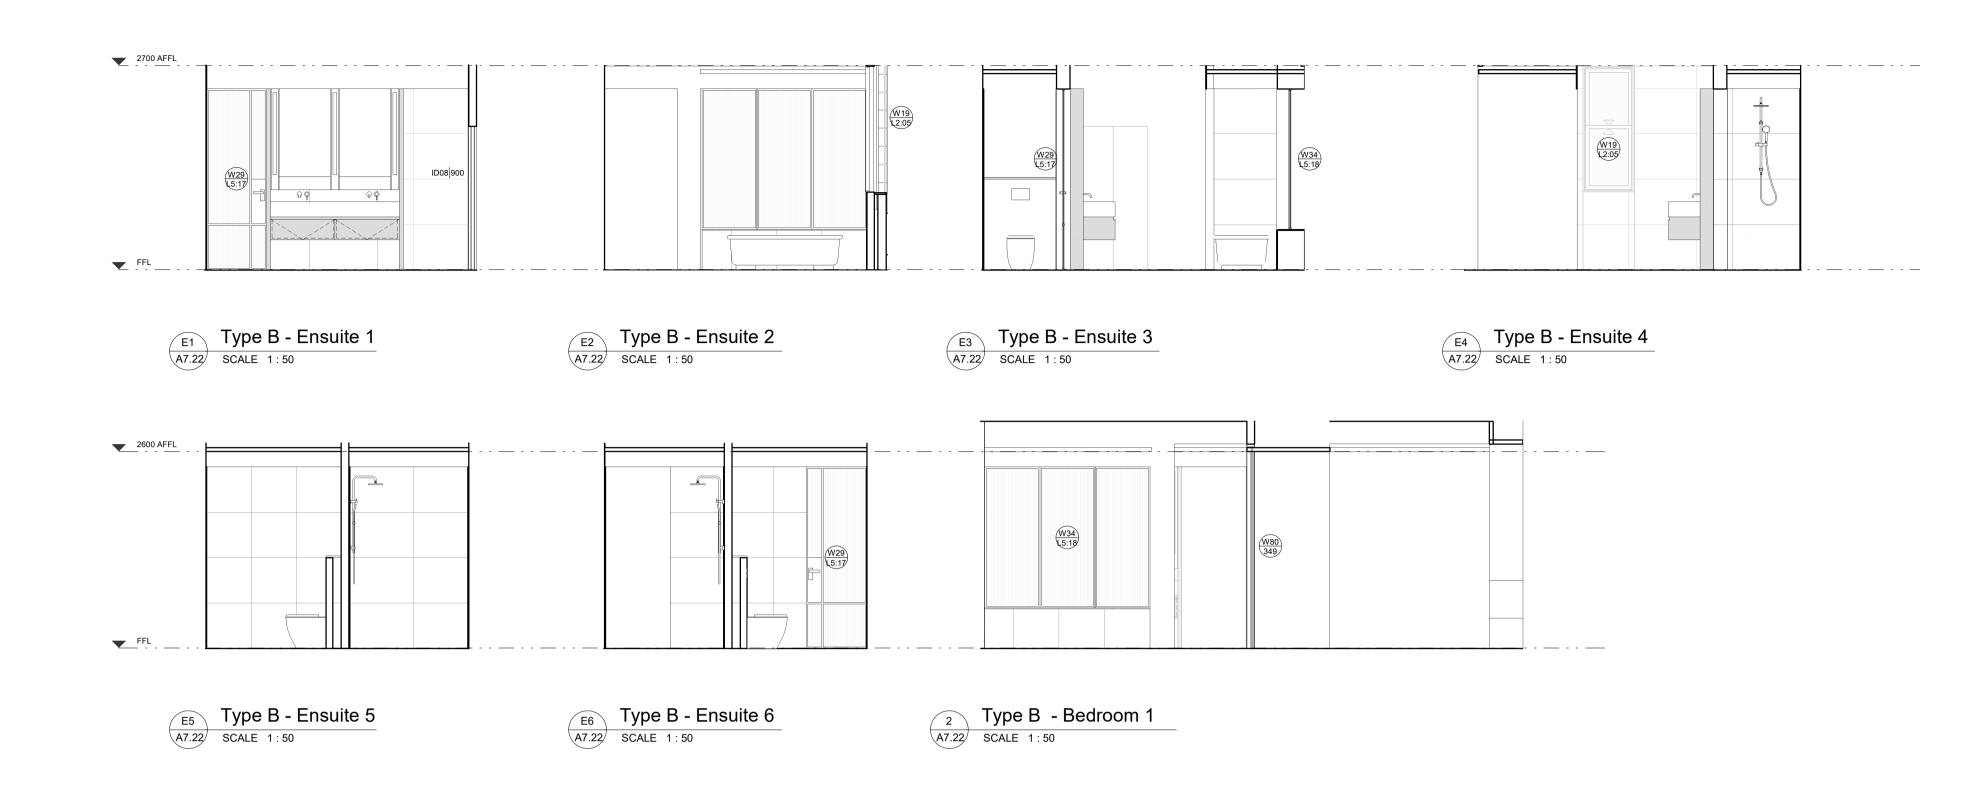
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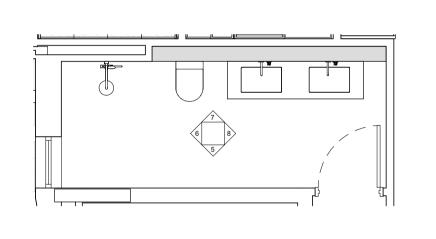
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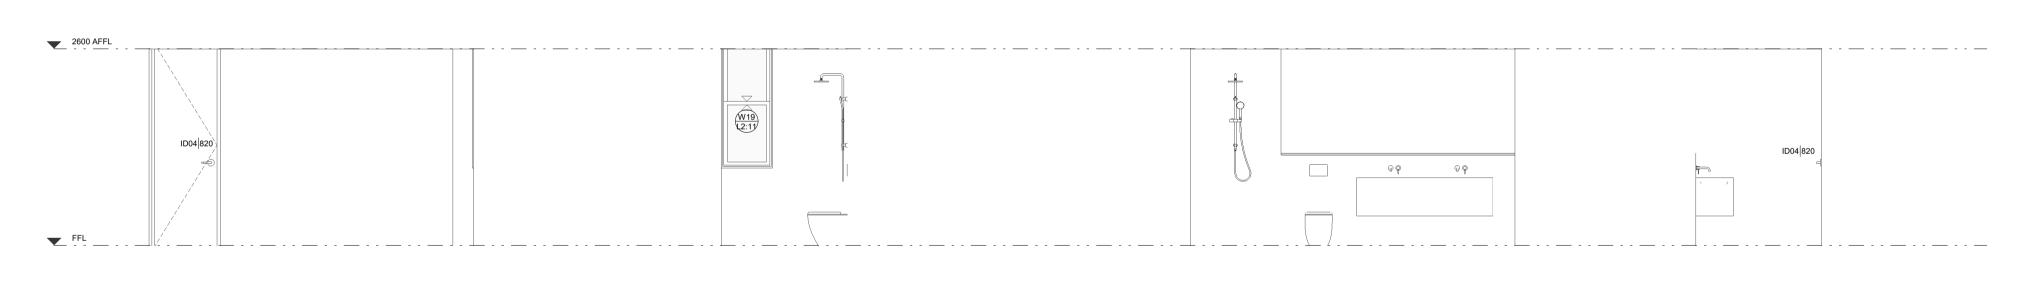
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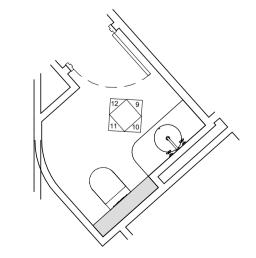















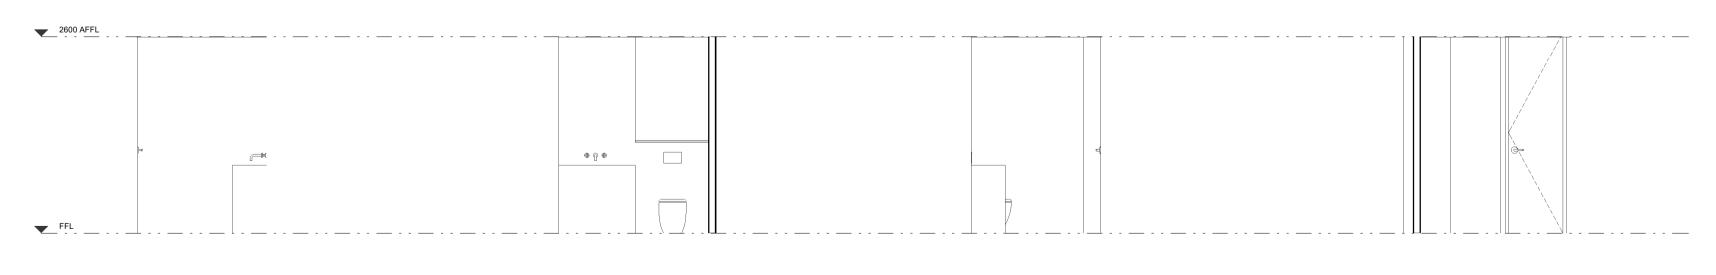

9 SECOND FLOOR - TYPE B - PDR





SECOND FLOOR - TYPE B - PDR 4

A7.22 SCALE 1:50



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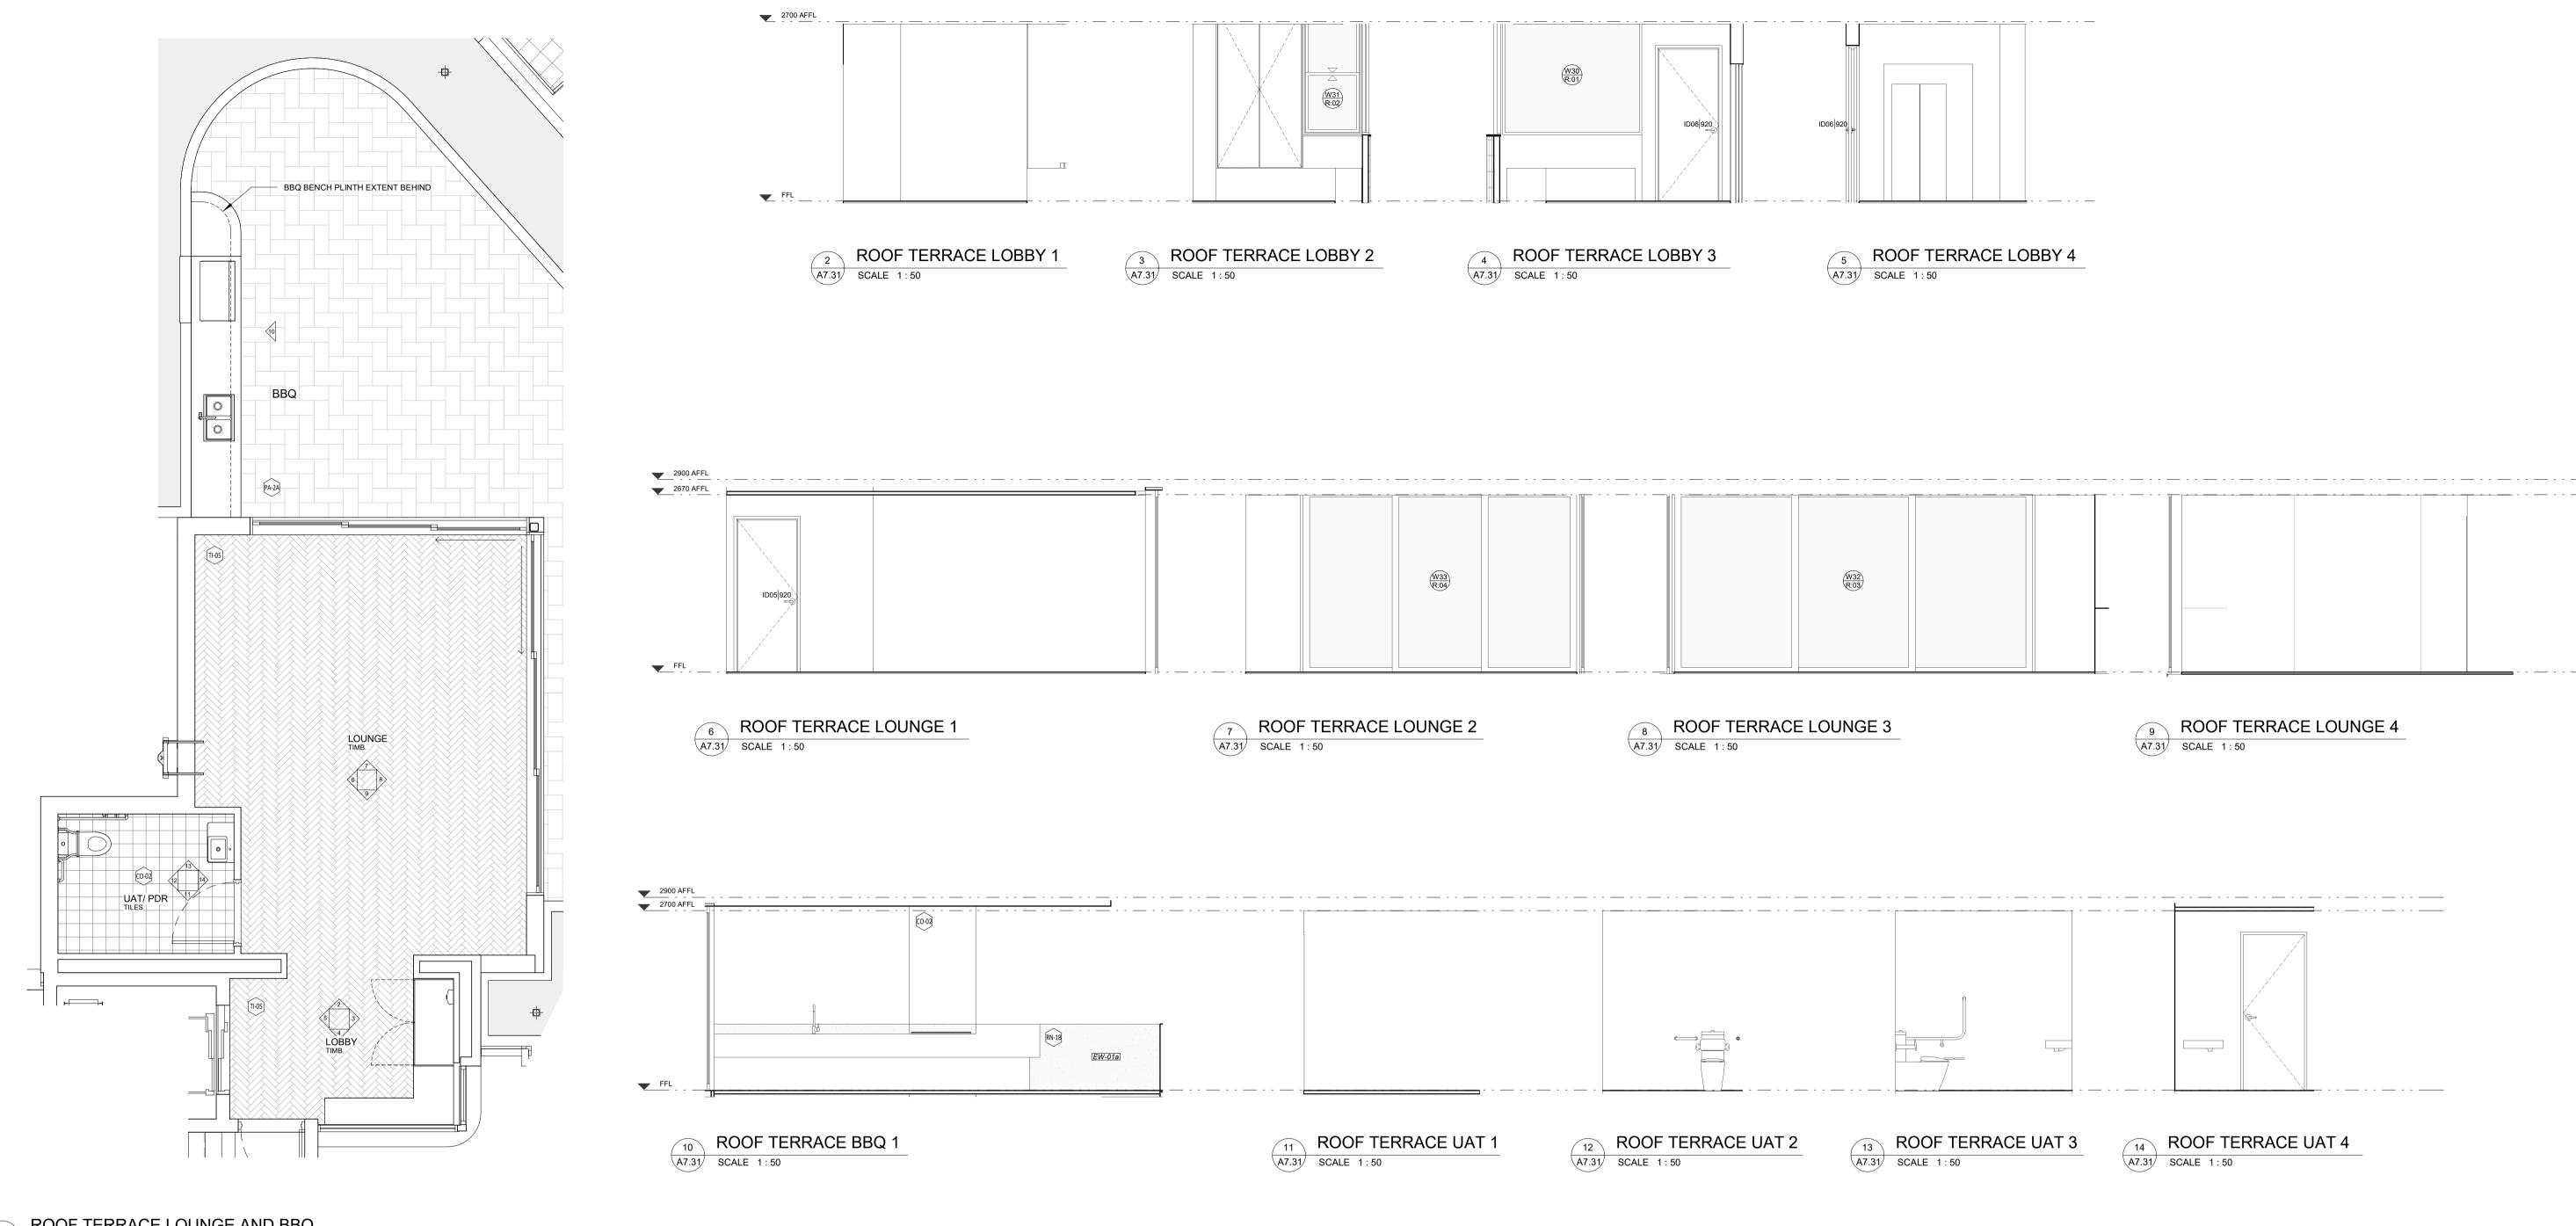
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DATE Y.M.D	REV	RECIPIENT / REASON FOR ISSUE	BY	PRECEDENCE OVER SMALLER SCALE DWGS.	

IFC PROGRESS DOCUMENTATION	SCALE				A7.22
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- views Augustus and Taus D. Mad Augus	DATE		JUSTIN CARRIER		30mm 15mm
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ANNING BEACH ROAD	DRAWN	Autno		Desig	THIS IS A CAD NOT AMEN



ROOF TERRACE LOUNGE AND BBQ
SCALE 1:50



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CANNING BEACH ROAD

OT 1 65a+b CANNING BEACH ROAD

APPLECROSS 6153

Interiors - Roof Terrace

IFC PROGRESS DOCUMENTATION

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Author
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Designed NOT AMEND MANUALLY

CHECKED
Checker
DATE
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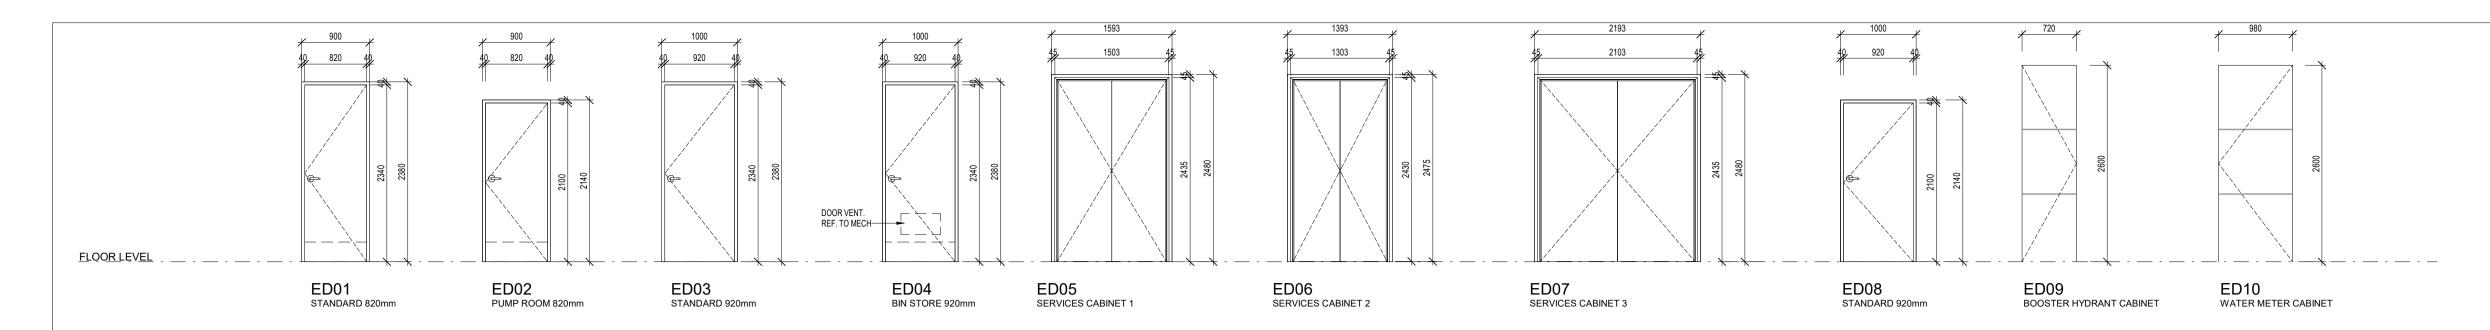
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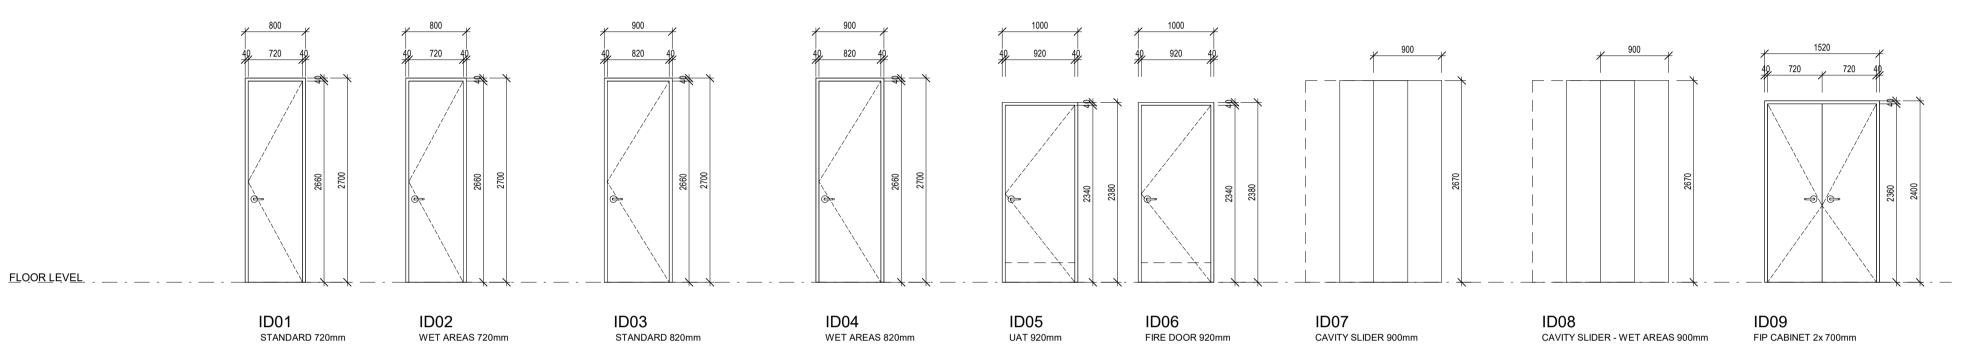
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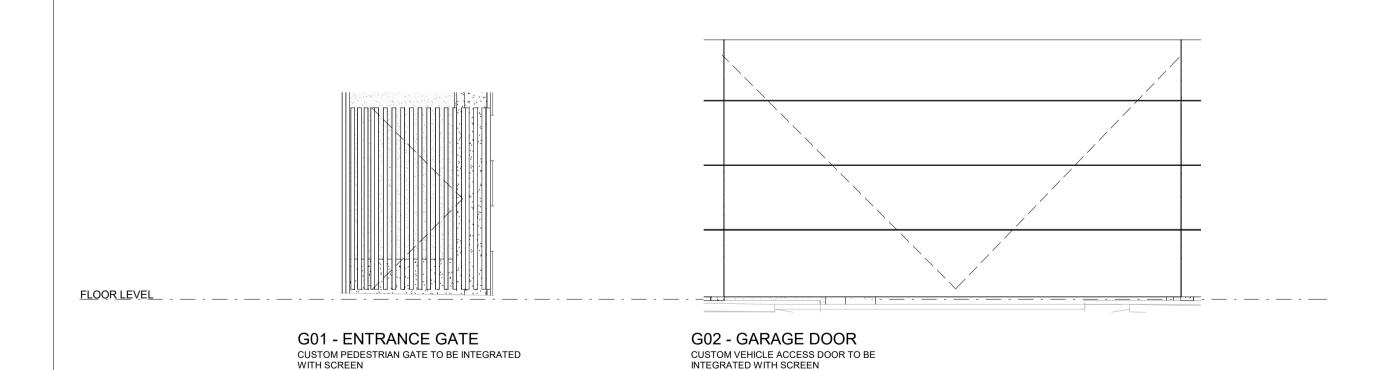
REV.
A7.31



Door Schedule_External								
D/W TYPE	DESCRIPTION	WIDTH	HEIGHT	COUNT	FRAME	INFILL	FRL	REMARK
ED04	MANUAL DE DOOR EVE	000	0040		METAL EDAME	OF COLID CODE FLUCLI DANIEL WEATHER PROCE DAINTER		DOCK CARREN
ED01	820W HINGED DOOR EXT	820	2340	2	METAL FRAME	35 SOLID CORE, FLUSH PANEL. WEATHER PROOF. PAINTED		ROCK GARDEN
ED02	820W HINGED DOOR EXT	820	2100	1	METAL FRAME	35 SOLID CORE, FLUSH PANEL. WEATHER PROOF. PAINTED	-/60/30	PUMP ROOM
ED03	920W HINGED DOOR EXT	920	2340	1	METAL FRAME	35 SOLID CORE, FLUSH PANEL. WEATHER PROOF. PAINTED	-/90/90	STANDARD EXT. DOOR
ED04	920W HINGED DOOR EXT	920	2340	1	METAL FRAME	35 SOLID CORE, FLUSH PANEL. WEATHER PROOF. VENTED, PAINTED		BIN TO GARAGE
ED05	2x920 HINGED DOOR EXT	720	2400	1	METAL FRAME	35 SOLID CORE, FLUSH PANEL. WEATHER PROOF. FIRE RATED, PAINTED	-/60/60	SERVICES CABINET 1
ED06	2x920 HINGED DOOR EXT	620	2400	1	METAL FRAME			SERVICES CABINET 2
ED07	2x920 HINGED DOOR EXT	1020	2400	1	METAL FRAME	35 SOLID CORE, FLUSH PANEL. WEATHER PROOF. FIRE RATED, PAINTED	-/60/60	SERVICES CABINET 3
ED08	720W HINGED DOOR EXT	920	2100	1	METAL FRAME	35 SOLID CORE, FLUSH PANEL. WEATHER PROOF. FIRE RATED, PAINTED		STANDARD EXT. DOOR
ED09	720W HINGED DOOR INTEGRATED INTO SCREEN	720	2600	1		INTEGRATED INTO PERFORATED ALUM. SCREEN		WATER METER CABINE
ED10	980W HINGED DOOR INTEGRATED INTO SCREEN	980	2600	1		INTEGRATED INTO PERFORATED ALUM, SCREEN		BOOSTER CABINET



	Door Schedule_Internal									
				200.	onedaio_internal					
D/W TYPE	DESCRIPTION	WIDTH	HEIGHT	COUNT	FRAME	INFILL	FRL	REMARK		
			<u> </u>	'	<u> </u>		'			
ID01	720W HINGED DOOR INT	720	2660	5		35 HOLLOW CORE, FLUSH PANEL, PAINTED		STANDARD INT. DOOR 720		
ID02	720W HINGED DOOR INT MOISTURE RESISTANT	720	2660	1		35 HOLLOW CORE, MOISTURE RESISTANT, FLUSH PANEL, PAINTED		WET AREAS 720		
ID03	820W HINGED DOOR INT	820	2660	20		35 HOLLOW CORE, FLUSH PANEL, PAINTED		STANDARD INT. DOOR 820		
ID04	820W HINGED DOOR INT MOISTURE RESISTANT	820	2660	6		35 HOLLOW CORE, MOISTURE RESISTANT, FLUSH PANEL, PAINTED		WET AREAS 820		
ID05	920W HINGED DOOR INT MOISTURE RESISTANT	920	2340	2		35 SOLID CORE, FLUSH PANEL. MOISTURE RESISTANT. PAINTED		UAT DOOR		
ID06	920W HINGED DOOR INT FIRE RATED	920	2340	7		35 SOLID CORE, FLUSH PANEL, WITH SELF CLOSER, FIRE RATED, PAINTED FINISH	-/90/90	STAIR DOOR		
ID07	820W CAVITY SLIDING DOOR INT	900	2700	7		35 HOLLOW CORE, FLUSH PANEL, PAINTED		CAVITY SLIDER		
ID08	820W CAVITY SLIDING DOOR INT MOISTURE RESISTANT	900	2700	4		35 HOLLOW CORE, MOISTURE RESISTANT, FLUSH PANEL, PAINTED		CAVITY SLIDER WET AREAS		
ID09	2x720W HINGED DOOR	720	2360	1		35 SOLID CORE, FLUSH PANEL. PAINTED	-/60/60	FIP CABINET		



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				BEFORE COMMENCING ANY WORK
				PREPARING ANY SHOP DRAWINGS
				CAD FIGURE DIMENSIONS TAKE
				PRECEDENCE OVER MEASUREMEN MANUALLY SCALED OFF DRAWING
				LARGE SCALE DWGS TAKE
DATE				
DATE Y.M.D	REV	RECIPIENT / REASON FOR ISSUE	BY	PRECEDENCE OVER SMALLER SCA DWGS.

	CANNING BEACH ROAD
R	CANNING BEACH ROAD LOT 1 65a+b CANNING BEACH ROAD APPLECROSS 6153
s	Door Schedule

NING BEACH ROAD	DRAWN	DESIGNED	JC	THIS IS A CAD DRAWING DO NOT AMEND MANUALL		
65a+b CANNING BEACH ROAD	CHECKED	СМ	PRINCIPAL		REDUCTION	
ECROSS 6153	DATE	JUSTIN CARRIER		30mm@A1 15mm@A3		
Schedule	CLIENT PROJE No.	CT GRF19	CAPA PROJECT No.	2027	DRAWING No.	REV.
IFC PROGRESS DOCUMENTATION	SCALE As indicated				A8.01	

GENERAL NOTES

DIMENSIONS.

AUTHORITY REQUIREMENTS.

FLOOR WASTES AND TILING.

CONDITIONS & ACCESS REQUIREMENTS.

SAME AS ADJACENT MATERIAL U.N.O.

BUILDING TAG XX-XX

:
AWNING
CASEMENT WINDOW
CAVITY SLDING DOOR
EXTERIOR
DOUBLE HUNG WINDOW
FIXED PANE

HANDED HINGED DOOR INTERIOR

GL03 CLEAR SYSTEM - CURVED

SIGNAGE FREE TO EGRESS DOOR CLOSER

GL04 SINGLE-GLAZED, FLUTED GLASS PANELS

DOOR AND WINDOW REMARKS

1) SMOKE AND ACOUSTIC SEALS
2) DOOR CLOSER WITH HOLD-OPEN, INTERIOR SIDE
3) SECURITY DOOR VIEW GLASS LENS
4) PROVINCE CERTIFICATE

XX OPENING TYPE XX OPENING NUMBER SYMBOL SHOWN ON FLOOR PLANS

FLOOR LEVEL (AKA SL) WITHOUT FINISHES

GL01 6mm / 12mm / 6.38mm DOUBLE-GLAZED, CLEAR SYSTEM U-VALUE 3.9 SHGC 0.59

GL02 6mm / 12mm / 6.38mm DOUBLE-GLAZED, OBSCURE SYSTEM U-VALUE 3.9 SHGC 0.59

INTERIOR LOUVRE WINDOW (BREEZEWAY ALTAIR LOUVRE O.A.E.) PIVOT DOOR SLIDING PANE ROLLER BLIND

GLAZING TYPE SCHEDULE: GLAZING FOR WINDOWS AND DOORS SHALL BE MINIMUM GRADE "A" 4MM TOUGHENED SAFETY GLASS. MINIMUM PERFORMANCE REQUIREMENTS PER ESD REPORT.

PERFORMANCE REQUIREMENTS SPECIFIED SHALL BE FOR THE OVERALL ASSEMBLED SUITE.

SYMBOL INDICATES GLAZING TYPE IS TYPICAL AND GENERALLY TO ALL THE GLAZED LIGHTS OF THE SUITE U.N.O.

ALL DIMENSIONS ARE IN MILLIMETRES U.N.O.

WRITTEN DIMENSIONS SHALL TAKE PRECEDENCE OVER SCALED

CONTRACTOR SHALL CARRY OUT WORK IN CONFORMANCE WITH THE B.C.A./N.C.C. RELEVANT STANDARDS AND THE LOCAL

THE MAIN CONTRACTOR IS TO ENSURE THIS DRAWING IS READ IN CONJUNCTION WITH ALL RELEVANT ARCHITECTURAL, STRUCTURAL AND SERVICE CONSULTANT DOCUMENTATION TO

ENSURE FULL CO-ORDINATION BETWEEN TRADES PRIOR TO WORK COMMENCEMENT. LARGE SCALE DRAWINGS SHALL TAKE PRECEDENCE OVER SMALLER SCALE DRAWINGS. CONTRACTOR SHALL CARRY OUT WORK IN CONFORMANCE WITH THE B.C.A./N.C.C. RELEVANT STANDARDS AND THE LOCAL AUTHORITY REQUIREMENTS. SEEK CLARIFICATION FROM SUPERINTENDENT FOR ANY

DISCREPANCIES.
ALL EXTERNAL FLOOR SURFACES TO FALL AWAY FROM

BUILDING.
REFER INTERIOR DOCUMENTATION FOR SETOUTS AND EXACT LOCATIONS OF CABINETRY, FITTINGS, FIXTURES, PLUMBING,

ALL MATERIALS SHALL BE NEW & COMFORM TO WHAT IS SHOWN ON THE DRAWINGS AND IN THE SCHEDULES.

THE CONTRACTOR SHALL CHECK & VERIFY ALL DIMENSIONS ON SITE, PRIOR TO THE COMMENCEMENT OF ANY BUILDING WORK. ALL WINDOW DIMENSIONS ARE NOMINAL AND ARE TO BE MEASURED ON SITE.
THE CONTRACTOR SHALL VISIT THE SITE & NOTE ALL SITE

REFER SLAB SETOUT PLANS FOR SLAB AND STRUCTURAL COLUMN SETOUTS.
ENSURE ALL STRUCTURAL STEEL COLUMNS WITHIN 3m OF SITE BOUNDARY TO BE FIRE PROTECTED TO CODES AND STANDARDS. INSTALL FLASHINGS, EDGE TRIMS AND APPROPRIATE SEASL AS REQUIRED TO ACHIEVE WEATHER TIGHTNESS. FINISH TO BE

REFER FLOOR PLANS FOR DOOR HANDING, TYPE OF WALLS RECEIVING DOOR AND/OR WINDOW FRAMES.
REFER ELEVATIONS FOR HANDING AND POSITION OF WINDOWS.
REFER DOOR HARDWARE SCHEDULE (TBC) FOR LOCK AND HARDWARE.
REFER FINISHES SCHEDULE (TBC) FOR FINISHES.
ALUM. DOOR/WINDOW SUITES SHALL BE CONCEAL FIXED (IE NO VISIBLE POP RIVETS, SCREWS AND THE LIKE).
SEEK SUPERINTENDENT'S INSTRUCTION FOR ANY DISCREPANCIES.
STEEL AND ALUMINIUM DOOR FRAMES SHALL BE FITTED WITH STIFFENING PLATES OF THE SAME FRAMING METRAIL TO LOCK, HINGE AND DOOR CLOSER FIXING POINTS.
STEEL DOOR FRAMES TO BE PROVIDED WITH CUTOUTS AND BACKPLATES TO SUIT SCHEDULED HINGES. PROVIDE INTEGRATED HINGES OTHERWISE.
SUPPLY & INSTALL FLASHING TO ALL EXTERNAL OPENINGS.
SUPPLY & INSTALL MATCHING COVER TRIMS, AS REQUIRED.
DOOR HANDLES SHALL BE @1050 AFFL, U.N.O.
FLOOR MOUNTED DOOR STOPS FOR ALL HINGED DOORS.
EXTERIOR WINDOWS AND DOOR & WINDOW SUITES SHALL BE INSTALLED WITH SUBSILL, U.N.O., REBATE STRUCTURAL FLOOR BOARD AND/OR CONCRETE SLAB TO ACHIEVE TOP OF DOOR SILL FLUSH WITH INTERNAL FLOOR FINISH.

FLOOR FINISH.
ALL EXTERIOR OPERABLE WINDOWS AND SLIDING DOORS TO BE FITTED WITH

ALL EXTERIOR OPERABLE WINDOWS AND SLIDING DOORS TO BE FITTED WITH ALUMINIUM FRAMED BLACK INSECT MESH WITH MAX 2MM APERTURE, REMOVABLE FOR CLEANING, U.N.O. FRAME COLOUR TO MATCH ASSOCIATED WINDOW.DOOR ATTACHED.

ALL EXTERIOR OPERABLE WINDOWS, DOORS, FLYSCREEN DOORS AND GATES TO BE KEY LOCKABLE, U.N.O.

PROPRIETARY FRAME INTEGRATED PERIMETER SEALS TO HEAD, SILL/TRANSOM AND JAMBS OF EXTERIOR OPERABLE OPENINGS.
GLAZING TO COMPLY WITH RELEVANT AUSTRALIAN GLAZING STANDARDS AND CODES.

SUBMIT SHOP DRAWINGS TO SUPERINTENDENT FOR APPROVAL PRIOR TO COMMENCING FABRICATION OF DOORS, DOOR WINDOWS, WINDOWS, SKYLIGHTS, GATES, SCREENS & LOUVRES.
PROVIDE OPENING RESTRICTORS AS REQUIRED IN CONFORMANCE TO CODES AND STANDARDS.
PROVIDE VISUAL INDICATOR STRIPS AS REQUIRED IN CONFORMANCE TO CODES AND STANDARDS TO PUBLIC FACING GLAZING AND GLAZED DOORS.

REFER TO WALL TYPES PLANS FOR WALL SETOUTS.
REFER SLAB SETOUT PLANS FOR SLAB AND STRUCTURAL


REFER MASTER MATERIALS SCHEDULE FOR THE FOLLOWING AND MORE:


NOTES - DOORS, WINDOWS & GATES:

1. ELEVATIONS SHOWN ARE AS SEEN FROM EXTERNAL OR OUTSIDE OF THE DESIGNATED ROOM U.N.O.

2. REFER FLOOR PLANS FOR DOOR HANDING, TYPE OF WALLS RECEIVING

16.1 STRUCTURE SURFACE FINISHES 16.4 FINISHES
16.2 FIXTURES & FITTINGS 16.5 APPLIANCES
16.3 WATERPROOFING SYSTEMS 16.6 TRIMS

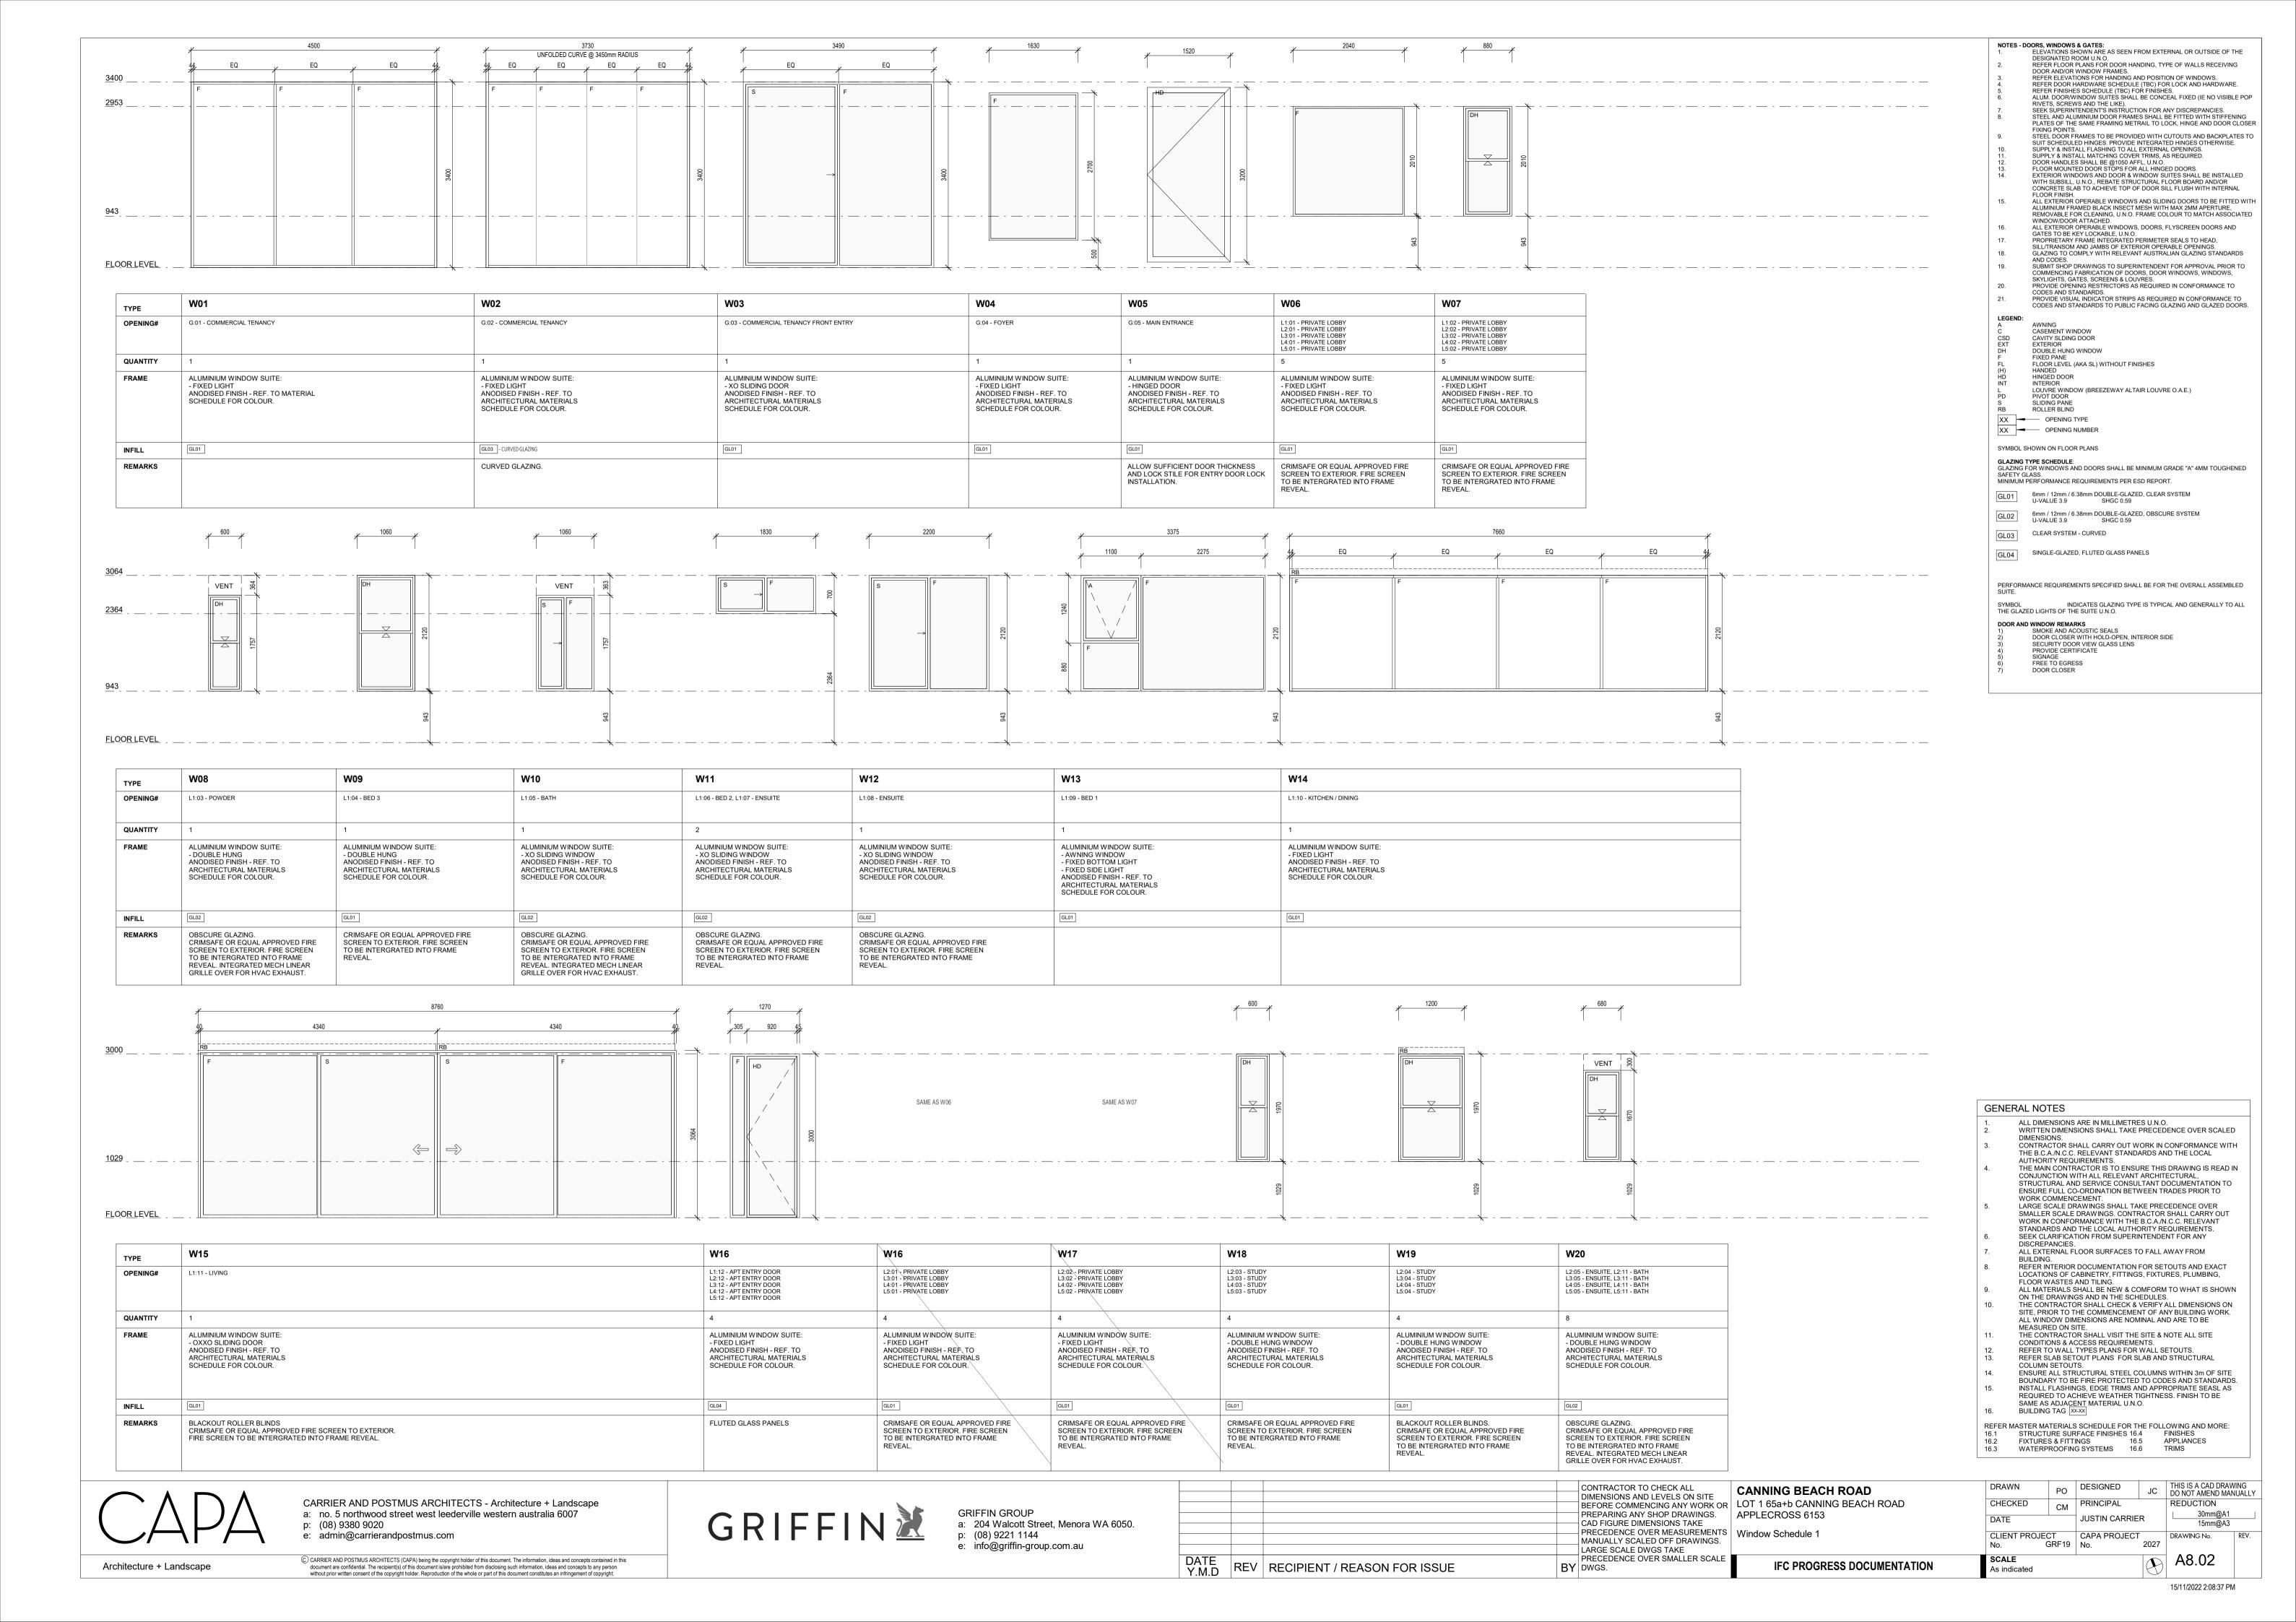

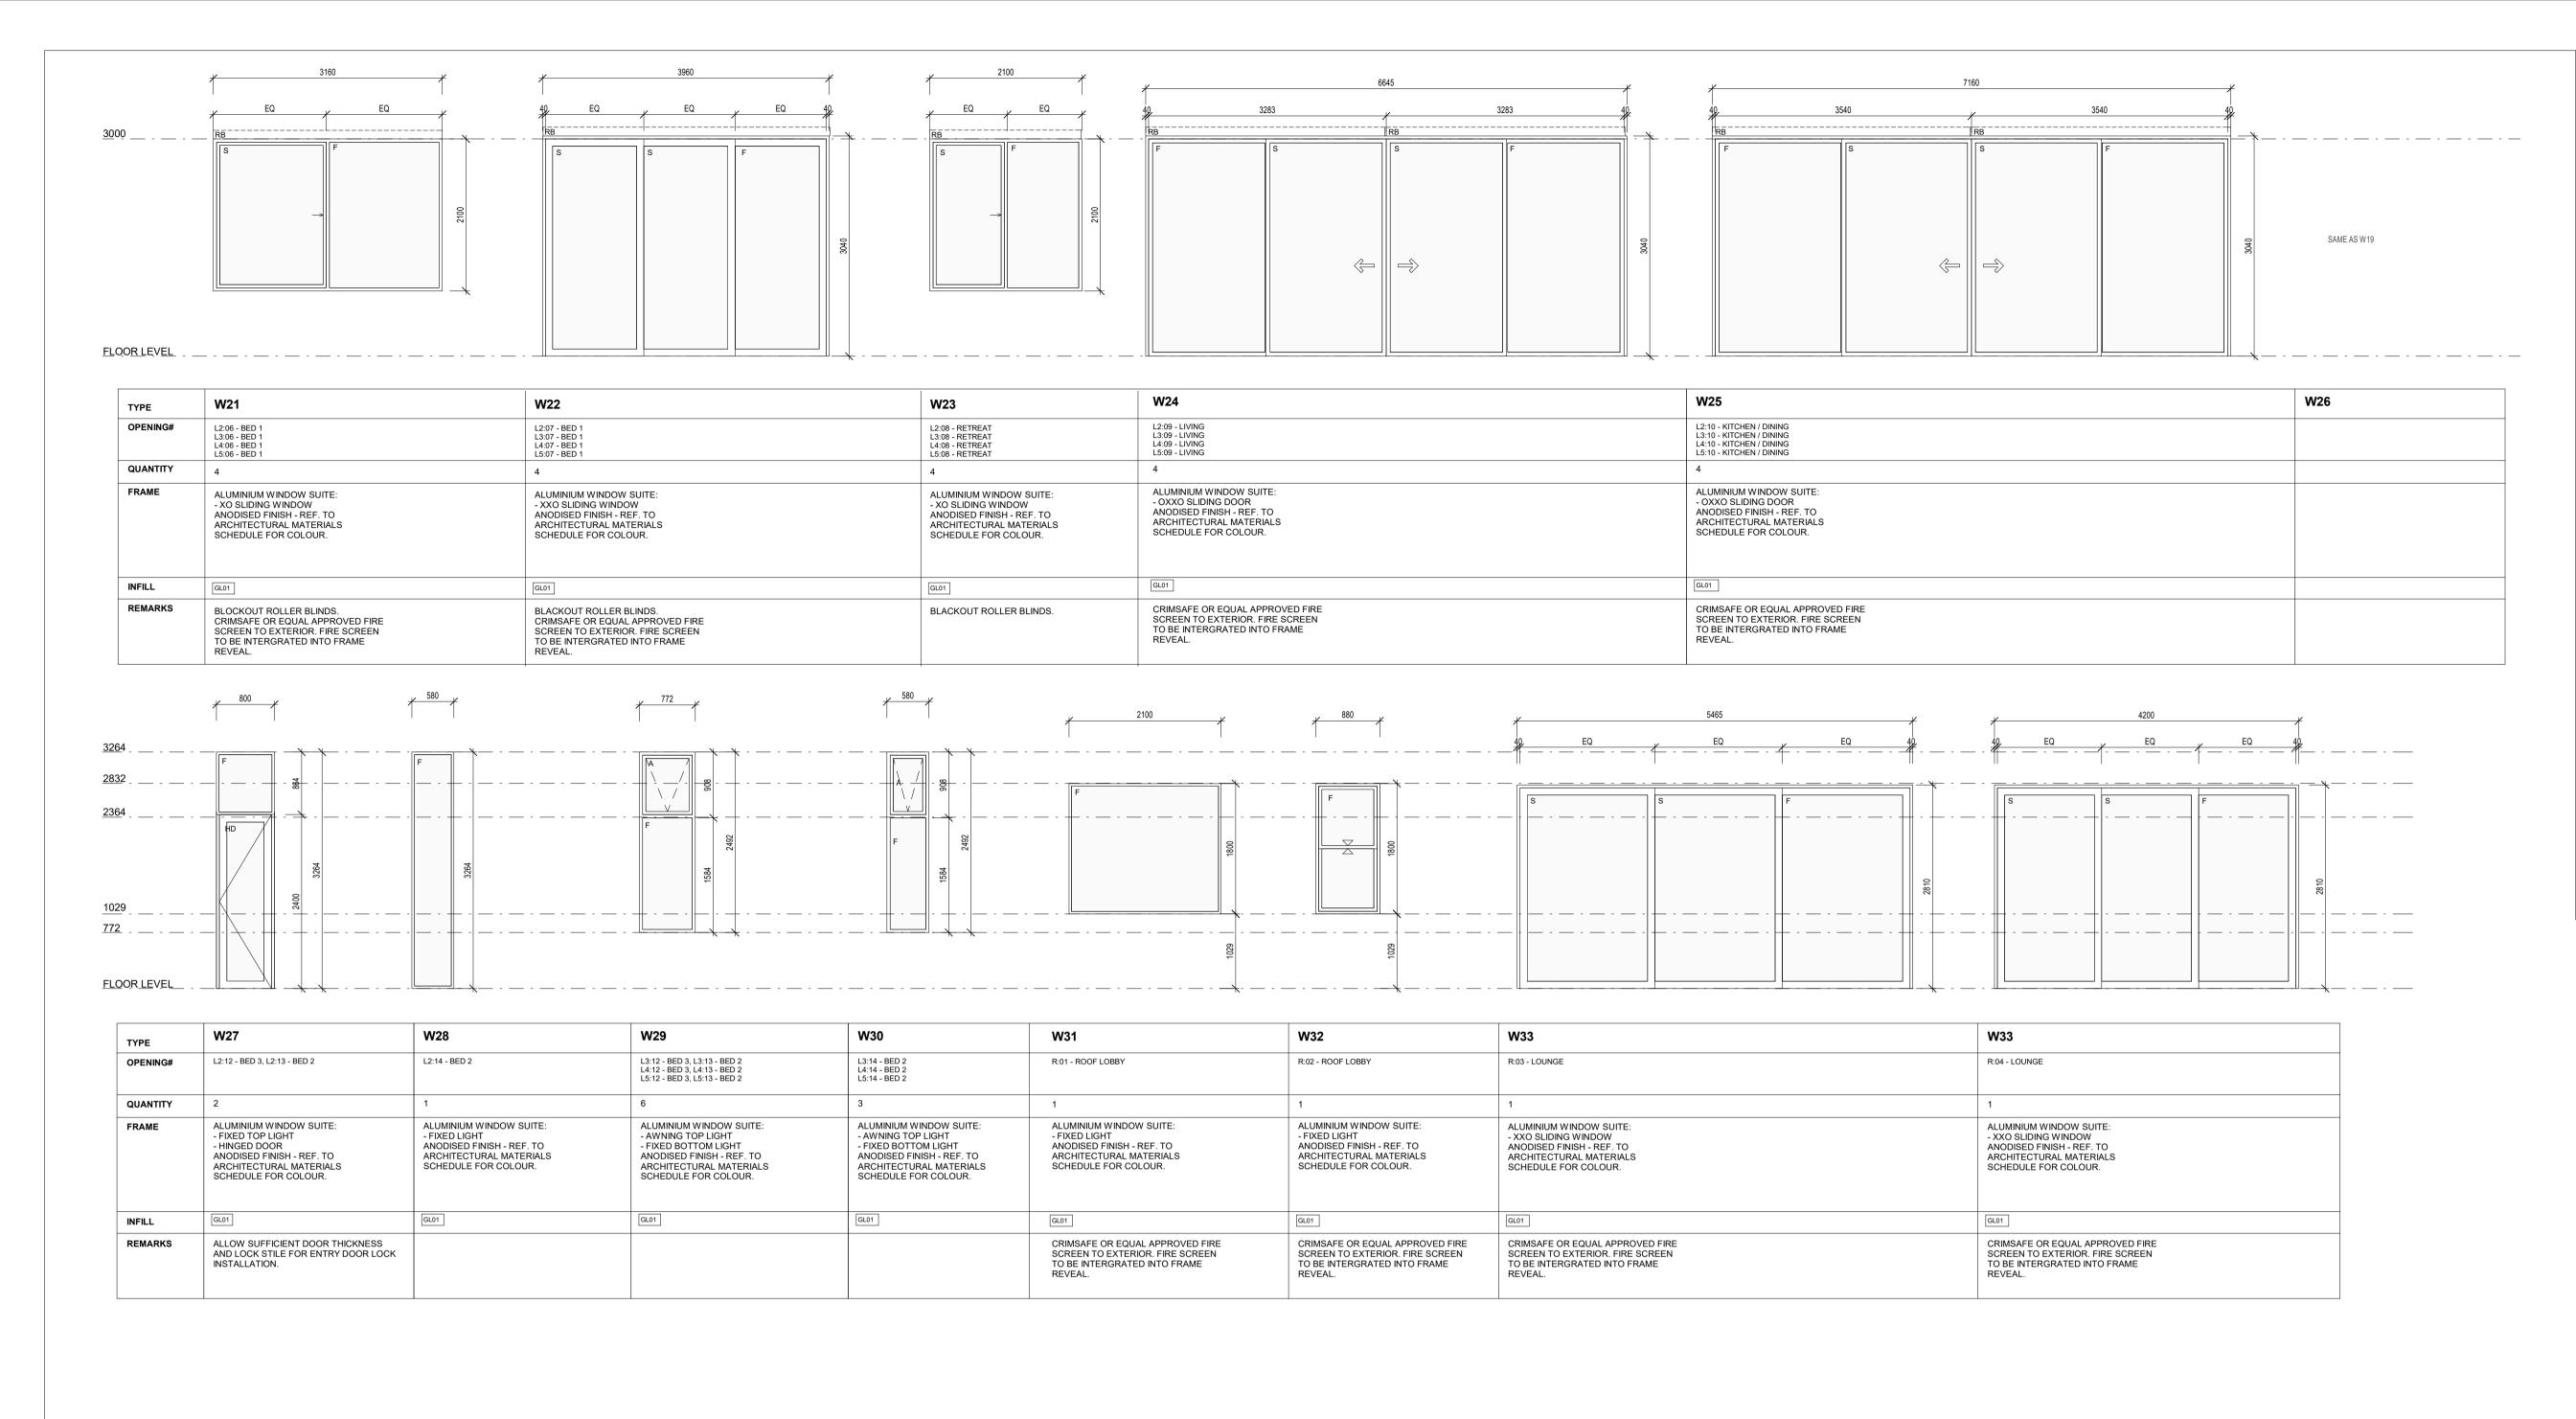

6mm / 12mm / 6.38mm DOUBLE-GLAZED, OBSCURE SYSTEM U-VALUE 3.9 SHGC 0.59 CLEAR SYSTEM - CURVED GL04 SINGLE-GLAZED, FLUTED GLASS PANELS PERFORMANCE REQUIREMENTS SPECIFIED SHALL BE FOR THE OVERALL ASSEMBLED INDICATES GLAZING TYPE IS TYPICAL AND GENERALLY TO ALL THE GLAZED LIGHTS OF THE SUITE U.N.O. DOOR AND WINDOW REMARKS

1) SMOKE AND ACOUSTIC SEALS
2) DOOR CLOSER WITH HOLD-OPEN, INTERIOR SIDE SECURITY DOOR VIEW GLASS LENS PROVIDE CERTIFICATE SIGNAGE FREE TO EGRESS **GENERAL NOTES** ALL DIMENSIONS ARE IN MILLIMETRES U.N.O. WRITTEN DIMENSIONS SHALL TAKE PRECEDENCE OVER SCALED DIMENSIONS.
CONTRACTOR SHALL CARRY OUT WORK IN CONFORMANCE WITH THE B.C.A./N.C.C. RELEVANT STANDARDS AND THE LOCAL AUTHORITY REQUIREMENTS. THE MAIN CONTRACTOR IS TO ENSURE THIS DRAWING IS READ IN CONJUNCTION WITH ALL RELEVANT ARCHITECTURAL, STRUCTURAL AND SERVICE CONSULTANT DOCUMENTATION TO ENSURE FULL CO-ORDINATION BETWEEN TRADES PRIOR TO WORK COMMENCEMENT. LARGE SCALE DRAWINGS SHALL TAKE PRECEDENCE OVER SMALLER SCALE DRAWINGS. CONTRACTOR SHALL CARRY OUT WORK IN CONFORMANCE WITH THE B.C.A./N.C.C. RELEVANT STANDARDS AND THE LOCAL AUTHORITY REQUIREMENTS. SEEK CLARIFICATION FROM SUPERINTENDENT FOR ANY DISCREPANCIES. ALL EXTERNAL FLOOR SURFACES TO FALL AWAY FROM BUILDING.
REFER INTERIOR DOCUMENTATION FOR SETOUTS AND EXACT LOCATIONS OF CABINETRY, FITTINGS, FIXTURES, PLUMBING, FLOOR WASTES AND TILING.
ALL MATERIALS SHALL BE NEW & COMFORM TO WHAT IS SHOWN

NOTES - DOORS, WINDOWS & GATES:

1. ELEVATIONS SHOWN ARE AS SEEN FROM EXTERNAL OR OUTSIDE OF THE DESIGNATED ROOM U.N.O.

2. REFER FLOOR PLANS FOR DOOR HANDING, TYPE OF WALLS RECEIVING

DOOR AND/OR WINDOW FRAMES.
REFER ELEVATIONS FOR HANDING AND POSITION OF WINDOWS.
REFER DOOR HARDWARE SCHEDULE (TBC) FOR LOCK AND HARDWARE.
REFER FINISHES SCHEDULE (TBC) FOR FINISHES. ALUM. DOOR/WINDOW SUITES SHALL BE CONCEAL FIXED (IE NO VISIBLE POP ALUM. DOORWINDOW SUITES SHALL BE CONCEAL FIXED (IE NO VISIBLE POP RIVETS, SCREWS AND THE LIKE).

SEEK SUPERINTENDENT'S INSTRUCTION FOR ANY DISCREPANCIES.

STEEL AND ALUMINIUM DOOR FRAMES SHALL BE FITTED WITH STIFFENING PLATES OF THE SAME FRAMING METRAIL TO LOCK, HINGE AND DOOR CLOSER

PLATES OF THE SAME FRAMING METRAIL TO LOCK, HINGE AND DOOR CLOSER FIXING POINTS.

STEEL DOOR FRAMES TO BE PROVIDED WITH CUTOUTS AND BACKPLATES TO SUIT SCHEDULED HINGES, PROVIDE INTEGRATED HINGES OTHERWISE. SUPPLY & INSTALL FLASHING TO ALL EXTERNAL OPENINGS. SUPPLY & INSTALL MATCHING COVER TRIMS, AS REQUIRED. DOOR HANDLES SHALL BE @1050 AFFL, U.N.O. FLOOR MOUNTED DOOR STOPS FOR ALL HINGED DOORS. EXTERIOR WINDOWS AND DOOR & WINDOW SUITES SHALL BE INSTALLED WITH SUBSILL, U.N.O., REBATE STRUCTURAL FLOOR BOARD AND/OR CONCRETE SLAB TO ACHIEVE TOP OF DOOR SILL FLUSH WITH INTERNAL FLOOR FINISH.

ALL EXTERIOR OPERABLE WINDOWS AND SLIDING DOORS TO BE FITTED WITH ALUMINIUM FRAMED BLACK INSECT MESH WITH MAX 2MM APERTURE, REMOVABLE FOR CLEANING, U.N.O. FRAME COLOUR TO MATCH ASSOCIATED WINDOW/DOOR ATTACHED.

WINDOW/DOOR ATTACHED.

ALL EXTERIOR OPERABLE WINDOWS, DOORS, FLYSCREEN DOORS AND GATES TO BE KEY LOCKABLE, U.N.O.
PROPRIETARY FRAME INTEGRATED PERIMETER SEALS TO HEAD, SILL/TRANSOM AND JAMBS OF EXTERIOR OPERABLE OPENINGS.
GLAZING TO COMPLY WITH RELEVANT AUSTRALIAN GLAZING STANDARDS AND CODES.
SUBMIT SHOP DRAWINGS TO SUPERINTENDENT FOR APPROVAL PRIOR TO COMMENCING FABRICATION OF DOORS, DOOR WINDOWS, WINDOWS, SKYLIGHTS, GATES, SCREENS & LOUVRES.
PROVIDE OPENING RESTRICTORS AS REQUIRED IN CONFORMANCE TO CODES AND STANDARDS.
PROVIDE VISUAL INDICATOR STRIPS AS REQUIRED IN CONFORMANCE TO CODES AND STANDARDS TO PUBLIC FACING GLAZING AND GLAZED DOORS.

CODES AND STANDARDS TO PUBLIC FACING GLAZING AND GLAZED DOORS

CASEMENT WINDOW
CAVITY SLDING DOOR
EXTERIOR
DOUBLE HUNG WINDOW

HINGED DOOR INTERIOR

ROLLER BLIND XX OPENING TYPE XX OPENING NUMBER

SYMBOL SHOWN ON FLOOR PLANS

FIXED PANE FLOOR LEVEL (AKA SL) WITHOUT FINISHES

MINIMUM PERFORMANCE REQUIREMENTS PER ESD REPORT.

GL01 6mm / 12mm / 6.38mm DOUBLE-GLAZED, CLEAR SYSTEM U-VALUE 3.9 SHGC 0.59

LOUVRE WINDOW (BREEZEWAY ALTAIR LOUVRE O.A.E.)
PIVOT DOOR

GLAZING TYPE SCHEDULE: GLAZING FOR WINDOWS AND DOORS SHALL BE MINIMUM GRADE "A" 4MM TOUGHENED SAFETY GLASS.

Architecture + Landscape

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CONTRACTOR TO CHECK ALL DIMENSIONS AND LEVELS ON SITE PREPARING ANY SHOP DRAWINGS. CAD FIGURE DIMENSIONS TAKE PRECEDENCE OVER MEASUREMENTS | Window Schedule 2 MANUALLY SCALED OFF DRAWINGS. LARGE SCALE DWGS TAKE PRECEDENCE OVER SMALLER SCALE REV RECIPIENT / REASON FOR ISSUE BY DWGS.

CANNING BEACH ROAD BEFORE COMMENCING ANY WORK OR LOT 1 65a+b CANNING BEACH ROAD APPLECROSS 6153

IFC PROGRESS DOCUMENTATION

Author DESIGNED THIS IS A CAD DRAWING Designed NOT AMEND MANUALLY DRAWN Checker CHECKED REDUCTION 30mm@A1 15mm@A3 DATE JUSTIN CARRIER DRAWING No. CLIENT PROJECT CAPA PROJECT GRF19 No. 2027 No.

REFER MASTER MATERIALS SCHEDULE FOR THE FOLLOWING AND MORE:

ON THE DRAWINGS AND IN THE SCHEDULES.

SAME AS ADJACENT MATERIAL U.N.O.

MASTER MATERIALS SCHEDULE FOR THE CONSTRUCTURE SURFACE FINISHES 16.4
FIXTURES & FITTINGS 16.5
WATERPROOFING SYSTEMS 16.6

MEASURED ON SITE.

COLUMN SETOUTS

BUILDING TAG XX-XX

SCALE

As indicated

THE CONTRACTOR SHALL CHECK & VERIFY ALL DIMENSIONS ON SITE, PRIOR TO THE COMMENCEMENT OF ANY BUILDING WORK. ALL WINDOW DIMENSIONS ARE NOMINAL AND ARE TO BE

ENSURE ALL STRUCTURAL STEEL COLUMNS WITHIN 3m OF SITE BOUNDARY TO BE FIRE PROTECTED TO CODES AND STANDARDS. INSTALL FLASHINGS, EDGE TRIMS AND APPROPRIATE SEASL AS REQUIRED TO ACHIEVE WEATHER TIGHTNESS. FINISH TO BE

THE CONTRACTOR SHALL VISIT THE SITE & NOTE ALL SITE CONDITIONS & ACCESS REQUIREMENTS.
REFER TO WALL TYPES PLANS FOR WALL SETOUTS. REFER SLAB SETOUT PLANS FOR SLAB AND STRUCTURAL

APPLIANCES TRIMS